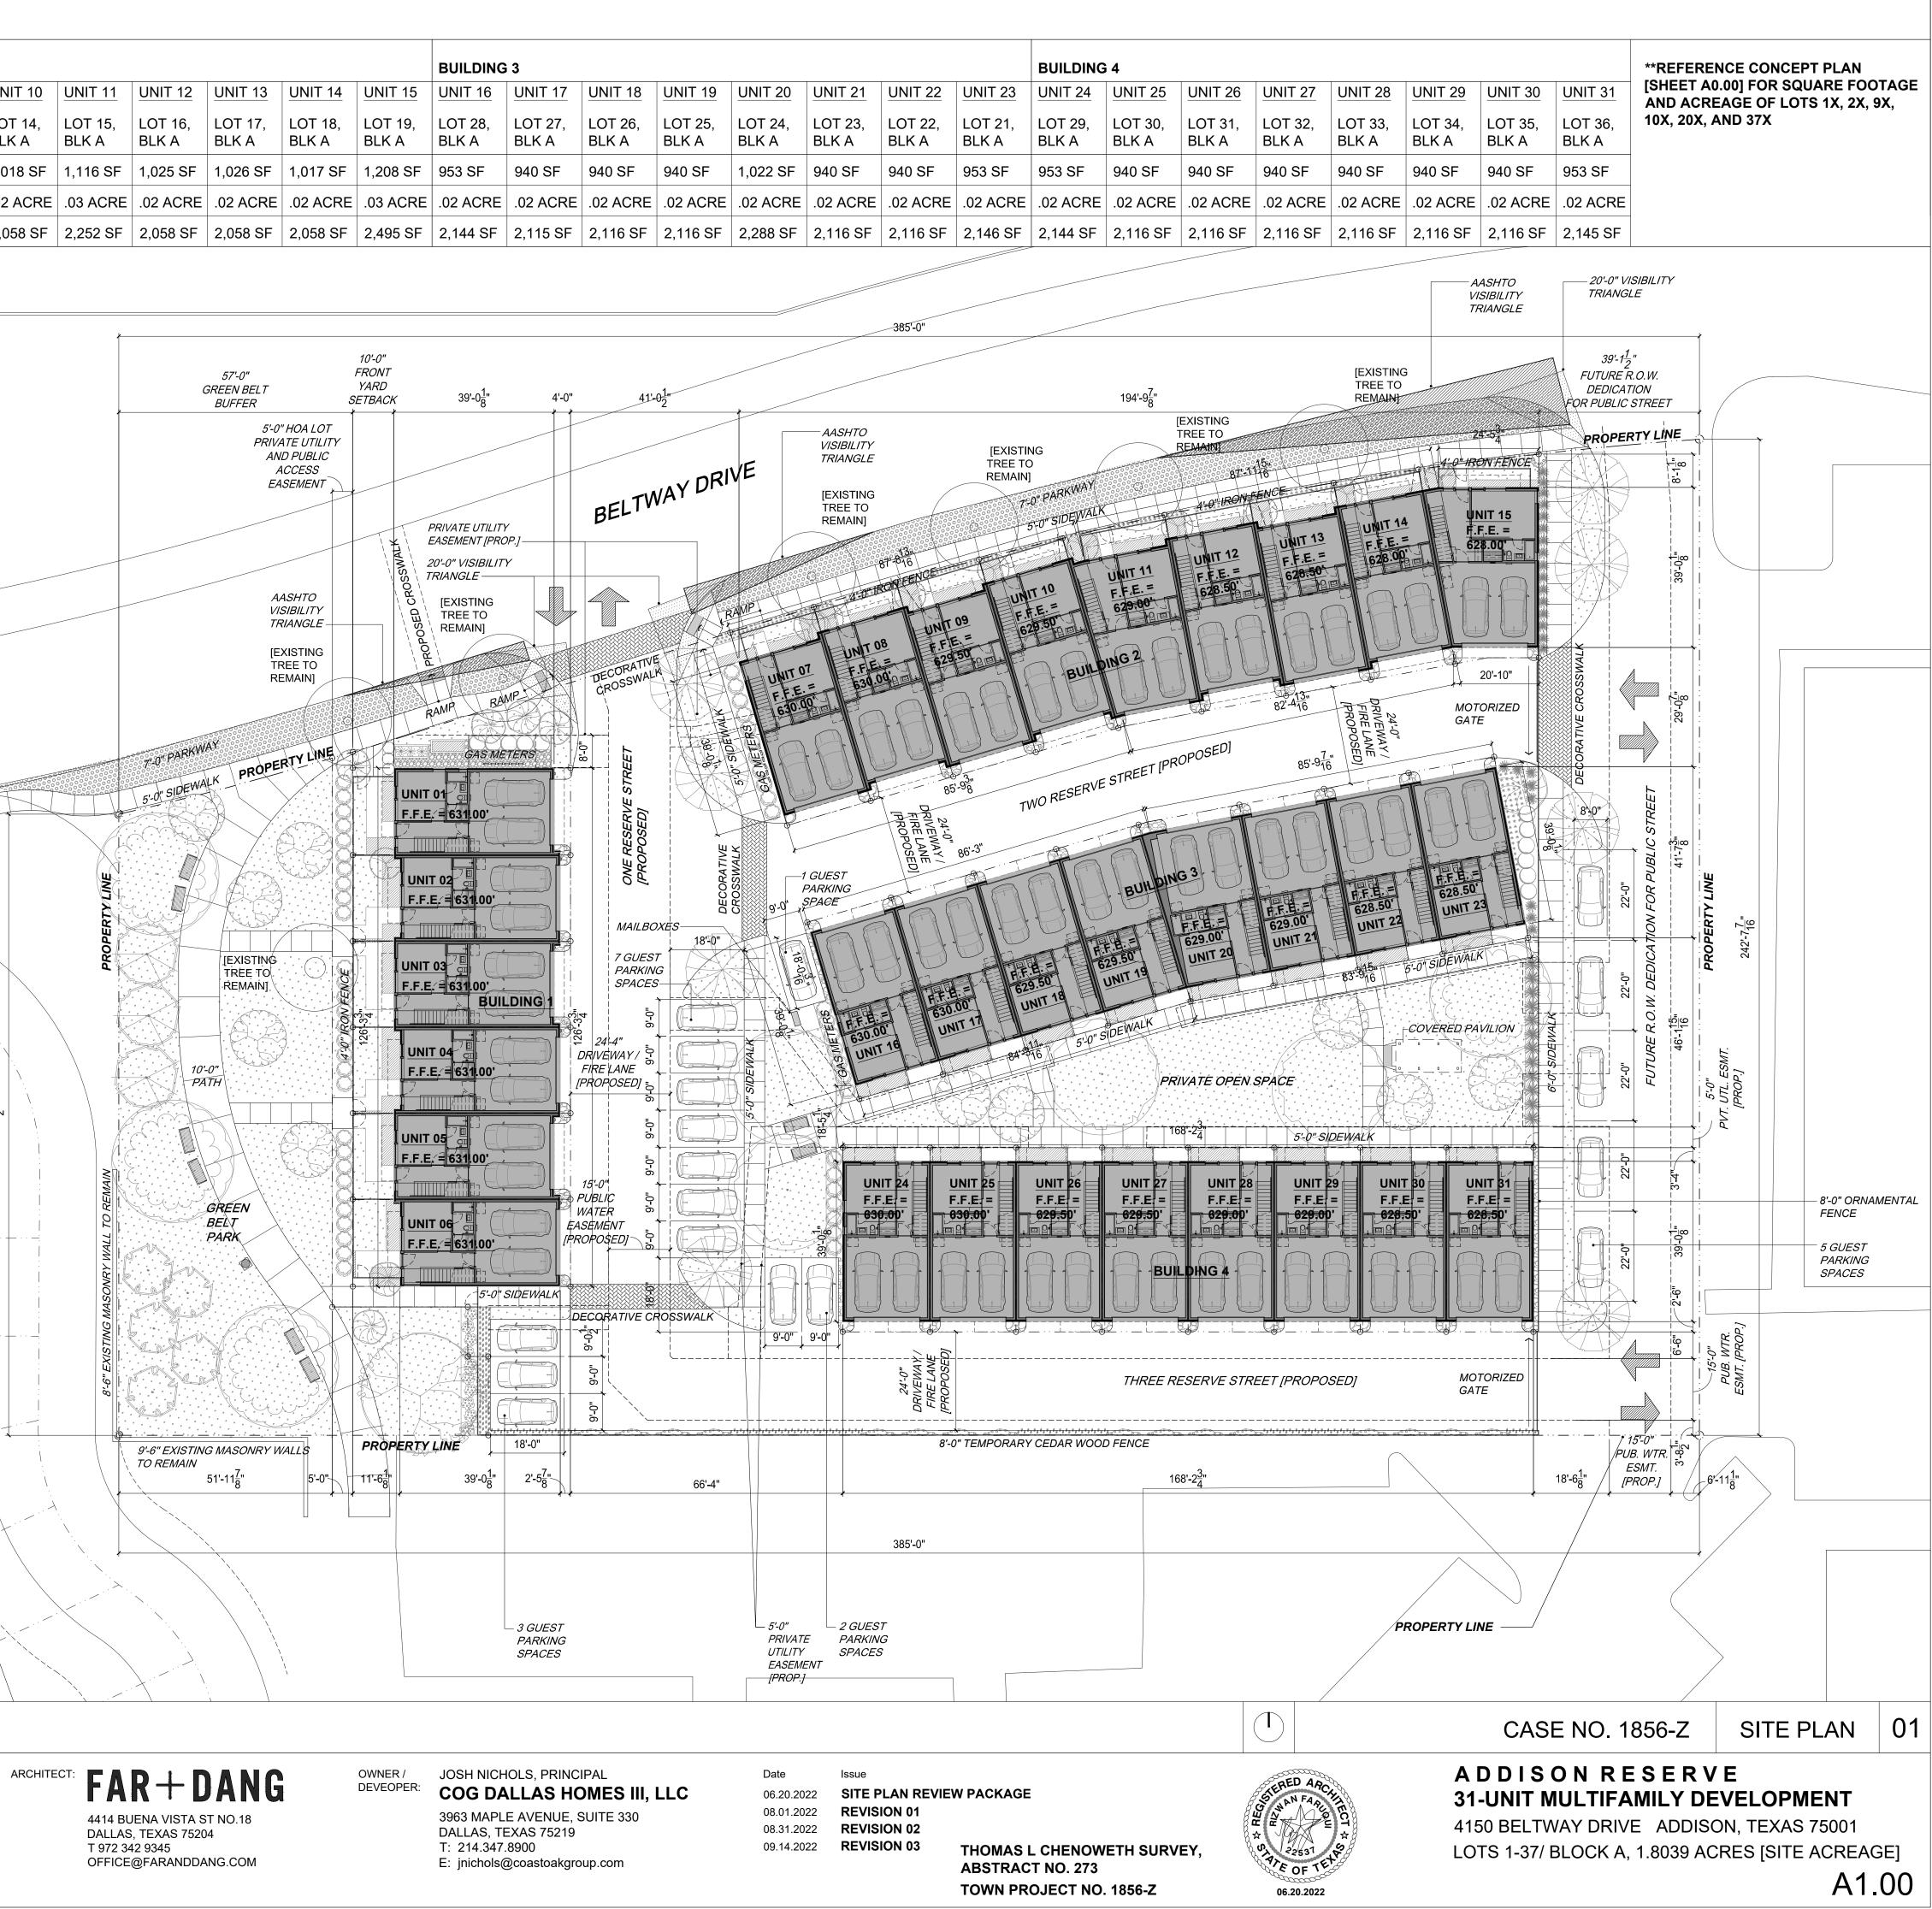
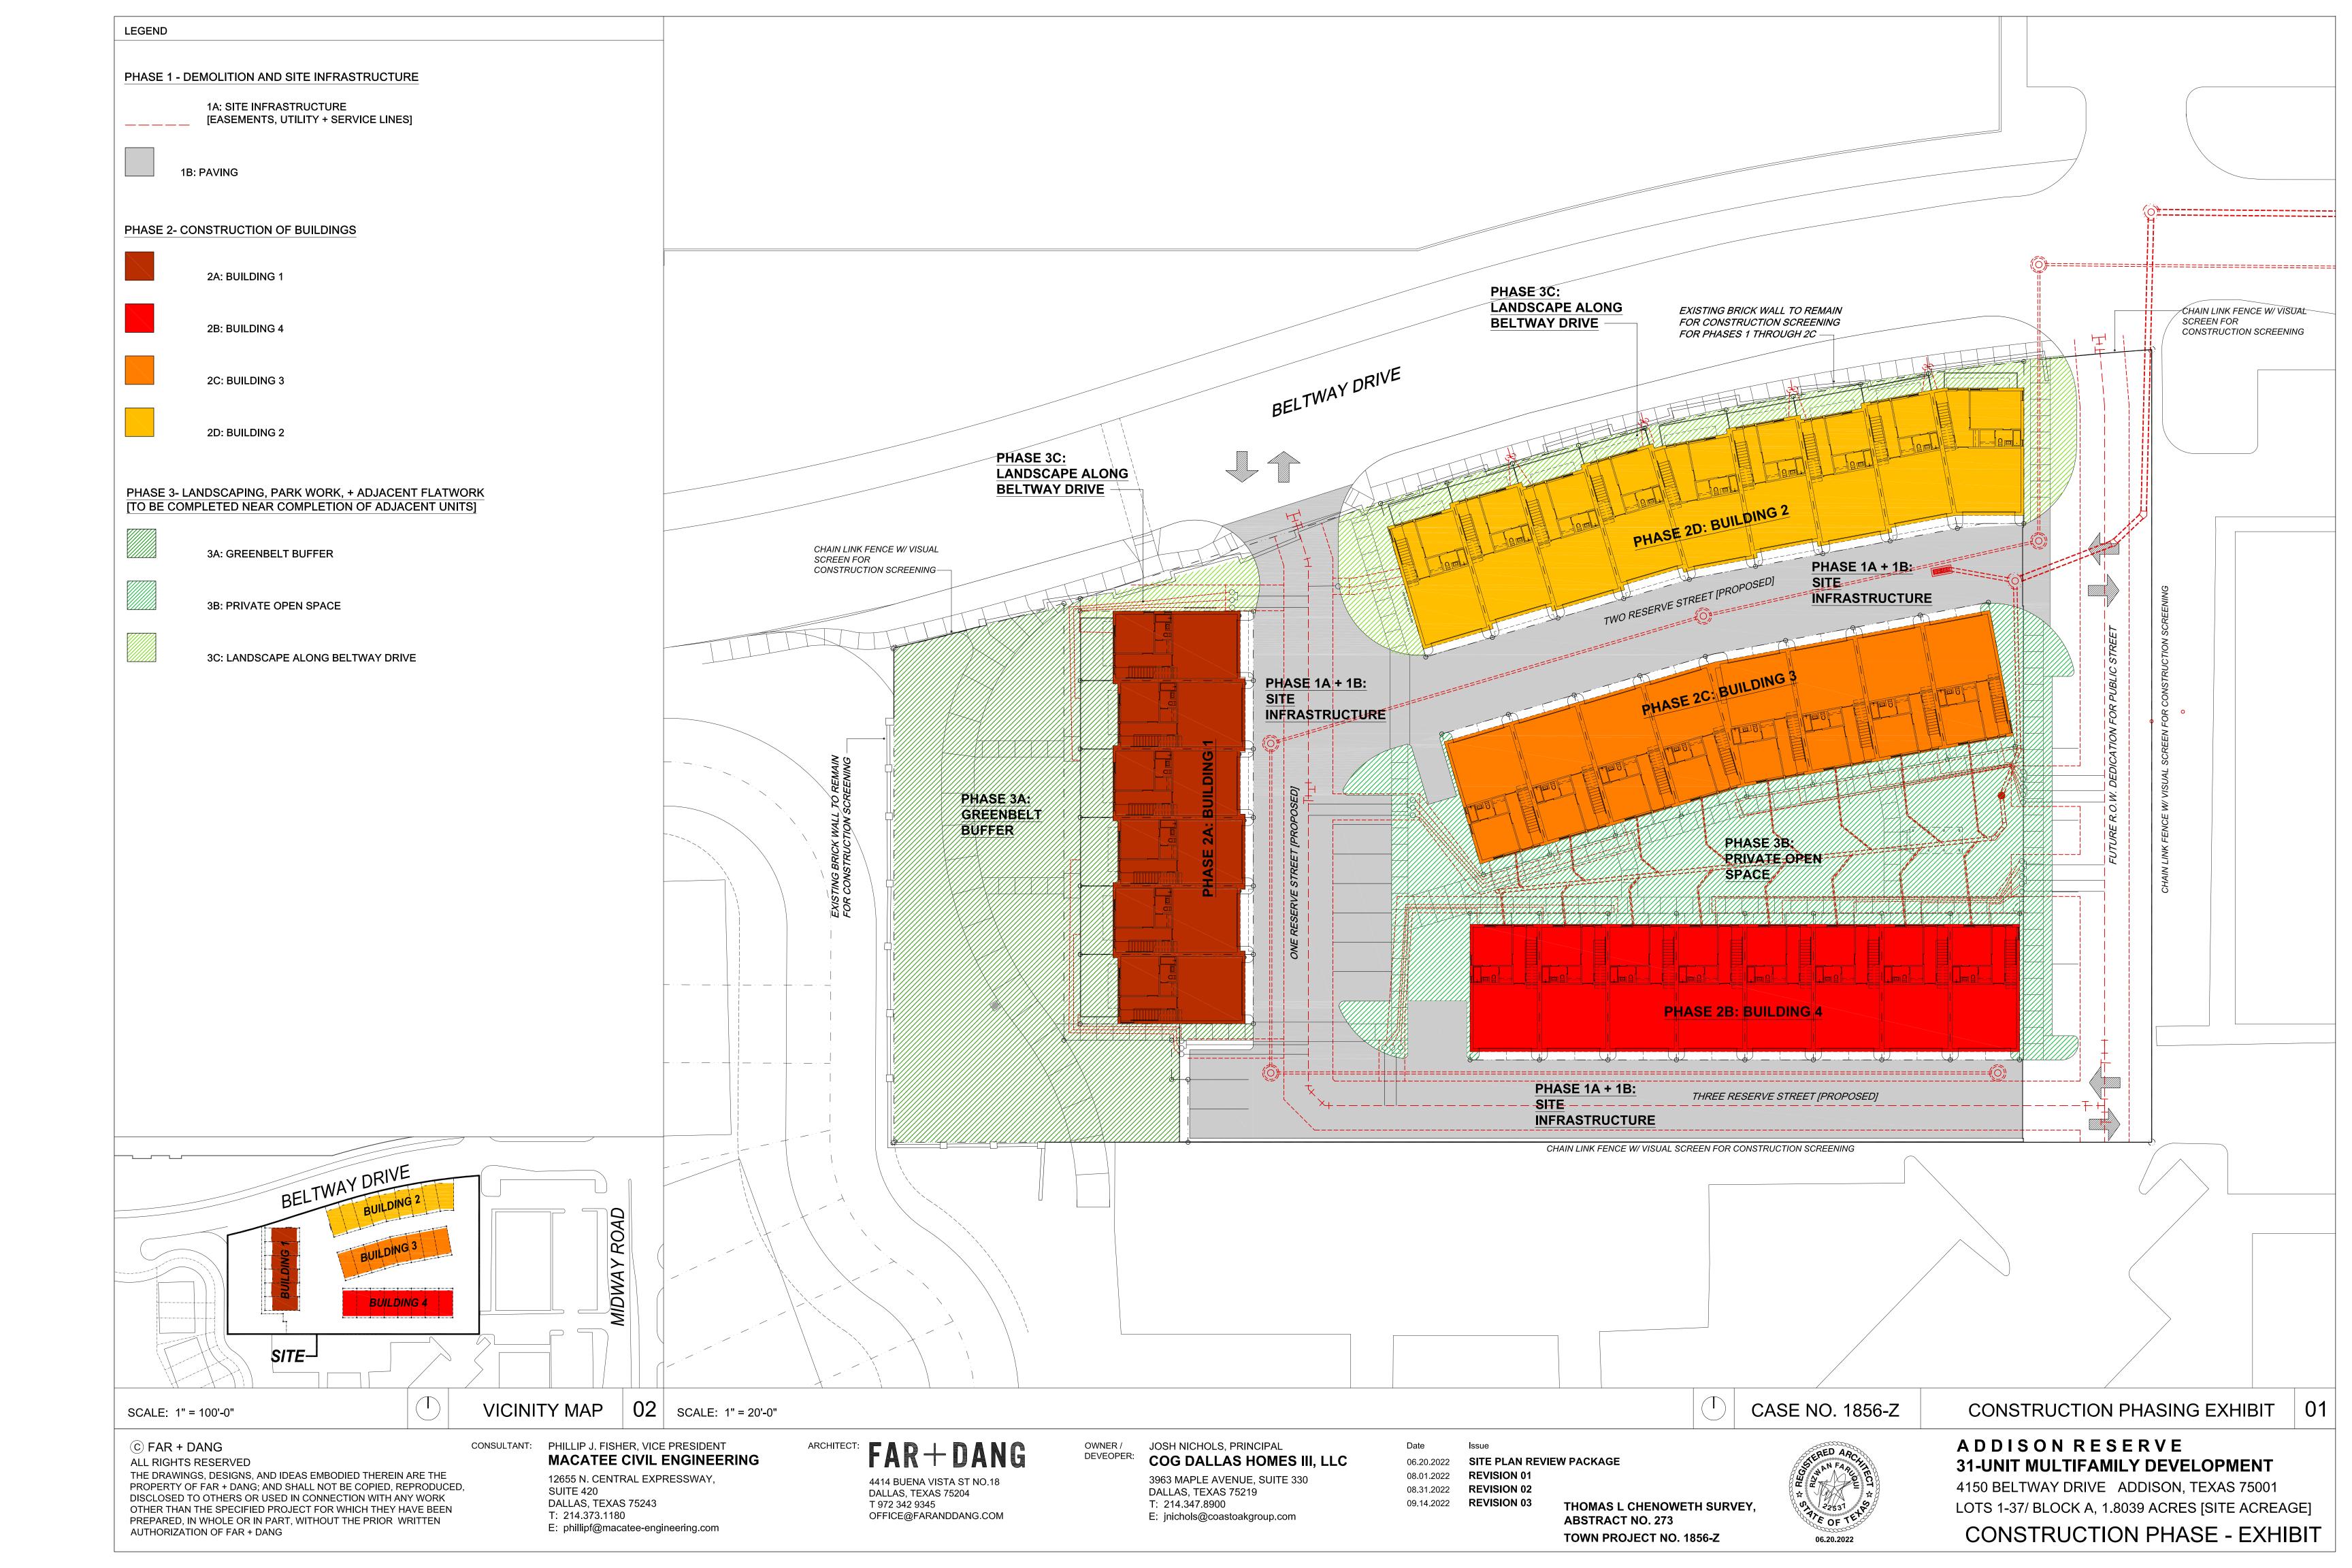
BUILDING LOT AREAS: BUILDING 1 BUILDING 2 UNIT 1 UNIT 3 UNIT 4 UNIT 5 UNIT 6 UNIT 7 UNIT 8 UNIT 9 UNIT UNIT 2 LOT 8, LOT 7, LOT 6, LOT 5, LOT 4, LOT 3, LOT 11, LOT 12, LOT 13, LOT BLK A BLK LOT AREA (SF) | 1,126 SF | 1,111 SF | 1,111 SF | 1,111 SF | 1,111 SF | 1,126 SF | 1,043 SF | 1,033 SF | 1,030 SF | 1,018 LOT AREA (ACRE) .03 ACRE | .02 A UNIT AREA (SF) 2,100 SF | 2,058 SF | 2,071 SF | 2,058 SF | 2,071 SF | 2,087 SF | 2,087 SF | 2,058 SF | 2,058 SF | 2,058 SF | 2,058 SITE PLAN INFORMATION ZONING: PD [PLANNED DEVELOPMENT DISTRICT] PD ORD. NO. 022-08, CASE #1856-Z SITE AREA: 1.8039 ACRES [78,564 SF] BUILDINGS: 4 TOTAL **PROPOSED USE TOWN HOMES DWELLING UNITS** 31 TOTAL NUMBER OF **BEDROOMS PER UNIT** 3 TOTAL MINIMUM SETBACKS FRONT YARD NONE NONE SIDE YARD REAR YARD NONE PERIMETER SETBACK 5'-0", FRONT YARDS FACING BELTWAY DRIVE PERIMETER SETBACK 10'-0", FRONT YARDS FACING GREENBELT PARK 65'-0", WESTERN BOUNDARY OF DEVELOPMENT PERIMETER SETBACK TO UNITS FACING GREENBELT BUFFER BUILDING GROSS SQUARE FOOTAGE AND HEIGHT: **BUILDING 1** 15,501 SF 41'-9 1/4" HIGH [3 LEVELS TOTAL] **BUILDING 2** 41'-9 1/4" HIGH [3 LEVELS TOTAL] 23,809 SF **BUILDING 3** 41'-9 1/4" HIGH [3 LEVELS TOTAL] 21,257 SF BUILDING 4 21,017 SF 41'-9 1/4" HIGH [3 LEVELS TOTAL] PARKING DATA: **TENANT PARKING** 2 TOTAL PER UNIT [2-CAR GARAGE] **GUEST PARKING** 0.5 PARKING SPACES / UNIT REQUIRED [15.5] **18 PROVIDED** OPEN SPACE AREA: **GREENBELT PARK DEDICATION** 9,330 SF GREENBELT PARK HOA EASEMENT 897 SF RESERVE PARK, PRIVATE OPEN SPACE 5,537 SF (INCLUDING SIDEWALKS & PAVILION) LANDSCAPE [EXCLUDING SIDEWALKS AND PAVILION 18,000 SF LANDSCAPE [INCLUDING SIDEWALKS AND PAVILION 19,270 SF TOTAL 19,270 SF 19,270 SF / 78,564 SF = 24.5% OF SITE IS LANDSCAPE 18,000 SF 18,00 SF / 78,564 SF = 23% OF SITE IS PERMEABLE SQUARE FOOTAGE OF IMPERVIOUS SURFACE: 32,230 SF SITE PLAN NOTES: ANY REVISION TO THIS PLAN WILL REQUIRE TOWN APPROVAL AND WILL REQUIRE REVISIONS TO ANY CORRESPONDING PLANS TO AVOID CONFLICTS BETWEEN PLANS. . OPEN STORAGE, WHERE PERMITTED, SHALL BE SCREENED IN ACCORDANCE WITH THE ZONING ORDINANCE BUILDINGS WITH AN AGGREGATE SUM OF 500 SQUARE FEET OR GREATER ON A LOT SHALL HAVE AUTOMATIC FIRE SPRINKLERS INSTALLED THROUGHOUT ALL STRUCTURES. ALTERNATIVE FIRE PROTECTION MEASURES MAY BE APPROVED BY THE FIRE DEPARTMENT. 4. ALL SIGNAGE IS SUBJECT TO TOWN APPROVAL 5. ALL FENCES AND RETAINING WALLS SHALL BE SHOWN ON THE SITE PLAN AND ARE SUBJECT TO BUILDING INSPECTION DIVISION APPROVAL. THIS PLAN CONFORMS WITH DESIGN STANDARDS INCLUDED IN THE TOWN OF ADDISON TRANSPORTATION PLAN, WATER SYSTEM REQUIREMENTS, WASTE WATER SYSTEM REQUIREMENTS, AND DRAINAGE CRITERIA MANUAL **REFERENCE LANDSCAPE PLAN FOR MORE INFORMATION REGARDING LANDSCAPE ELEMENTS BELTWAY DRIVE BUILDING 2 ROAI UDING 3 MIDWAY **BUILDING 4** SITE-02 VICINITY MAP SCALE: 1" = 20'-0" SCALE: 1" = 100'-0" © FAR + DANG CONSULTANT: PHILLIP J. FISHER, VICE PRESIDENT MACATEE CIVIL ENGINEERING ALL RIGHTS RESERVED THE DRAWINGS, DESIGNS, AND IDEAS EMBODIED THEREIN ARE THE 12655 N. CENTRAL EXPRESSWAY, PROPERTY OF FAR + DANG; AND SHALL NOT BE COPIED, REPRODUCED, SUITE 420 DISCLOSED TO OTHERS OR USED IN CONNECTION WITH ANY WORK DALLAS, TEXAS 75243 OTHER THAN THE SPECIFIED PROJECT FOR WHICH THEY HAVE BEEN T: 214.373.1180


PREPARED, IN WHOLE OR IN PART, WITHOUT THE PRIOR WRITTEN AUTHORIZATION OF FAR + DANG

E: phillipf@macatee-engineering.com


														1
						BUILDING	3							BL
T 10	<u>UNIT 11</u>	<u>UNIT 12</u>	<u>UNIT 13</u>	<u>UNIT 14</u>	UNIT 15	<u>UNIT 16</u>	<u>UNIT 17</u>	<u>UNIT 18</u>	<u>UNIT 19</u>	UNIT 20	<u>UNIT 21</u>	<u>UNIT 22</u>	<u>UNIT 23</u>	UN
Г 14, К А	LOT 15, BLK A	LOT 16, BLK A	LOT 17, BLK A	LOT 18, BLK A	LOT 19, BLK A	LOT 28, BLK A	LOT 27, BLK A	LOT 26, BLK A	LOT 25, BLK A	LOT 24, BLK A	LOT 23, BLK A	LOT 22, BLK A	LOT 21, BLK A	LO BL
18 SF	1,116 SF	1,025 SF	1,026 SF	1,017 SF	1,208 SF	953 SF	940 SF	940 SF	940 SF	1,022 SF	940 SF	940 SF	953 SF	95
ACRE	.03 ACRE	.02 ACRE	.02 ACRE	.02 ACRE	.03 ACRE	.02								
58 SF	2,252 SF	2,058 SF	2,058 SF	2,058 SF	2,495 SF	2,144 SF	2,115 SF	2,116 SF	2,116 SF	2,288 SF	2,116 SF	2,116 SF	2,146 SF	2,1
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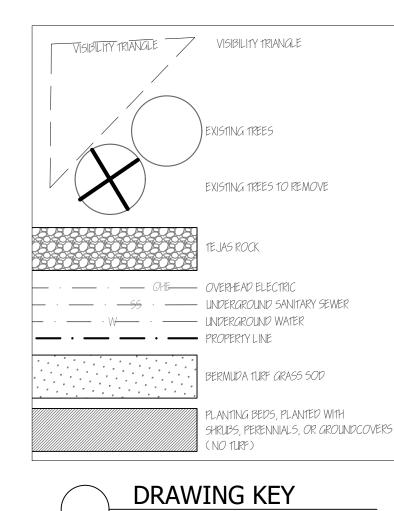


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T 10	<u>UNIT 11</u>	<u>UNIT 12</u>	<u>UNIT 13</u>	UNIT 14	UNIT 15	<u>UNIT 16</u>	<u>UNIT 17</u>	<u>UNIT 18</u>	UNIT 19	UNIT 20	<u>UNIT 21</u>	<u>UNIT 22</u>	<u>UNIT 23</u>	UN
⁻ 14, (A	LOT 15, BLK A	LOT 16, BLK A	LOT 17, BLK A	LOT 18, BLK A	LOT 19, BLK A	LOT 28, BLK A	LOT 27, BLK A	LOT 26, BLK A	LOT 25, BLK A	LOT 24, BLK A	LOT 23, BLK A	LOT 22, BLK A	LOT 21, BLK A	LO [.] BLł
8 SF	1,116 SF	1,025 SF	1,026 SF	1,017 SF	1,208 SF	953 SF	940 SF	940 SF	940 SF	1,022 SF	940 SF	940 SF	953 SF	953
ACRE	.03 ACRE	.02 ACRE	.02 ACRE	.02 ACRE	.03 ACRE	.02								
58 SF	2,252 SF	2,058 SF	2,058 SF	2,058 SF	2,495 SF	2,144 SF	2,115 SF	2,116 SF	2,116 SF	2,288 SF	2,116 SF	2,116 SF	2,146 SF	2,1
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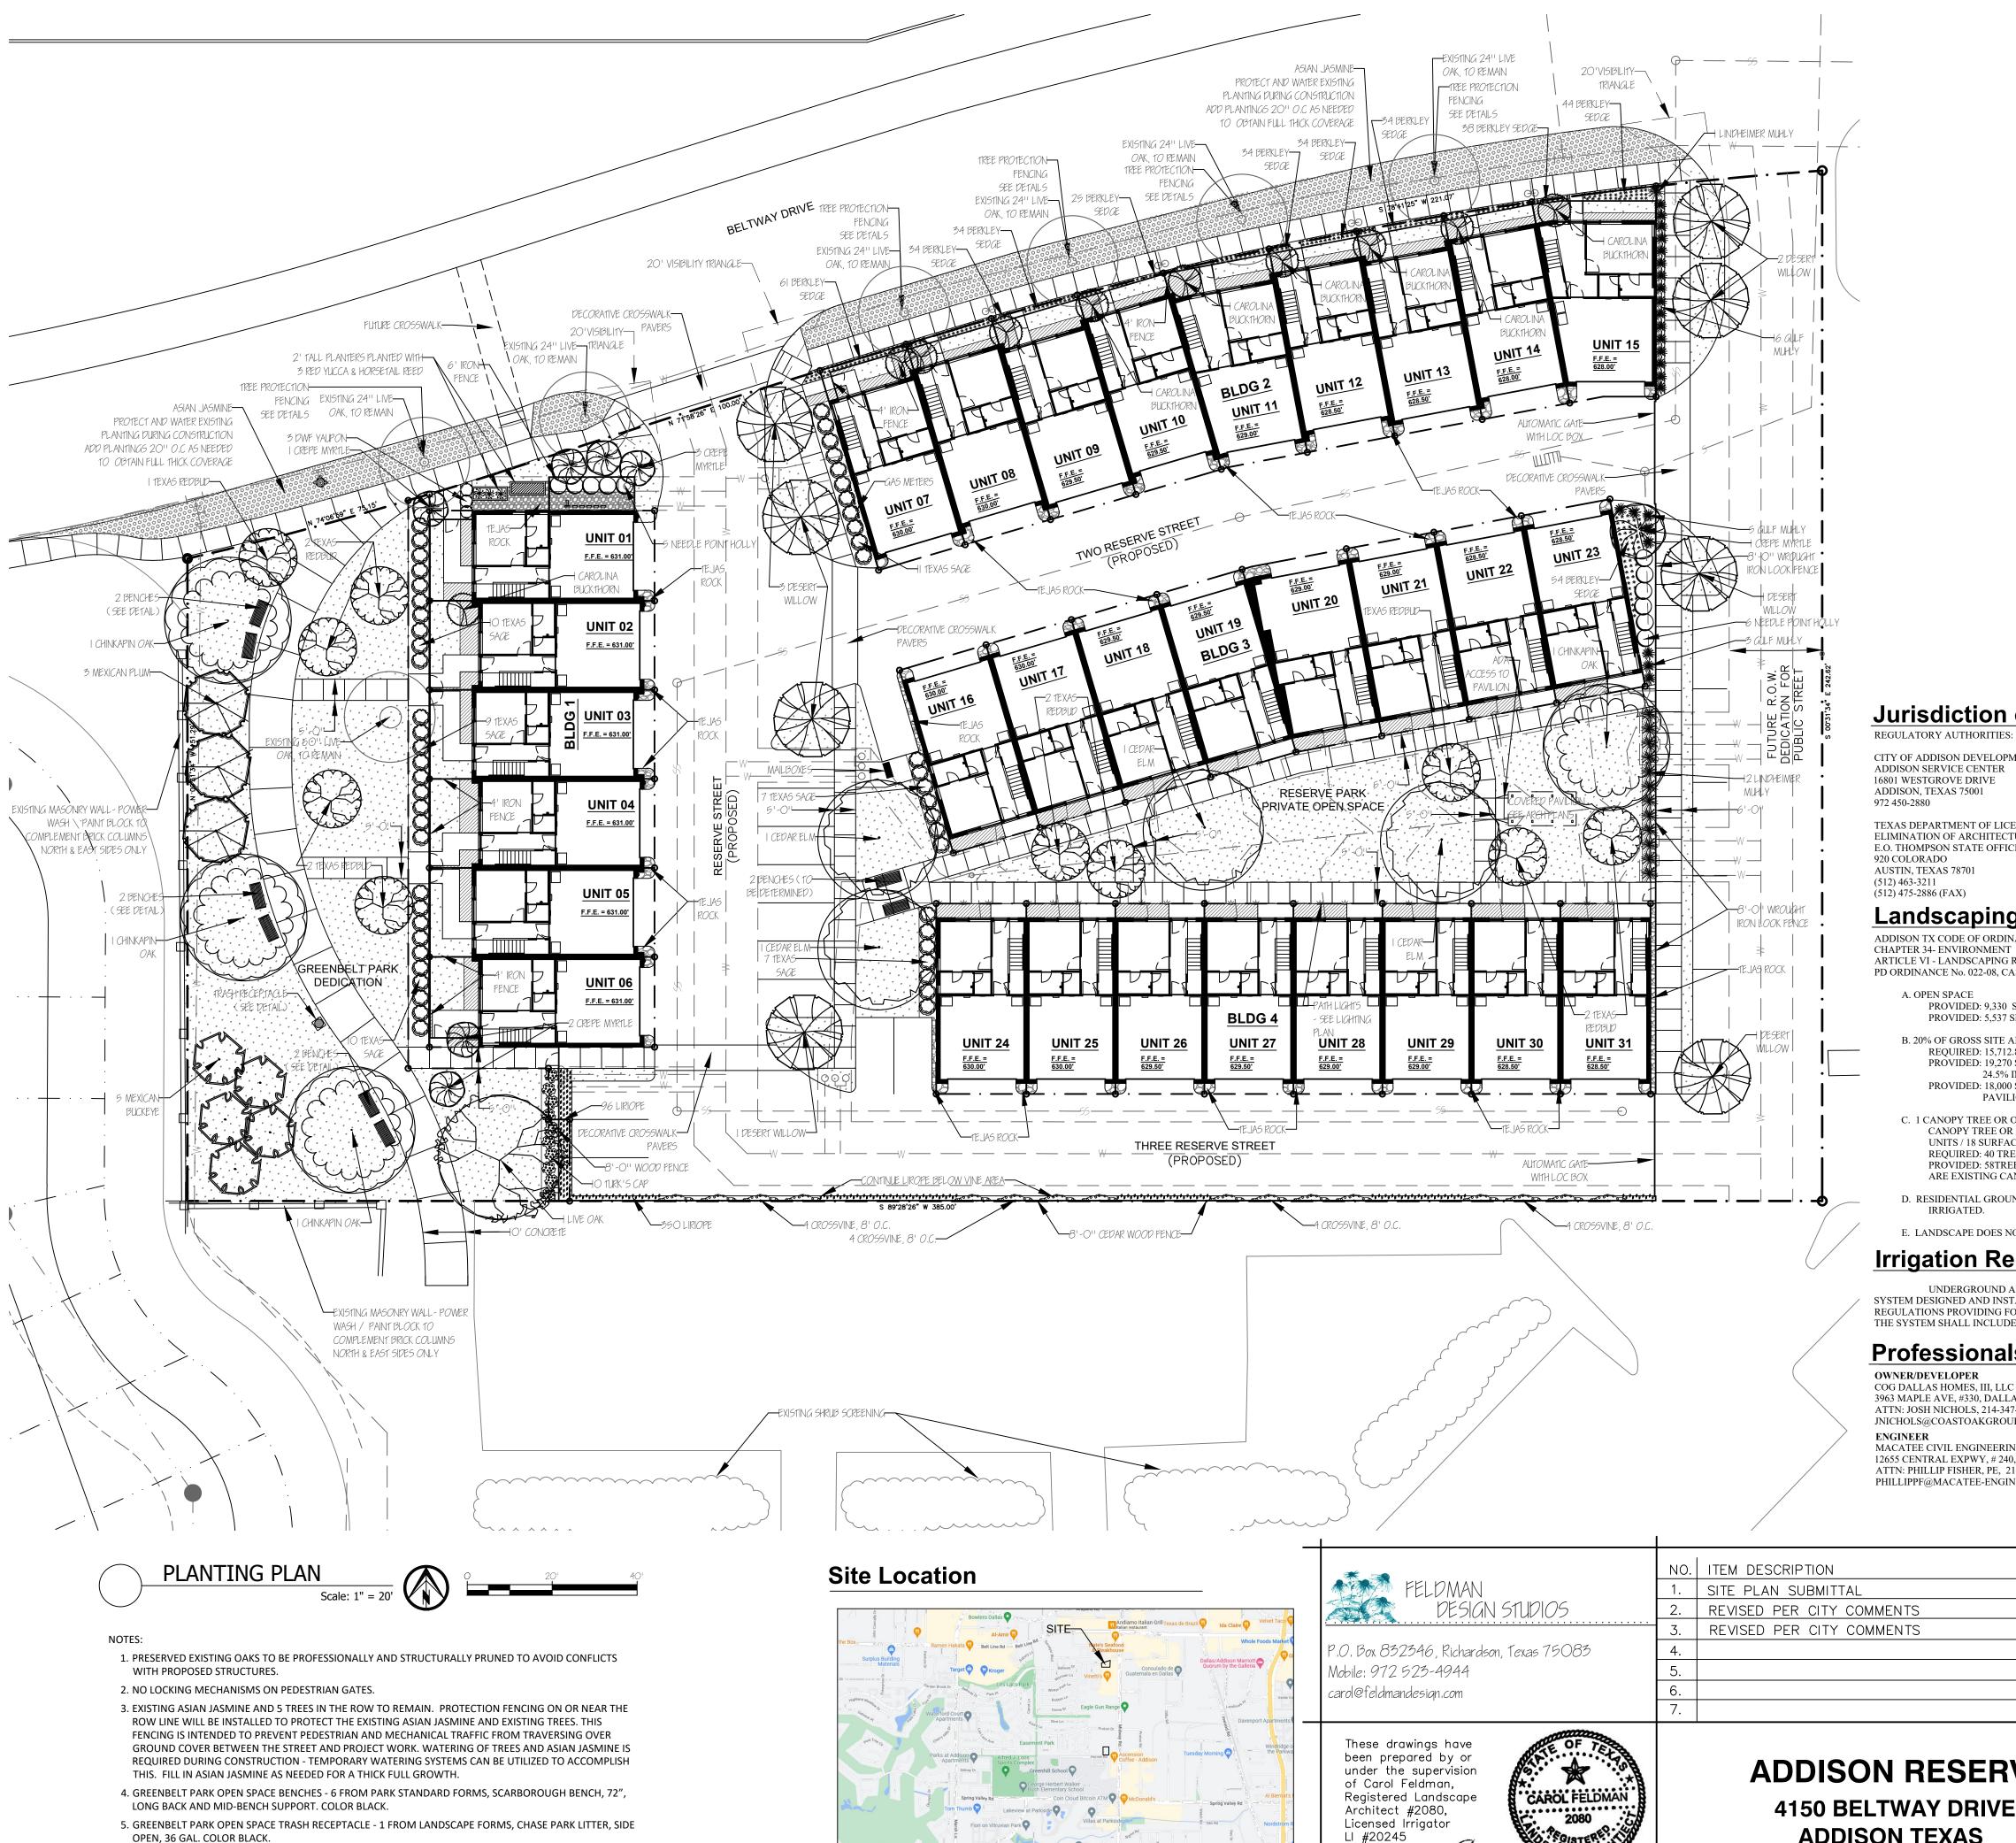


	Common Name	Botanical Name		Texas Native	Size	Qty	Remarks	Cumulated mitigation cal. inches
****	Berkley Sedge	Carex tumulicola	Groundcove	er	4" pots	388	full pots	
\bigcirc	Carolina Buckthorn	Rhamnus caroliniana	Small tree	Yes	15 gal	10	min. 8-10' in height	
\bigcirc	Cedar Elm	Ulmus crassifolia	Tree	Yes	6" cal	4	min 6" cal, 14-16' in height	24
	Chinkapin Oak	Quercus muhlenbergii	Tree	Yes	4" cal	4	min 6" cal, 14-16' in height	16
	Crepe Myrtle 'Country Red'	Lagerstroemia indica 'Country Red'	Small tree	No	15 gal	7	min 6-8' in height	
Q 0 0 0 0 0 0 0 0 0 0 0 0 0 0 0 0 0 0 0	Crossvine	Bignonia capreolata	Vine	Yes	3 gal	16	full pots	
	Desert Willow	Chiopsis lineraris	Tree	Yes	25 gal	8	min. 8-10' in height, min 2.5" cal	20
∞	Dwarf Yaupon Holly	Ilex vomitoria 'Nana'	Shrub	Yes	5 gal	3	full pots	
***	Gulf Muhly	Muhlenbergia capillaris	Grass	Yes	5 gal	24	full pots	
****	Lindheimer Muhly/Big Muhly	Muhlenbergia lindheimerii	Grass	Yes	5 gal	13	full pots	
	Liriope, Big Blue	Liriope muscari 'Big Blue'	Groundcove	No	4" pots	250	minl 8" o.c.	
	Live Oak	Quercus virginiana	Tree	Yes	4" cal	1	min 4" cal, 14-16' in height	4
	Needlepoint Holly	Ilex cornuta 'Needlepoint'	Shrub	No	5 gal	11	full pots	
\bigcirc	Mexican Buckeye	Ungnadia speciosa	Small tree	Yes	15 gal	5	min. 8-10' in height	
	Mexican Plum	Prunus mexicana	Small tree	Yes	35 gal	3	min. 8-10' in height, min 2.5" cal	7.5
****	Red Yucca	Hesperaloe parviflora	Shrub-like	Yes	5 gal	3	full pots	
	Texas Redbud	Cercis canadensis var. texensis 'Oklahoma'	Small tree	Yes	35 gal	10	min. 8-10' in height, min 2.5" cal	27.5
88	Texas Sage, Compact	Leucophyllum frutescens 'Compactum'	Shrub	Yes	5 gal	54	full pots	
***	Turk's Cap	Malvaviscus arboreus var. drumn	Perennial	Yes	1 gal	10	full pots	
	Tejas Rock	Black, 0.5"-1" size, 4" depth			sq ft	582		
	Bermuda grass sod	Tiff 419			sf	14,000		
	Asian Togning many design	Trachalonamum ari ti tur			of	2 605	Existing asian jasmine can be preserved. Must be protectd and watered during construction.Fill in with pays plotte as peeded	
<u>aoodoodoodoodoodoodoodoodoodoodoodoodood</u>	Asian Jasmine groundcover	Trachelopermum asiaticum			sf	2,695	with new plants as needed.	•
	Metal Edging	14 ga. black metal 4" size edging	with stakes		lin ft	735		
- 7 <u>~</u>	Path Lights	Refer to lighting plan	approx. ea			58	Tree mitigation cal	•

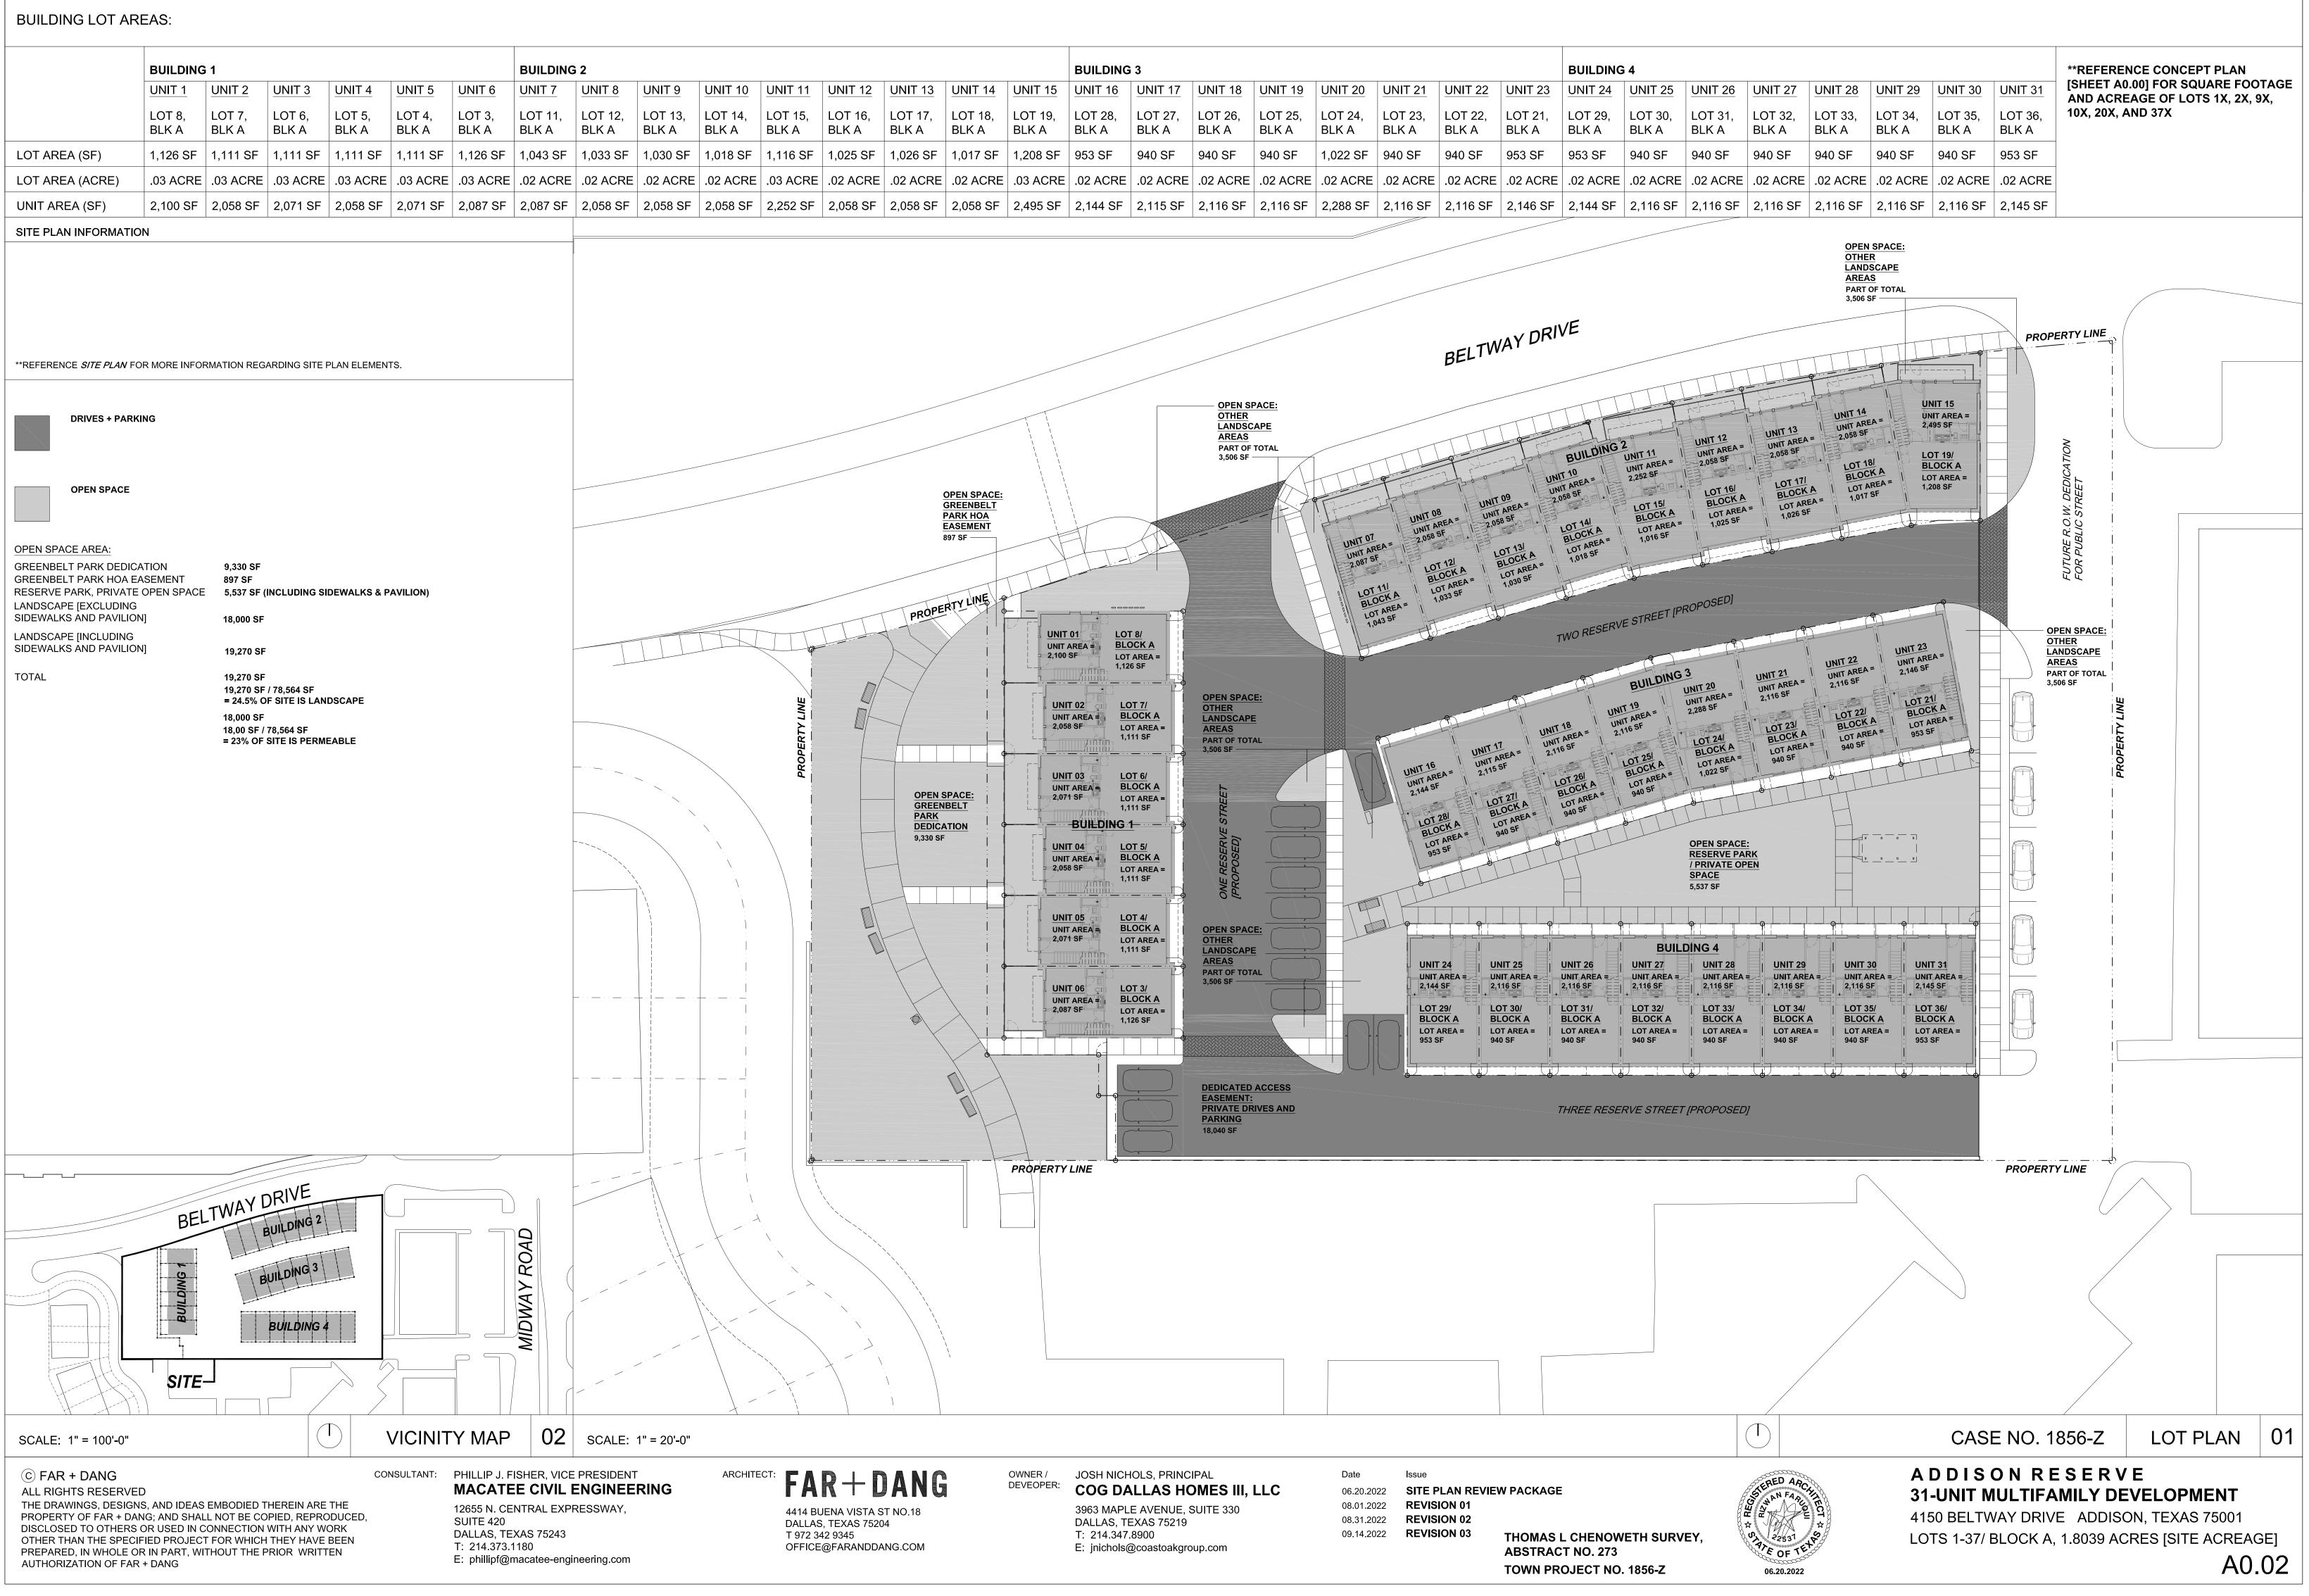PLANT & MATERIALS LIST

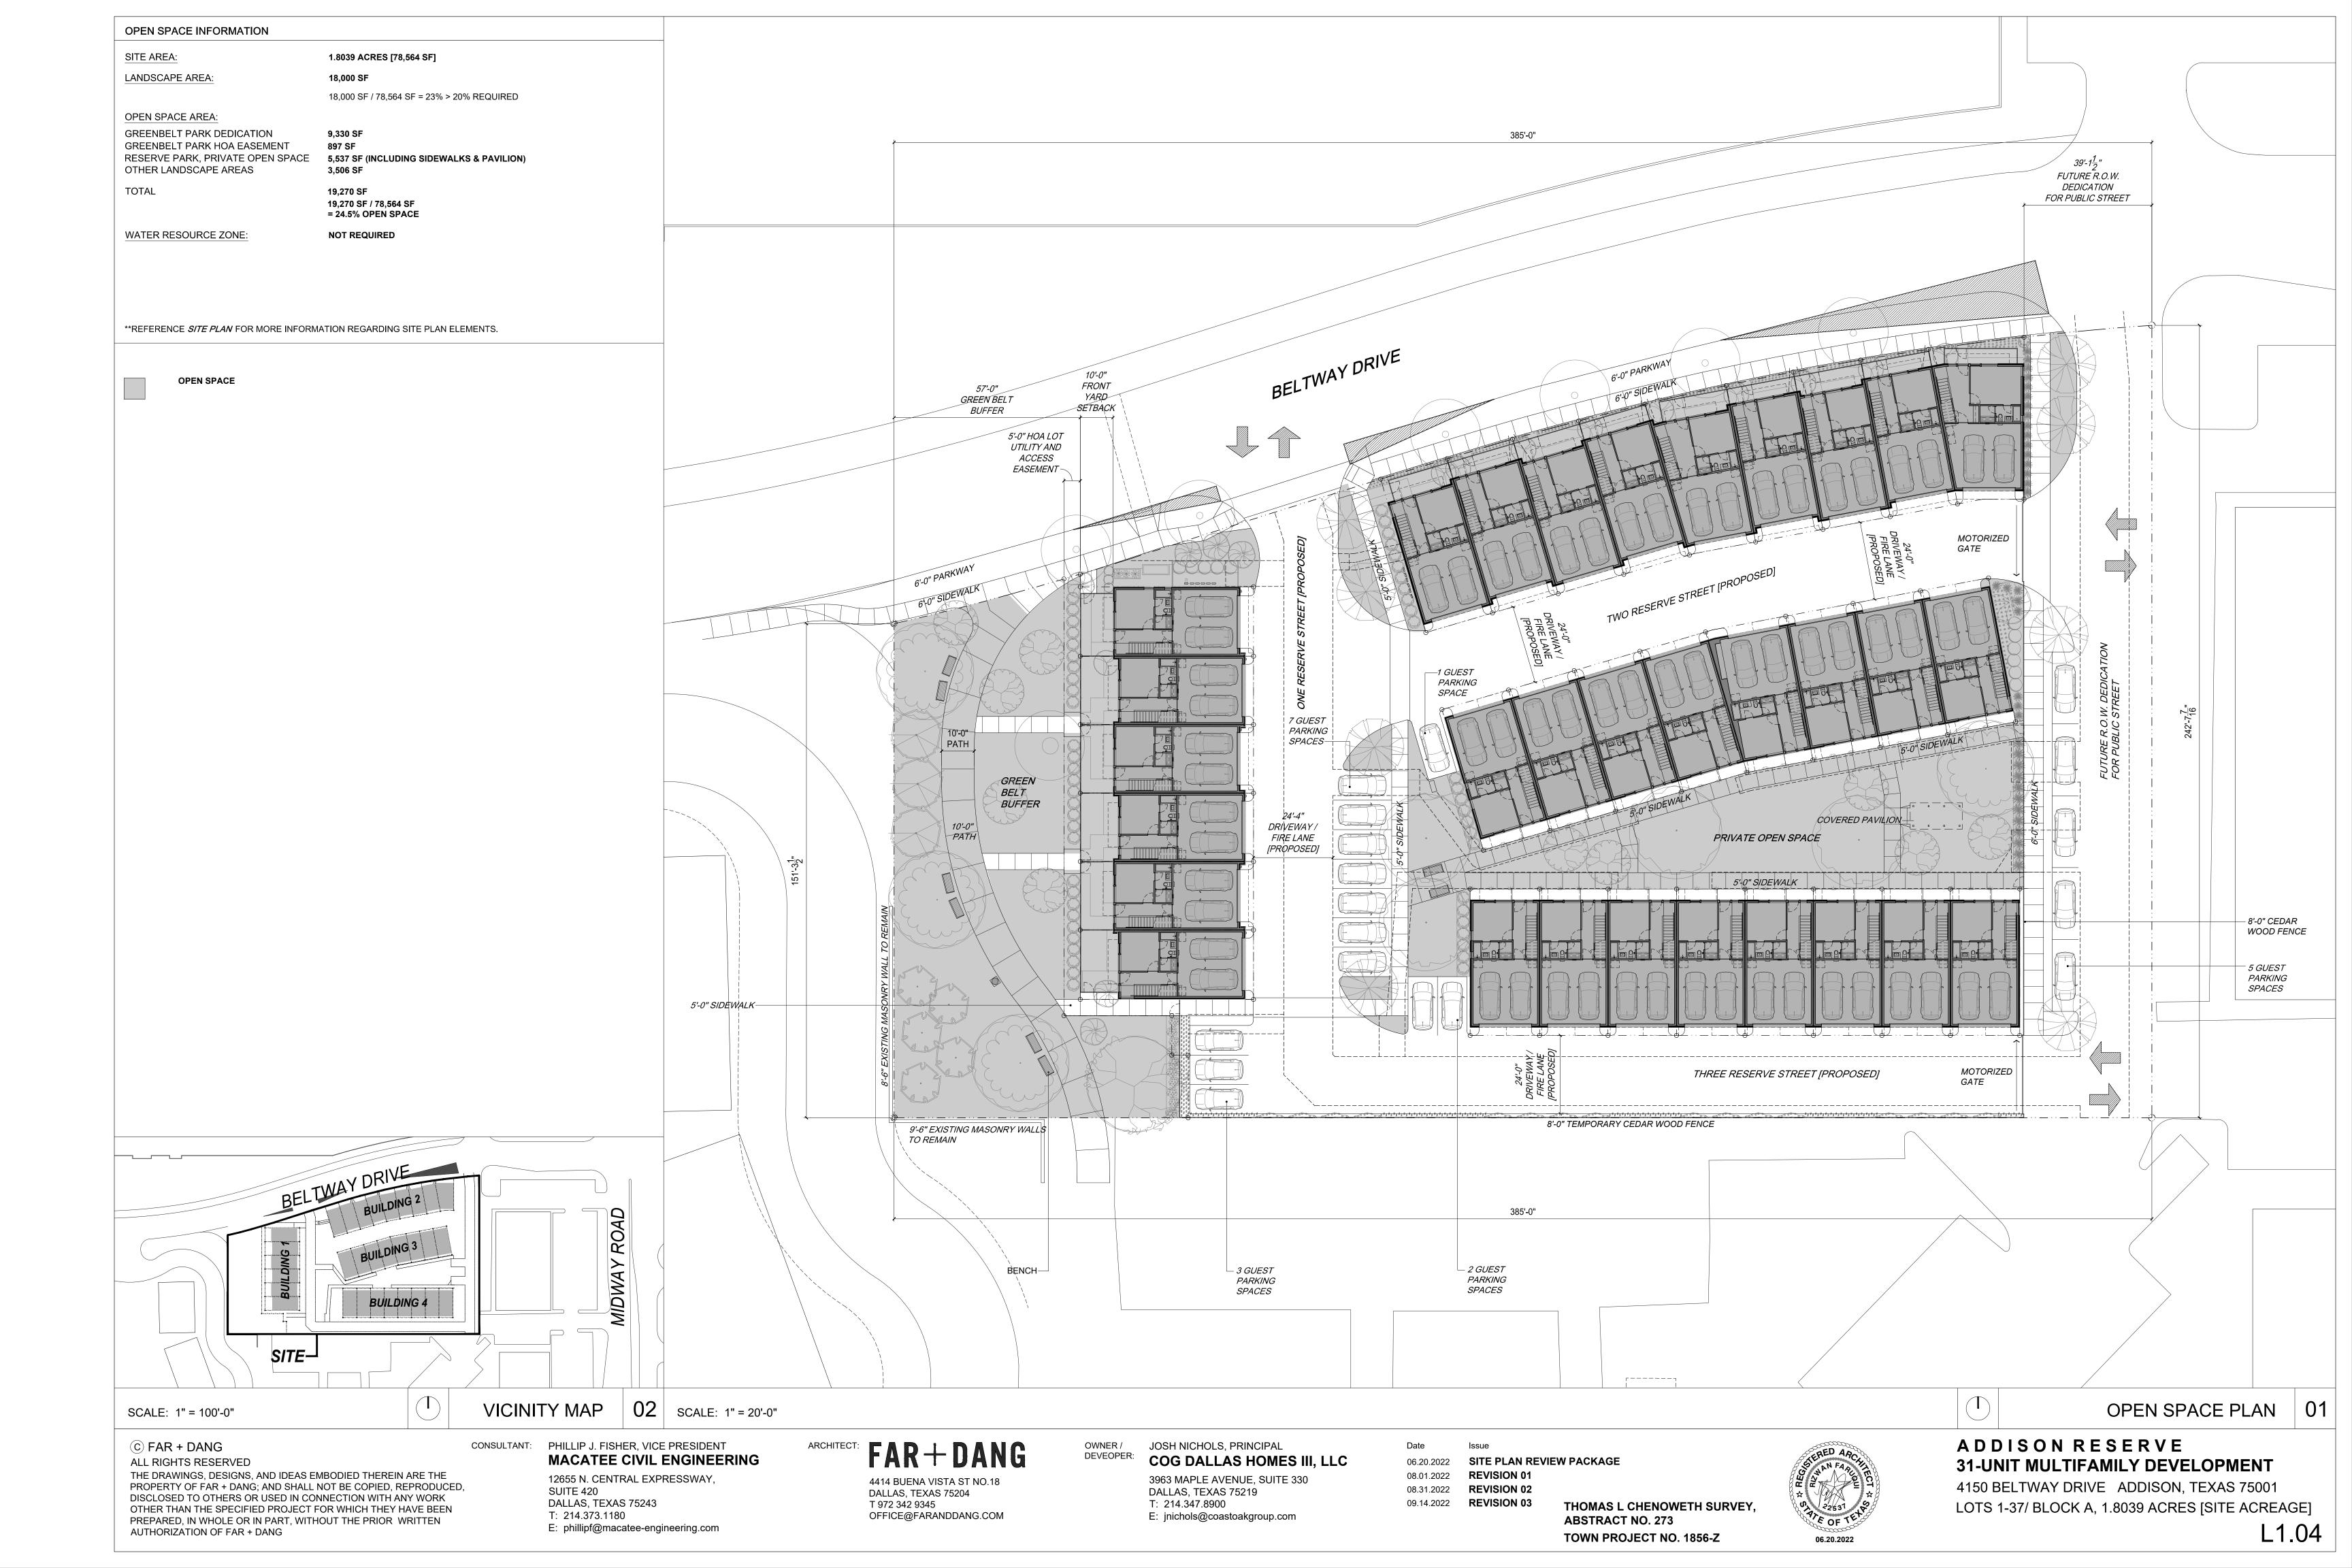

Inches provided 99



- OPEN, 36 GAL. COLOR BLACK.
- BRICK COLUMNS.

6. EXISTING MASONRY WALL ON WEST BOUNDARY TO BE POWERWASHED/PAINTED. COLOR TO COMPLEMENT

- Alpha Rd - =

Map data ©2022 1000 ft 📖

Jurisdiction of Project

CITY OF ADDISON DEVELOPMENT SERVICES ADDISON SERVICE CENTER

16801 WESTGROVE DRIVE ADDISON, TEXAS 75001 972 450-2880

TEXAS DEPARTMENT OF LICENSING AND REGULATION ELIMINATION OF ARCHITECTURAL BARRIERS E.O. THOMPSON STATE OFFICE BUILDING 920 COLORADO AUSTIN, TEXAS 78701

(512) 463-3211 (512) 475-2886 (FAX)

Landscaping Requirements

ADDISON TX CODE OF ORDINANCES CHAPTER 34- ENVIRONMENT

ARTICLE VI - LANDSCAPING REGULATIONS PD ORDINANCE No. 022-08, CASE#1856-Z

- A. OPEN SPACE PROVIDED: 9,330 SF GREENBELT PARK DEDICATION (PUBLIC SPACE) PROVIDED: 5,537 SF RESERVE PARK (PRIVATE OPEN SPACE)
- B. 20% OF GROSS SITE AREA IN LANDSCAPE (SITE: 1.8039 AC OR 78,564 SF) REQUIRED: 15,712.8 SF PROVIDED: 19,270 SF LANDSCAPE (INCLUDES SIDEWALKS & PAVILION) 24.5% IN LANDSCAPE PROVIDED: 18,000 SF PLANTING/GRAVEL (EXCLUDES SIDEWALKS & PAVILION) 23% OF SITE IS PERMEABLE SURFACES
- C. 1 CANOPY TREE OR ORNAMENTAL TREES PER DWELLING UNIT AND .5 CANOPY TREE OR ORNAMENTAL TREE PER SURFACE PARKING. 31 UNITS / 18 SURFACE SPACES REOUIRED: 40 TREES OF WHICH 9 ARE REOUIRED CANOPY TREES PROVIDED: 58TREES OF WHICH 9 ARE PROPOSED CANOPY TREES & 6
- ARE EXISTING CANOPY TREES D. RESIDENTIAL GROUND FLOOR FRONTAGES TO BE LANDSCAPED AND
- IRRIGATED. E. LANDSCAPE DOES NOT OBSTRUCT TRAFFIC VISIBILITY.

Irrigation Requirements

UNDERGROUND AUTOMATIC SPRINKLING SYSTEM PROVIDED. SYSTEM DESIGNED AND INSTALLED ACCORDING TO TCEQ LAWS AND REGULATIONS PROVIDING FOR 100% COVERAGE ON ALL LANDSCAPE AND TURF. THE SYSTEM SHALL INCLUDE A FREEZE-RAIN SENSOR.

Professionals Information

OWNER/DEVELOPER COG DALLAS HOMES, III, LLC 3963 MAPLE AVE, #330, DALLAS, TX

ATTN: JOSH NICHOLS, 214-347-8900 JNICHOLS@COASTOAKGROUP.COM

ARCHITECT FAR + DANG 4414 BIEMA VOSTA STREET. #18. DALLAS ATTN: BANG DANG, 972-342-9345,

ENGINEER MACATEE CIVIL ENGINEERING .

ATTN: PHILLIP FISHER, PE, 214-373-1180 ATTN: CAROL FELDMAN, 972-523-4944 PHILLIPPF@MACATEE-ENGINEERING.COM CAROL@FELDMANDESIGN.COM

BANG.DANG@FARANDDANG.COM LANDSCAPE ARCHITECT FELDMAN DESIGN STUDIOS


12655 CENTRAL EXPWY, # 240, DALLAS, TX. P.O. BOX 832346, RICHARDSON, TEXAS 75083

		1	1		—
	NO.	ITEM DESCRIPTION	DATE:		
-DMAN	1.	SITE PLAN SUBMITTAL	7.28.22		
DESIGN STUDIOS	2.	REVISED PER CITY COMMENTS	8.31.22		
	3.	REVISED PER CITY COMMENTS	9.10.22	LANDSCAPE	
6, Richardson, Texas 75083	4.			PLANTING	
-4944	5.			PLAN	
iqn.com	6.				
	7.				
gs have				SHEET NO.	
d by or pervision man, ndscape 880, ator CAROL FELDMAN 2080 Solution Solution CAROL FELDMAN 2080 Solution Solution Solution Solution Solution CAROL FELDMAN		ADDISON RESERVE 4150 BELTWAY DRIVE ADDISON TEXAS LOTS 1-37/BLOCK A		L1.01	



EXISTING TREE LIST


Provided caliper inches for mitigation (See L1.01) 99

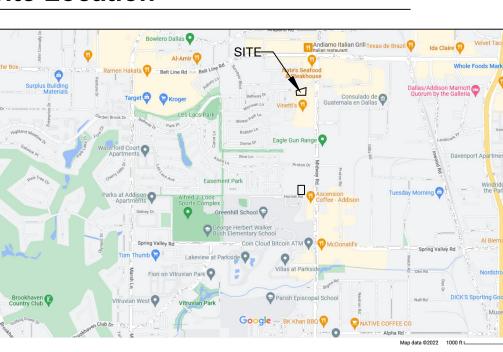

Mobile: 972 523carol@feldmandesid

> These drawings been prepared under the sup of Carol Feldm Registered Lan Architect #208 Licensed Irriga LI #20245

DMAN DESIGN STUDIOSNO.ITEM DESCRIPTIONDATE:1.SITE PLAN SUBMITTAL7.28.222.REVISED PER CITY COMMENTS8.31.223.3.4.6.5.5.6.7.7.7.	gs have d by or bervision man, ndscape 80, ator CAROL FELDMAN 2080 Carol FELDMAN CAPE ABC	ADDISON RESERVE 4150 BELTWAY DRIVE ADDISON TEXAS LOTS 1-37/BLOCK A	SHEET NO.
	DESIGN STUDIOS 5, Richardson, Texas 75083 -4944	2. REVISED PER CITY COMMENTS 8.31.22 3.	EXISTING
	DMAN		

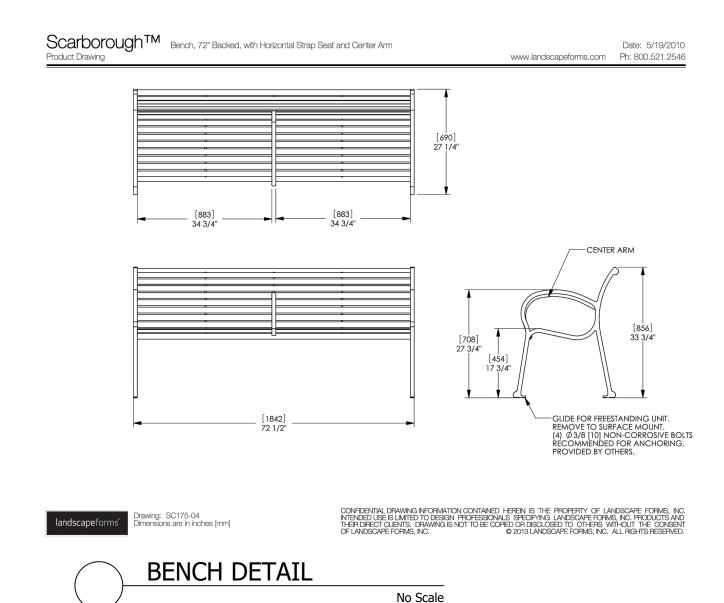

SECTION 02910 - SOIL PREPARATION PART 1 – GENERAL

- DESCRIPTION Α. 1. PROVIDE COMPLETE GRADING AND SOIL PREPARATION, INCLUDING AMENDMENTS, AS SPECIFIED HEREIN. EXAMINATION
- 1. EXAMINE SITE TO VERIFY REQUIRED ROUGH GRADING HAS BEEN COMPLETED CORRECTLY PRIOR TO BED PREPARATION WORK. 2. EXAMINE SITE TO VERIFY THAT ALL INVASIVE PLANTS AND THEIR ROOTS HAVE BEEN REMOVED PRIOR TO BED REPARATION WORK.

GREENBELT PARK OPEN SPACE BENCHES - 6 FROM PARK STANDARD FORMS,

SCARBOROUGH BENCH, 72", LONG BACK AND MID-BENCH SUPPORT. COLOR BLACK.

APPROVALS 1. ALL 'APPROVED EQUAL' MATERIALS MUST BE APPROVED BY LANDSCAPE ARCHITECT.

PART 2 - PRODUCTS A. MATERIALS

- 1. COMPOST:
- 1.1. COTTON BUR COMPOST 1.2. SHALL BE SUPPLIED BY: GREENSENSE COMPOST, GARLAND, TX. OR, CLEAR FORK MATERIALS, ALEDO, TX, OR APPROVED EQUAL.
- 2. FERTILIZERS AND SUPPLEMENTS: 2.1. A 6-2-4 GRANULAR FERTILIZER WITH A WATER SOLUBLE SLOW RELEASE ORGANIC BASE SUCH AS GREENSENSE, OR SUSTANE. OR APPROVED EQUAL.
- 3. MULCH 3.1. SHALL BE SHREDDED HARDWOOD MULCH, SHREDDED CEDAR MULCH, SHREDDED NATIVE MULCH, OR APPROVED EQUAL.
- PART 3 EXECUTION
- A. BED PREPARATION AND PREPARATION FOR SOD INSTALLATION 1. GENERAL
 - 1.1. INSPECT ALL EXISTING CONDITIONS AND OTHER ITEMS OF WORK PREVIOUSLY COMPLETED. DO NOT PROCEED UNTIL DEFECTS ARE
 - CORRECTED. 1.2. INSPECT THAT ALL INVASIVE PLANTS AND THEIR ROOTS HAVE BEEN
 - REMOVED COMPLETELY. 1.3. ALL AREAS TO BE PREPARED WITH ORGANIC TECHNIQUES ONLY.
- 2. SHRUB BEDS:
- 2.1. BREAK UP AND TILL EXISTING SOIL TO A DEPTH OF 6 INCHES, 2.2. ADD A 3 INCH LAYER OF COMPOST TO THE BEDS,
- 2.3. TILL EXISTING SOIL AND COMPOST TOGETHER TO A TOTAL OVERALL DEPTH OF 8 INCHES.
- 2.4. RAKE OUT ROCKS AND CLODS AND FINE GRADE THE BEDS TO DRAIN IN
- APPROPRIATE DIRECTIONS. 2.5. TOP-DRESS BED WITH A 3 INCH LAYER OF MULCH AFTER PLANTING.
- 3. SOD AND SEED AREAS 3.1. LIGHTLY CULTIVATE COMPACTED SOIL AND RAKE THE SOIL SMOOTH.
- 3.2. ADD ½ INCH COMPOST TO ALL AREAS. 3.3. FINE GRADE TO DRAIN IN APPROPRIATE DIRECTIONS.


END OF SECTION 02910

- NOTES GENERAL LANDSCAPE
- 1. LANDSCAPE CONTRACTOR IS RESPONSIBLE FOR LOCATING ALL UNDERGROUND UTILITIES AND STRUCTURES WHETHER OR NOT SHOWN ON THE PLANS, AND SHALL BE RESPONSIBLE FOR DAMAGE TO SAID UTILITIES OR STRUCTURES CAUSED BY HIS/HER CREW AND SUBCONTRACTORS.
- 2. NO PLANTING TO TAKE PLACE UNTIL OWNER HAS INSPECTED AND APPROVED THE BED PREPARATION.
- 3. NO PLANTING TO TAKE PLACE UNTIL OWNER HAS INSPECTED AND APPROVED ALL PLANT MATERIAL AND ALL PLANT PLACEMENT. FIELD ADJUSTMENTS OF PLANT LOCATIONS TO BE COORDINATED WITH OWNER.
- 4. ALL CANOPY AND ORNAMENTAL TREES TO BE STAKED (SEE DETAIL.)
- 5. ALL LAWN AND LANDSCAPE BED AREAS ARE TO BE SEPARATED BY 14 GAUGE EDGING UNLESS OTHERWISE NOTED ON THE PLANS.

SECTION 02915 - LANDSCAPE PLANTING PART 1 – GENERAL

- A. SPECIAL CONDITIONS 1.COMPLY WITH APPLICABLE FEDERAL, STATE, COUNTY AND LOCAL REGULATIONS GOVERNING LANDSCAPE MATERIALS AND WORK. PROVIDE ADEQUATE SUPERVISION BY A QUALIFIED FOREMAN WITH A MINIMUM OF TEN(10) YEARS EXPERIENCE WITH PROJECTS OF SIMILAR
- 2. EMPLOY ONLY EXPERIENCE PERSONNEL FAMILIAR WITH REQUIRED WORK. COMPLEXITY.
- 3.DO NOT MAKE SUBSTITUTIONS OF TREE, SHRUB AND GRASS MATERIALS. IF $\,$ B REQUIRED MATERIAL IS NOT OBTAINABLE, SUBMIT PROOF OF NON-AVAILABILITY TO OWNER'S REPRESENTATIVE.
- 4 PROVIDE QUANTITY SIZE GENUS SPECIES AND VARIETY OF IREES ANL SHRUBS INDICATED AND SCHEDULED FOR LANDSCAPE WORK WHICH COMPLY WITH APPLICABLE REQUIREMENTS OF ANSI Z60.1 "AMERICAN STANDARD FOR NURSERY STOCK", AND ANY APPLICABLE STATE AND
- FEDERAL LAWS CONCERNING DISEASE AND INSECT INFESTATION. B.REFERENCE STANDARDS 1. AMERICAN STANDARD FOR NURSERY STOCK, ANSI Z60.1, 2014 BY
- AMERICAN NATIONAL STANDARDS INSTITUTE, INC. 2. SHINNERS & MAHLER'S, ILLUSTRATED FLORA OF NORTH CENTRAL TEXAS, BOTANICAL RESEARCH INSTITUTE OF TEXAS (BRIT), FORT WORTH, TEXAS, 1999
- 3.HORTUS THIRD, CORNELL UNIVERSITY, 1967. C.PREPARATION
- 4. COORDINATION WITH BUILDING AND ENGINEERING PROJECT ACTIVITIES. 5. COORDINATE THE WORK OF THIS SECTION WITH THAT OF REGULAR AND EMERGENCY WATER UTILITY ACTIVITIES ON THE SITE.
- 6. COORDINATION WITH IRRIGATION SYSTEM:
- 6.1. THE UNDERGROUND IRRIGATION SYSTEM MUST BE INSTALLED PRIOR TO COMMENCEMENT OF THE PLANTING OPERATIONS.
- 6.2. THE IRRIGATION SYSTEM SHALL BE OPERATIONAL AT THE TIME THAT PLANTING OPERATIONS COMMENCE. 6.3. COORDINATE WORK WITH THE IRRIGATION CONTRACTOR TO PREVENT
- DAMAGE TO THE IRRIGATION SYSTEM. D.ALL PLANT MATERIALS FOR THIS PROJECT SHALL BE NURSERY-GROWN,
- INCLUDING TREES. 1. CONTAINER GROWN PLANTS SHALL HAVE BEEN "STEPPED-UP" AS NECESSARY TO PREVENT ROOT GIRDLING. 2. CONTAINER GROWN PLANTS SHALL HAVE BEEN IN THE CONTAINER FOR A
- MINIMUM OF SIX (6) MONTHS PRIOR TO DELIVERY TO THE SITE TO ENSURE ADEQUATE ROOT DEVELOPMENT. 3. THE 'ROOT FLARE' OF ALL TREES AND SHRUBS SHALL NOT BE COVERED
- WITH SOIL.
- THE BRANCH COLLAR INTACT. 2.DO NOT USE ANY TYPE OF PRUNING PAINT ON WOUNDS.
- 3.DO NOT USE ANY TYPE OF TREE WRAP, EXCEPT, TRUNKS MAY BE WRAPPED WITH BURLAP DURING PLANTING OPERATIONS ONLY.
- HAVE BEEN IN THE GROUND 6 MONTHS, AND BEFORE THE ONE YEAR ANNIVERSARY OF PLANTING. 5.DO NOT HANDLE ANY TREE BY ITS TRUNK. ANY TREE HANDLED IN SUCH A MANNER SHOULD BE REJECTED. F. WARRANTEE
- 1. UNCONDITIONALLY WARRANT ALL PLANTS FOR A PERIOD OF ONE (1) YEAR AFTER THE DATE OF INSTALLATION INITIAL ACCEPTANCE. REPLACE MATERIALS NOT IN VIGOROUS, THRIVING CONDITION AS SOON AS WEATHER PERMITS AFTER NOTIFICATION BY OWNERS THAT THE PLANTS HAVE DIED OR ARE OTHER WISE NOT ACCEPTABLE. GUARANTEE REPLACEMENT PLANTS FOR ONE YEAR, STARTING FROM THE DATE REPLACEMENT IS
- MADE 2.WARRANTY EXCLUDES REPLACEMENT OF PLANTS BECAUSE OF INJURY BY STORM, NATURAL DROUGHT, DROWNING, HAIL FOR FREEZING, IF REASONABLE CARE WAS TAKEN TO ADEQUATELY PROTECT THE MATERIAL, AND IN THE OPINION OF THE OWNER'S REPRESENTATIVE THAT THE PROBLEM OCCURRED AFTER THE DATE OF INITIAL ACCEPTANCE.



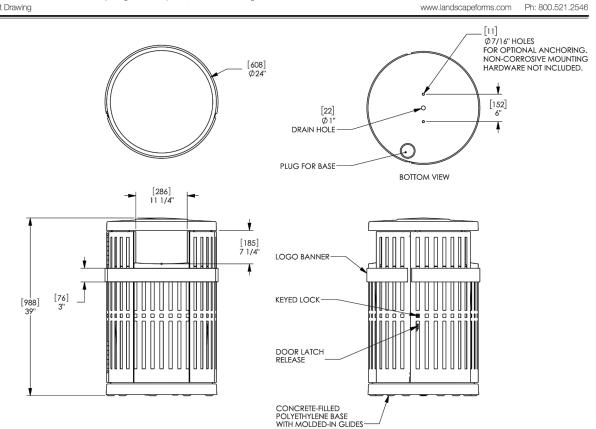

wing: CP362-06 iensions are in inches [mm]

TRASH RECEPTACLE DETAIL

No Scale GREENBELT PARK OPEN SPACE TRASH RECEPTACLE - 1 FROM LANDSCAPE FORMS, CHASE PARK LITTER, SIDE OPEN, 36 GAL. COLOR BLACK.

Date: 8/22/2019

- E. THE FOLLOWING TREE CARE PROCEDURES SHALL BE ADHERED TO:
- 1. DO NOT MAKE FLUSH CUTS OR LEAVE STUBS WHEN PRUNING. LEAVE
- 4. STAKE AND GUY ANY TREES AS PER DETAIL. THE CONTRACTOR WILL BE RESPONSIBLE FOR THE REMOVAL OF STAKES AND GUYS AFTER TREES

- PART 3 EXECUTION PREPARATION FOR PLANT MATERIAL INSTALLATION Α. 1. EXAMINE THE SUB-GRADE UPON WHICH THE WORK IS TO BE PERFORMED, VERIFY GRADE ELEVATIONS AND VERIFY THAT BEDS HAVE BEEN LEFT LOW BY OTHER TRADES. OBSERVE THE CONDITIONS UNDER WHICH THE WORK IS TO BE PERFORMED AND CONFIRM THAT UNSATISFACTORY CONDITIONS HAVE BEEN CORRECTED PRIOR TO PROCEEDING.
- TIME OF PLANTING
- CARE IS TO BE TAKEN SO THAT NO PLANTS SIT IN POTS IN THE SUMMER HEAT FOR MORE THAN 1 HOUR. IF PLANTING DURING HOT SEASONS (NOT PREERRED) PLANTING IS SECTIONS WITH STOCKPILED PLANTS TO BE PROTECTED FROM THE SUMMER HEAT (SHADE AREAS). TREE PLANTING С.
- 1. STAKE LOCATIONS FOR TREES PRIOR TO DIGGING HOLES.
- 2. DIG PITS WITH ROUGH SIDES AND WHICH HAVE TAPERED WALLS. A MINIMUM OF TWICE THE WIDTH OF THE TREE BALL. A PEDESTAL SHOULD BE LEFT IN THE CENTER OF THE HOLE AND THE TREE BALL SET UPON THAT PEDESTAL 3. SET PLANTS IN THE CENTER OF THE HOLE AND ON THE PEDESTAL,
- PLUM AND VERTICAL, AND AT SUCH A DEPTH THAT THE CROWN OF THE TREE BALL WILL BE LEVEL WITH THE SURROUNDING GRADE. 4. ALL PLANTS SHALL BE SET TO MEET THE SAME RELATIONSHIP TO THE FINISHED GRADE OF THE SURROUNDING SOIL THAT THEY BORE TO PREVIOUS EXISTING GRADE OF SOIL.
- 5. BACKFILL WITH EXISTING TOPSOIL AND WATER IMMEDIATELY.
- 6. FORM A SHALLOW BASIN SLIGHTLY LARGER THAN THE PIT TO FACILITATE
- WATERING. REMOVE PRIOR TO MULCHING. 7. COVER ALL TREE BALLS WITH A MINIMUM OF 3" OF SPECIFIED MULCH. EXTEND MULCH OUT TO THE EDGE OF THE TREE PIT, BUT KEEP AWAY
- FROM TRUNKS. 8. ALL EXCAVATED MATERIAL UNACCEPTABLE FOR REUSE SHALL BE DISPOSED OF OFF SITE, OR AS DIRECTED BY THE OWNER.
- SHRUBS, TALL GRASSES AND PERENNIAL PLANTING.
- 1. REMOVE CONTAINER AND SET PLANT MATERIAL AT SUCH A LEVEL THAT AFTER SETTLEMENT, THE CROWN OF THE BALL WILL BE AT FINISHED GRADE.
- 2. GENTLY CUT OUTER ROOTS OF ANY ROOTBALLS THAT HAVE "POT-BOUND" PRIOR TO INSTALLATION. 3. COVER PLANTING BEDS WITH A MINIMUM 3" LAYER OF SPECIFIED MULCH.
- SOD PLANTING I. LAY SOD IN AN ORDERLY MANNER TO COVER ALL BARE SOIL AREAS.
- WATER ALL AREAS OF THE SOD UNTIL THOROUGHLY WET. 3. ROLL SOD WITH A SOD ROLLER AFTER 24 HOURS AFTER LAYING AND WATERING SOD TO OBTAIN A UNIFORM, SMOOTH FINISH.
- 4. FILL JOINTS WITH COMPOST IF NECESSARY TO FORM A UNIFORM GRASS LAYER
- 5. KEEP SOD ADEQUATELY WATERED UNTIL SOD MAKES A FIRM CONNECTION TO THE SOIL. SEED PLANTING
- 1. AREAS SHALL BE RAKED TO A DEPTH OF $\frac{1}{2}$ ", Smooth and free of STONES AND DEBRIS.
- APPLY SEED EVENLY AT THE RATE RECOMMENDED. 3. RAKE AND WATER TO ESTABLISH A FIRM CONNECTION OF THE SEED TO THE SOIL.
- 4. KEEP SEED AREA MOIST (NOT WET) UNTIL SEED GERMINATES AND GRASS IS APPROX. 涉" IN HEIGHT.
- 5. KEEP AREA ADEQUATELY WATERED UNTIL A STAND OF THE GRASS IS ESTABLISHED. 6. RE-SEED TO ESTABLISH A THICK STAND OF GRASS IF NECESSARY.


END OF SECTION 02915

LANDSCAPE DETAILS



°,0, Box 83234 Mobile: 972 52 carol@feldmande:

> These drawin been prepare under the su of Carol Feld Registered L Architect #2 Licensed Irrie LI #20245

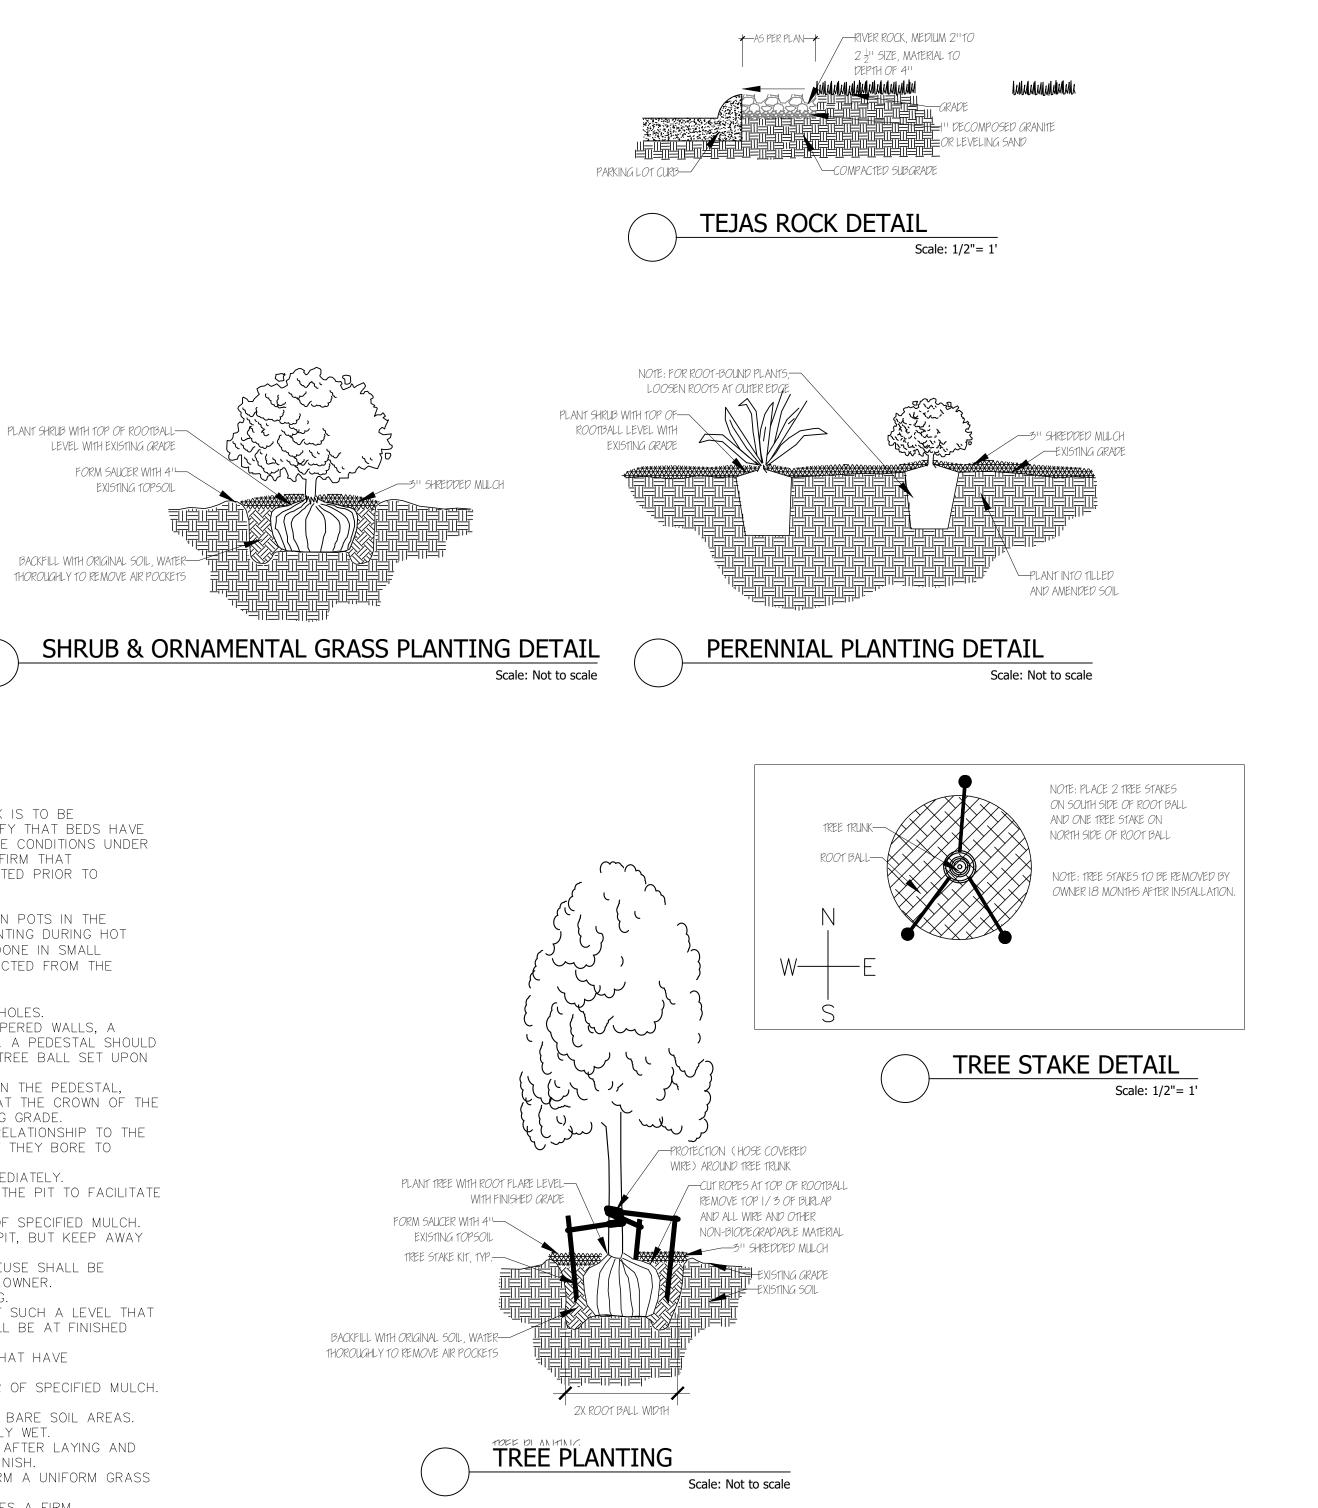

ELDMAN DESIGN STUDIOS 16, Richardson, Texas 75083 3-4944 sign.com	NO. 1. 2. 3. 4. 5. 6. 7.	ITEM DESCRIPTION SITE PLAN SUBMITTAL REVISED PER CITY COMMENTS	DATE: 7.28.22 8.31.22	LANDSCAPE DETAILS
ngs have ed by or upervision dman, andscape 080, gator CAROL FELDMAN 2080 CAROL FELDMAN CAROL FELDMAN CAROL FELDMAN		ADDISON RESERVE 4150 BELTWAY DRIVE ADDISON TEXAS LOTS 1-37/BLOCK A		SHEET NO.

