

BLOCK 101		
	Residential Retail	394 Units 13,000 SF
BLOCK 102		
	Residential Retail	351 Units 17,000 SF
BLOCK 103	Office	17,000 SF
	Residential	392 Units
BLOCK 201		
BLOCK 202	Residential	383 Units
BLOCK 202	Residential	405 Units
BLOCK 203		
	Residential	366 Units
BLOCK 204	Office	130,000 SF
	Retail (Below)	18000 SF
BLOCK 205	Retail (Below)	40,000 SF
	Office (Above) Residential	18,000 SF 31 Units
BLOCK 206		
	Hotel (Above) Retail (Below)	200 Keys 14,000 SF
BLOCK 207		
BLOCK 208	Residential	310 Units
<u>BEOCK 200</u>	Residential	146 Units
BLOCK 209		
	Office (Above) Retail (Below) Entertainment	24,000 SF 25,000 SF 45,000 SF
BLOCK 210	Littertailillelit	45,000 31
	Office (Above) Retail (Below)	152,000 SF 35,000 SF
BLOCK 211		
BLOCK 211	Retail	87,000 SF
BLOCK 213		
	Residential	298 Units
BLOCK 214	Residential	338 Units
BLOCK 215		
	Residential	265 Units
BLOCK 216	Residential	382 Units
BLOCK 217	Residential	
	Residential	85 Units
BLOCK 301	Davidantial	411 Heite
BLOCK 302	Residential	411 Units
	Residential	541 Units
BLOCK 303	D. 51	
	Residential	290 Units
TOTAL	Desid	E 057 11-0
	Residential Retail Office	5,357 Units 300,000 SF 350,000 SF
0 50	200	

Lot Coverage					
Lot Size:	222,706.00				
Building Footprint Totals:	81,783				
Parking Lot SF Total:	66,210.1				
% of building lot coverage:	37%				
% of parking lot coverage:	30%				
% of total lot coverage:	66%				

PRIVATE YARDS

10' UNDERGROUND -

NOITO HEAST TAILY
AOFINE LOSOS' BAGE 1802
LOSOS' BAGE 1802
LOSOS' BAGE 1802

> 10' UNDERGROUNI

Max Building Height	
To Top of Roof:	43'- 8"

Zoning :	PD 007-034 as amended by 016-017
Open Space SF :	37,694

	İ
	İ
	İ
	İ
	İ
	il .

pen Space SF :	37,694
Zoning :	PD 007-034 as amended by 016-017

BUILD-TO-LINE

FIRE LANE

Unit Mix	Wilder Belshaw Architects Inc.
Vitruvian Town Homes - Addison, TX	1st November 2021

Site size: 222,706 5.11 Density: 16.63

Unit Type	A1	B1	B2	C1	
# of bedrooms	1 Bedroom	2 Bedroom	2 Bedroom	3 Bedroom	
Min. Floor Area	1,500 SF	1,686 SF	1,880 SF	2,228 SF	
	19	5	26	35	85 Total Units
	28,500 SF	8,430 SF	48,880 SF	77,980 SF	

2,753 SF - AMENITY SPACE

163,790 SF - NET RENTABLE (RESIDENTIAL) 222,452 SF - GROSS

85 UNITS	1 BR UNITS 19	22.4%
1,927 SF AVERAGE	2 BR UNITS 31	36.5%
	3 BR UNITS 35	41.2%

Note: Handicap

parking is provided

in accordance with

ADA standards.

1,500 SF - Smallest Unit 2,228 SF - Largest Unit

PARKING REQUIRED 1 per 1BR Unit 2 per 2BR Unit 62 2 per 3BR Unit

PARKING PROVIDED

PRIVATE YARDS

TOTAL req'd

170 Private Garage Spaces 22 Tandem Spaces 2 Accessible Spaces 21 Off Street Surface Spaces

4 Bicycle Parking spaces

215 spaces provided

2.53 Spaces per Unit

Ordinance.

PRIVATE YARDS WITH STONE WALL

-& PUBLIC ACCESS

3. All Buildings on a lot shall have automatic fire


All mechanical equipment shall be screened per Ordinance NO. 016-017, #13. Refer to Landscape for screening materials and dimensions.

This project complies with Town of Addison

ACTION APPROVED DENIED **STAFI** COUNCIL

Vicinity Map (NTS)

See the Staff Approval Letter or Council Result Memo for any conditions associated with the approval of the project.

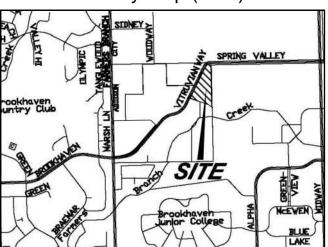

ADDISON SITE PLAN NOTES

- 1. Any revision to this plan will require Town approval and will require revisions to any corresponding plans to avoid conflicts between plans.
- 2. Open storage, where permitted, shall be screened in accordance with the Zoning
- sprinklers installed throughout all structures. Alternative fire protection measures may be approved by the Fire Department.
- 4. All signage is subject to Town approval.
- 5. All fences and retaining walls shall be shown on the site plan and are subject to Building Inspection Division approval.

The development meets the sustainability requirements per Ordinance NO. 016-017, Exhibit F.

applicable codes including 2018 ICC-codes and 2017 NEC

Wilder Belshaw Architects



Savoye2 at Vitruvian Park 3875 Ponte Ave Suite 410Addison Texas 75001

Suite 1151Austin Texas 78702 214 969.0500 phone www wilderbelshaw com

The Arnold in East Austin 1621 E 6th Street

Project Owner:

UDR 3875 Ponte Ave, Suite 400

Addison, TX 75001

Contact Information: Robert P. St. John (720) 348-7722 RStJohn@udr.com

Civil:

Icon Consulting Engineers, Inc. 2840 W Southlake Blvd #110 Southlake, TX 76092

(817) 552-6210

Issues and Revisions:

Date **Issues** 09.03.21 Site Submittal City Comments 10.11.21 03 11.01.21 City Comments 11.09.21 City Comments

/itruvian

Addison, Texas

Wilder Belshaw Project Number: 1901

Drawing Name:

DEVELOPMENT PLAN

ZONING: PD Sheet Number:

Addison, TX

Town Project # 1839-Z

BLOCK <u>217</u>

VP 217 5.112 acres

A101

© 2021 WILDER BELSHAW ARCHITECTS

06 DEVELOPMENT PLAN

SCALE: 1"=40'

TOWN OF ADDISON

70' T.P & L. EASEMENT VOLUME 70202, PAGE 1805

BUILD-TO-LINE -& PUBLIC ACCESS

PROPERTY LIN

NORTH

TRAIL SYSTEM

TOWN GENERAL NOTES:

- 1. ANY PLANTING WITHIN THE PUBLIC ROW MUST BE COORDINATED WITH THE TOWN OF ADDISON PARKS DEPARTMENT.
- 2. MECHANICAL EQUIPMENT IS SCREENED FROM PUBLIC ROADWAYS WITH EVERGREEN LANDSCAPE MATERIAL PER ORDINANCE NO. 007-034. PLANT MATERIAL TO BE MINIMUM HEIGHT OF 6' AT TIME OF INSTALL ATION.

TOWN PLANTING NOTES:

- 1. ANY CHANGES TO PLANTINGS WITHIN THE PUBLIC R.O.W. MUST ALSO BE REPORTED TO THE TOWN OF ADDISON PARKS DEPARTMENT.
- 2. FINAL FINISH GRADE OF PLANTING AREAS IN THE PUBLIC R.O.W. MUST REVIEWED AND APPROVED BY THE TOWN OF ADDISON PARKS DEPARTMENT.
- 3. THE PARKS DEPARTMENT MUST REVIEW AND APPROVE ANY PLANT MATERIAL PROVIDED WITHIN THE PUBLIC R.O.W. PRIOR TO DELIVERY TO SITE. ANY PLANT SUBSTITUTION IN THE R.O.W. MUST BE PROVIDED TO THE PARKS DEPARTMENT FOR APPROVAL PRIOR TO PURCHASE.
- 4. PLANTINGS WITH THE PUBLIC R.O.W. MUST BE PLANTED WITH THE FOLLOWING SOIL SPECIFICATIONS:

LANDSCAPE BEDS - PH BALANCED COMPOST FROM SOIL BUILDING SYSTEMS, OR APPROVED EQUAL. TILL INTO EXISTING SOIL TO ACHIEVE A MAXIMUM RATIO OF 50% COMPOST AND 1 PART EXISTING SOIL.

STREETSCAPE LANDSCAPE / TREE PLANTING BEDS - DEEP TREE PLANTING MIX FROM SOIL BUILDING SYSTEMS OR APPROVED EQUAL. THIS PERTAINS TO ALL OF THE SOIL IN THE PLANTING AREA. IT IS NOT ALLOWABLE TO KEEP 2/3 NATIVE SOIL IN THE PLANTING AREA.

LAWN - GUMBO BUSTER FROM SOIL BUILDING SYSTEMS OR APPROVED EQUAL. TILL IN 1 PART GUMBO BUSTER WITH PART NATIVE SOIL. NOTE THAT PLANTING AREAS WITH HEAVILY COMPACTED SOIL AND CONSTRUCTION DEBRIS MAY NOT QUALIFY AS NATIVE SOIL AND IMPORTED TOPSOIL MAY BE REQUIRED.

TOWN IRRIGATION NOTES:

- . AN AUTOMATIC IRRIGATION SYSTEM THAT COMPLIES WITH THE TOWN'S IRRIGATION SPECIFICATIONS MUST BE INSTALLED IN THE PUBLIC R.O.W. ALL IRRIGATION WITHIN THE R.O.W. MUST BE CONTROLLED BY THE TOWN'S CENTRAL CONTROL SYSTEM. THE CONTRACTOR IS RESPONSIBLE FOR THE INSTALLATION OF ANY RADIO ANTENNAE THAT MAY BE REQUIRED.
- 2. ANY PLANTING DAMAGED IN ADJACENT MEDIANS AND PROPERTIES DURING CONSTRUCTION IS TO BE REPLACED AT NO COST TO THE OWNER.
- 3. ANY DAMAGED PLANT MATERIAL CAUSED BY A NON-FUNCTIONAL IRRIGATION SYSTEM WILL BE REPLACED AT THE COST OF THE CONTRACTOR.
- 4. PLANTINGS MAY NOT BE INSTALLED UNTIL THE IRRIGATION SYSTEM IS INSTALLED, HAS A WORKING POWER SOURCE AND IF FULLY OPERATIONAL. CONTRACTOR RESPONSIBLE FOR IRRIGATION TO PLANTING UNTIL TRANSFERRED TO THE TOWN AFTER SUBSTANTIAL COMPLETION.

GENERAL NOTES:

- 1. WARNING!!!!!!!!! CALL BEFORE YOU DIG!!!!!! TOLL FREE 811
- 2. WRITTEN DIMENSIONS PREVAIL OVER SCALED DIMENSIONS. NOTIFY LANDSCAPE ARCHITECT OF ANY DISCREPANCIES.
- 3. THE CONTRACTOR BEARS ALL RESPONSIBILITY FOR VERIFYING ALL UNDERGROUND UTILITIES, PIPES, STRUCTURES, AND LINE RUNS IN THE FIELD PRIOR TO CONSTRUCTION. ANY DAMAGE TO UTILITIES THAT ARE TO REMAIN SHALL BE REPAIRED IMMEDIATELY AT NO EXPENSE TO THE OWNER. LANDSCAPE ARCHITECT ASSUMES NO RESPONSIBILITY FOR ANY NOT SHOWN ON PLANS.
- 4. THE LOCATIONS OF EXISTING UTILITIES AS SHOWN ON THESE PLANS ARE APPROXIMATE. THERE MAY BE OTHER UNDERGROUND UTILITIES WITHIN THE PROJECT AREA THAT ARE NOT SHOWN.
- 5. ALL PROPOSED AND FINISHED GRADES ARE BASED ON INFORMATION PROVIDED BY THE OWNER'S SURVEY AND/OR CIVIL ENGINEER. ANY DISCREPANCIES IN ACTUAL FIELD MEASUREMENTS ARE TO BE REPORTED TO THE LANDSCAPE ARCHITECT IMMEDIATELY.
- 6. CONTRACTOR IS RESPONSIBLE FOR ALL QUANTITIES PER DRAWINGS AND SPECIFICATIONS. ANY QUANTITIES PROVIDED BY LANDSCAPE ARCHITECT ARE PROVIDED FOR CONVENIENCE ONLY CONTRACTORS ARE TO BID THEIR OWN VERIFIED QUANTITIES. NOTIFY LANDSCAPE ARCHITECT OF ANY DISCREPANCIES.
- 7. EASEMENTS SETBACKS, BUILDING, CURB AND GUTTER, UNDERGROUND UTILITIES HAVE BEEN SUPPLIED TO LANDSCAPE ARCHITECT BY THE PROJECT CIVIL ENGINEER. REFER TO CIVIL ENGINEER'S DRAWINGS FOR ADDITIONAL INFORMATION.
- 8. STUDIO OUTSIDE ASSUMES NO RESPONSIBILITY FOR DAMAGES. LIABILITIES, OR COST RESULTING FROM CHANGES OR ALTERATIONS MADE TO THE PLAN WITHOUT THE EXPRESS WRITTEN CONSENT OF STUDIO OUTSIDE.

PLANTING NOTES:

- 1. LANDSCAPE CONTRACTOR SHALL BE RESPONSIBLE FOR VERIFYING THE LOCATION OF ALL UNDERGROUND UTILITIES, PIPES, STRUCTURES, AND LINE RUNS IN THE FIELD PRIOR TO THE INSTALLATION OF ANY PLANT MATERIAL.
- 2. IT IS THE RESPONSIBILITY OF THE CONTRACTOR TO ADVISE THE LANDSCAPE ARCHITECT OF ANY CONDITION FOUND ON THE SITE WHICH PROHIBITS INSTALLATION AS SHOWN ON THESE DRAWINGS. REF. TOWN PLANTING NOTES FOR R.O.W. PLANTING.
- 3. ALL PLANT MATERIAL SHALL BE MAINTAINED IN A HEALTHY AND GROWING CONDITION AND MUST BE REPLACED WITH PLANT MATERIAL OF SAME VARIETY AND SIZE IF DAMAGED, DESTROYED, OR REMOVED.
- 4. LANDSCAPE CONTRACTOR SHALL BE RESPONSIBLE FOR FINE GRADING AND REMOVAL OF DEBRIS PRIOR TO PLANTING IN ALL AREAS.
- 5. FINAL FINISH GRADING SHALL BE REVIEWED BY THE LANDSCAPE ARCHITECT. LANDSCAPE CONTRACTOR SHALL BE RESPONSIBLE FOR ANY ADDITIONAL TOPSOIL REQUIRED TO CREATE A SMOOTH CONDITION PRIOR TO PLANTING. REF. TOWN PLANTING NOTES FOR R.O.W. PLANTING.
- 6. ALL PLANT QUANTITIES LISTED ARE FOR INFORMATION ONLY. IT IS THE CONTRACTOR'S RESPONSIBILITY TO PROVIDE FULL COVERAGE IN ALL PLANTING AREAS AS SPECIFIED IN THE PLANT SCHEDULE AND VERIFY ALL QUANTITIES.
- 7. LANDSCAPE CONTRACTOR TO PROVIDE STEEL EDGING (REFER TO MATERIALS PAGE) BETWEEN ALL PLANTING BEDS AND LAWN AREAS.
- 8. ALL PLANT MATERIAL SHALL CONFORM TO THE SPECIFICATIONS AND SIZES GIVEN IN THE PLANT LIST AND SHALL BE NURSERY GROWN IN ACCORDANCE WITH THE AMERICAN STANDARD FOR NURSERY STOCK. LATEST EDITION AMERICAN ASSOCIATION OF NURSERYMEN STANDARDS. ANY PLANT SUBSTITUTION SHALL BE APPROVED BY LANDSCAPE ARCHITECT PRIOR TO PURCHASE. REF. CITY PLANTING NOTES FOR R.O.W. PLANTING.
- 9. LANDSCAPE CONTRACTOR IS RESPONSIBLE FOR ANY COORDINATION WITH OTHER CONTRACTOR'S ON SITE AS REQUIRED TO ACCOMPLISH ALL PLANTING OPERATIONS.
- 10. ALL NEW PLANTING AREAS TO BE AMENDED PER SPECIFICATIONS.
- 11. ANY PLANT MATERIAL THAT DOES NOT SURVIVE SHALL BE REPLACED WITH AN EQUIVALENT SIZE AND SPECIES WITHIN THIRTY (30) DAYS.
- 12. PLANT MATERIAL SHALL BE PRUNED AS NECESSARY TO CONTROL SIZE BUT NOT TO DISRUPT THE NATURAL GROWTH PATTERN OR CHARACTERISTIC FORM OF THE PLANT EXCEPT AS NECESSARY TO ACHIEVE HEIGHT CLEARANCE FOR VISIBILITY AND PEDESTRIAN PASSAGE OR TO ACHIEVE A CONTINUOUS OPAQUE HEDGE IF REQUIRED.
- 13. LANDSCAPED AREAS SHALL BE KEPT FREE OF TRASH, WEEDS, DEBRIS, AND DEAD PLANT MATERIAL
- 14. ALL LIME STABILIZED SOIL & INORGANIC SELECT FILL FOR BUILDING SHOULD BE REMOVED FROM PLANTING AREAS TO A DEPTH OF 24" & REPLACED WITH ORGANIC IMPORTED TOPSOIL FILL.

IRRIGATION NOTES:

- 1. AN AUTOMATIC IRRIGATION SYSTEM SHALL BE PROVIDED FOR ALL PLANTING AREAS. OVERSPRAY ON STREETS AND WALKS IS PROHIBITED. REF. TOWN IRRIGATION NOTES FOR R.O.W. IRRIGATION.
- 2. IRRIGATION SYSTEMS SHALL BE MAINTAINED AND REPLACED AS NECESSARY.
- 3. ALL PLANTING AREAS TO BE FULLY IRRIGATED.
- 4. IRRIGATION SYSTEM TO HAVE A FULLY AUTOMATED CONTROL SYSTEM.
- ANY EXISTING PLANTING DAMAGED DURING CONSTRUCTION IS TO BE REPLACED AT NO COST TO THE OWNER.
- 6. IF THE EXISTING IRRIGATION SYSTEM IS DAMAGED OR TURNED OFF DURING CONSTRUCTION ACTIVITIES, IT WILL BE THE RESPONSIBILITY OF THE CONTRACTOR TO HAND WATER ALL PLANT MATERIAL AS NEEDED.

STREET TREE REQUIREMENTS:	REQUIRED	PROVIDED
VITRUVIAN WAY 552 LF STREET FOOTAGE ALONG PROPERTY LINE	19 TREES 1 TREE / 30 LF PER TOWN LANDSCAPE REGULATIONS	23 TREES (21 EXISTING, 2 PROPOSED)
SPRING VALLEY ROAD 156 LF STREET FOOTAGE ALONG PROPERTY LINE	6 TREES 1 TREE / 30 LF PER TOWN LANDSCAPE REGULATIONS	6 TREES (2 EXISTING, 4 PROPOSED)
BELLA LANE 420 LF STREET FOOTAGE ALONG PROPERTY LINE	14 TREES 1 TREE / 30 LF PER TOWN LANDSCAPE REGULATIONS	14 TREES (1 EXISTING, 13 PROPOSED)

* STREET LANDSCAPE BUFFER: IN ALL DISTRICTS, A 20-FOOT WIDE LANDSCAPE BUFFER STRIP SHALL BE PROVIDED ALONG THE ENTIRE LENGTH OF THE PORTION OF THE PERIMETER OF THE LOT WHERE A PUBLIC OR PRIVATE STREET EXISTS, EXCLUSIVE OF DRIVEWAYS AND ACCESS WAYS TO POINTS OF INGRESS AND EGRESS TO AND FROM THE LOT. THE PROPERTY OWNER SHALL BE RESPONSIBLE FOR LANDSCAPING, IRRIGATION, AND MAINTENANCE OF ANY RIGHT-OF-WAY AREA BETWEEN THE PROPERTY LINE AND CURB

SUN CONDITION PLANT LEGEND

TMBOL	PLANT ABBR.	BOTANICAL NAME COMMON NAME	MINIMUM SIZE	MINIMUM HEIGHT	MINIMUM	MAXIMUM SPACING	COMMENTS
		CANOPY TREES					
(3)	œ٧	Quercus virginiana 'SDLN' CATHEDRAL LIVE OAK	4" CAL. B&B/CONT.	14'-16'	8'		STRONG CENTRAL LEADER, MATCHED, FULL, WELL BRANCHED 1'-O" CLEAR TRUNK
	ΤΟ	Taxodium distichum BALD CYPRESS	4" CAL B&B/CONT	14'-16'	10'-11'		STRONG CENTRAL LEADER, MATCHED, FULL, WELL BRANCHED 7'-O" CLEAR TRUNK
		ORNAMENTAL TREES	D42/00/(III	1			I O OLD AN INGIN
	cc	Cercis canadensis var. texensis	8'-10' HT.	8'-10' HT.	4'-5'		FULL, WELL BRANCHED, LOW BRANCHING HABIT, SPECIMEN QUALIT
\bigcirc	æ	TEXAS REDBUD	B\$B/CONT	0-10 HI.	4-5		
\bigcirc	CI	Chilopsis linaris DESERT WILLOW	8'-10' HT. B&B/CONT.	&'-10' HT.	4'-5'		FULL, WELL BRANCHED, LOW BRANCHING HABIT, SPECIMEN QUALIT
£3	ID	Ilex decidua POSSUMHAW HOLLY	8'-10' HT. B\$B/CONT	8'-10' HT.	4'-5'		FULL, WELL BRANCHED, LOW BRANCHING HABIT, SPECIMEN QUALIT
\odot	55	Sophora secundiflora TEXAS MOUNTAIN LAUREL	8'-10' HT. B&B/CONT	1 8 -10 HT. I	4'-5'		FULL, WELL BRANCHED, LOW BRANCHING HABIT, SPECIMEN QUALIT
		SCREENING SHRUBS					
●	ю	Ilex comuta 'Burfordii' BURFORD HOLLY	&'-10' HT.	8'-10'	3'-4'	5'-0"	STRONG CENTRAL LEADER, MATCHED, FULL, WELL BRANCHED
0	IN	Ilex x 'Nellie R. Stevens' NELLIE R. STEVENS HOLLY	45 6AL.	8'-10'	3'-4'	5'-0"	STRONG CENTRAL LEADER, MATCHED, FULL, WELL BRANCHED
**	7	Juniperus virginiana 'Taylor'	45	8'-10'	3'-4'	30"	STRONG CENTRAL LEADER, MATCHED, FULL, WELL BRANCHED
46.		TAYLOR JUNIPER	GAL.				
		LARGE SHRUBS	5				NURSERY GROWN, WELL ROOTED, FULL TO CONTAINER
(A)	ᄩ	Leucophyllum frutescens 'Green Cloud' GREEN CLOUD TEXAS SAGE	GAL.	24"	24"	54"	
\odot	IB	Ilex cornuta 'Dwarf Burford' DWARF BURFORD HOLLY	7 GAL.	36"	24"	42"	NURSERY GROWN, WELL ROOTED, FULL TO CONTAINER,
0	МС	Myrica cerifera pumila DWARF WAX MYRTLE	7 GAL.	36"	24"	36"	NURSERY GROWN, WELL ROOTED, FULL TO CONTAINER,
		MEDIUM SHRUBS					
Θ	AR	Abelia x 'Rose Creek' ROSE CREEK ABELIA	3 GAL.	18"	18"	30"	NURSERY GROWN, WELL ROOTED, FULL TO CONTAINER
0	AQ	Anisacanthus quadrifidus var. wrightii FLAME ACANTHUS	3 GAL.	18"	18"	36"	NURSERY GROWN, WELL ROOTED, FULL TO CONTAINER
0	ВТ	Berberis thunbergii BARBERRY	3 GAL.	18"	18"	30"	NURSERY GROWN, WELL ROOTED, FULL TO CONTAINER
⊗	56	Salvia gregii AUTUMN SAGE	3 GAL.	18"	18"	18"	NURSERY GROWN, WELL ROOTED, FULL TO CONTAINER
8	YF	Yucca filamentosa	3	18"	18"	18"	NURSERY GROWN, WELL ROOTED, FULL TO CONTAINER
*	HP	GOLDEN SWORD YUCCA Hesperaloe parviflora	6AL. 5	24"	24"	18"	NURSERY GROWN, WELL ROOTED, FULL TO CONTAINER
**	YR	RED YUCCA Yucca recurvifolia	<i>G</i> AL. 5	24"	24"	4'-6"	NURSERY GROWN, WELL ROOTED, FULL TO CONTAINER
MA.		SOFT LEAF YUCCA	GAL.			, ,	
		SMALL SHRUBS					
0	YP	Yucca pallida PALE LEAF YUCCA	3 6AL.	18"	18"	18"	NURSERY GROWN, WELL ROOTED, FULL TO CONTAINER
(P)	на	Hydrangea paniculata 'Jane' LITTLE LIME HYDRANGEA	5 GAL.	30"	24"	30"	NURSERY GROWN, WELL ROOTED, FULL TO CONTAINER
*	58	Spirea x bumaida 'Goldmound' 'GOLDMOUND' DWARF SPIREA	3 GAL.	18"	18"	18"	NURSERY GROWN, WELL ROOTED, FULL TO CONTAINER
₩	эн	Salvia 'Henry Duelberg' HENRY DUELBERG SALVIA	3 6AL.	18"	12"	18"	NURSERY GROWN, WELL ROOTED, FULL TO CONTAINER
(4)	IV	llex vomitoria 'Nana'	5	18"	18"	42"	NURSERY GROWN, WELL ROOTED, FULL TO CONTAINER
		DWF. YAUPON HOLLY ORNAMENTAL GRASSES	GAL.				
	П	Bouteloua gracilis 'Blonde Ambition'	1	16"	8"	18"	NURSERY GROWN, WELL ROOTED, FULL TO CONTAINER
	B6	BLONDE AMBITION BLUE GRAMA	GAL.	12"	<i>o</i> "	10"	
₩	EC	Erogrostis curvula MEEPING LOVE GRASS	GAL.	12"	8"	18"	NURSERY GROWN, WELL ROOTED, FULL TO CONTAINER
٥	MA	Miscanthus sinensus 'Adagio' 'ADAGIO' MAIDEN GRASS	GAL.	12"	8"	30"	NURSERY GROWN, WELL ROOTED, FULL TO CONTAINER
0	PV	Panicum Virgatum 'Shenandoah' SHENANDOAH SWITCHGRASS	GAL.	12"	36"	30"	NURSERY GROWN, WELL ROOTED, FULL TO CONTAINER
		GROUND COVERS					
	СТ	Carex texensis TEXAS SEDGE	l GAL.	12"	12"	12"	NURSERY GROWN, WELL ROOTED, FULL TO CONTAINER
	=	Euonymus fortunei 'Coloratus'	1	8"	12"	16"	NURSERY GROWN, WELL ROOTED, FULL TO CONTAINER
111111		PURPLE WINTERCREEPER TURF GRASSES	GAL.				
		IN ORGODES					
	-	Stenotaphrum secundatum 'Del Mar'	SOLID				SEE SPECS

SHADE CONDITION PLANT LEGEND

	PLANT ABBR.	BOTANICAL NAME COMMON NAME	MINIMUM	MINIMUM HEIGHT	MINIMUM	MAXIMUM SPACING	COMMENTS
		ORNAMENTAL TREES					
\odot	AP	Acer palmatum var. atropurpureum 'Bloodgood' BLOODGOOD JAPANESE MAPLE	7'-8' HT. B&B/CONT.	7'-8'	4'-5'		FULL, WELL BRANCHED, LOW BRANCHING HABIT, SPECIMEN QUALITY
\odot	cF	Cercis canadensis Forest Pansy FOREST PANSY REDBUD	7'-8' HT. B&B/CONT.	7'-8'	4'-5'		FULL, WELL BRANCHED, LOW BRANCHING HABIT, SPECIMEN QUALITY
		LARGE SHRUBS					
₩	на	Hydrangea quercifolia OAKLEAF HYDRANGEA	5 <i>G</i> AL.	30"	24"	30"	NURSERY GROWN, WELL ROOTED, FULL TO CONTAINER
*	17	Fatsia japonica FATSIA	5 <i>G</i> AL.	30"	24"	42"	NURSERY GROWN, WELL ROOTED, FULL TO CONTAINER
(4)	PM	Podocarpus macrophyllus PODOCARPUS	7 GAL.	36"	24"	42"	NURSERY GROWN, WELL ROOTED, FULL TO CONTAINER,
		MEDIUM SHRUBS					
E.B	~	Aucuba japonica 'Variegata' GOLD DUST AUCUBA	5 <i>G</i> AL.	24"	18"	30"	NURSERY GROWN, WELL ROOTED, FULL TO CONTAINER
	MS	Mahonia 'Soft Caress' SOFT CARESS MAHONIA	5 <i>G</i> AL.	24"	24"	18"	NURSERY GROWN, WELL ROOTED, FULL TO CONTAINER
		SMALL SHRUBS					
₩.	сн	Cephalotaxus harringtonia 'Plania' YEMTOPIA PLUM YEM	3 <i>6</i> AL.	14"	18"	30"	NURSERY GROWN, WELL ROOTED, FULL TO CONTAINER
*	DE	Dryopteris erythrosora AUTUMN FERN	3 6AL.	18"	18"	6"	NURSERY GROWN, WELL ROOTED, FULL TO CONTAINER
\Box	PW	Pittosporum tobira 'Wheelers Dwarf' WHEELERS DWARF PITTOSPORUM	3 GAL.	14"	18"	30"	NURSERY GROWN, WELL ROOTED, FULL TO CONTAINER
***	SM	Sabal minor DWARF PALMETTO	7 GAL.	30"	36"	42"	NURSERY GROWN, WELL ROOTED, FULL TO CONTAINER
		ORNAMENTAL GRASSES					
	CA	Carex tumulicola BERKELEY SEDGE	I GAL.	12"	12"	18"	NURSERY GROWN, WELL ROOTED, FULL TO CONTAINER
		GROUNDCOVER					
	ARE	Ajuga reptans CARPET BUGLEWEED	I GAL.	6"	12"	16"	NURSERY GROWN, WELL ROOTED, FULL TO CONTAINER
8888	F	Juncus inflexus 'Blue Arrows' BLUE ARROWS RUSH	I GAL.	12"	12"	16"	NURSERY GROWN, WELL ROOTED, FULL TO CONTAINER
0	LM	Liriope muscari 'Big Blue' GIANT LIRIOPE BIG BLUE	l GAL.	14"	14"	6"	NURSERY GROWN, WELL ROOTED, FULL TO CONTAINER
	a	Ophiopogon Japonicus MONDO GRASS	I GAL.	12"	12"	16"	NURSERY GROWN, WELL ROOTED, FULL TO CONTAINER

LANDSCAPE REQUIREMENTS:

20' STREET LANDSCAPE BUFFER	PROVIDED
VISIBILITY TRIANGLES	REFER TO PLANS
OFF-STREET LOADING SCREEN	PROVIDED
PARKING LOT SCREENING	N/A

LANDSCAPE CALCULATIONS:

REQUIRED	PROVIDED
20% GROSS SITE LANDSCAPING	GROSS SITE SQ. FT.: 222,707 (5.1 ACRES)
	PROPOSED LANDSCAPE SQ. FT.: 60,431 (27% OF GROSS SITE SQ. FT.)

Wilder Belshaw Architects Dallas · Austin



Savoye2 at Vitruvian Park 3875 Ponte Ave Suite 410Addison Texas 75001

The Arnold in East Austin 1621 E 6th Street Suite 1151Austin Texas 78702

214 969.0500 phone www wilderbelshaw com

Project Owner:

UDR 3875 Ponte Ave, Suite 400 Addison, TX 75001

Contact Information: Robert P. St. John (720) 348-7722 RStJohn@udr.com

Landscape Architect:



Dallas, Texas 75226 o214.954.7160

f214.954.7162

Issues and Revisions:

No.	Date	Issues
01	04.30.21	Site Submittal
02	07.30.21	Site Submittal
03	09.03.21	Site Submittal
04	10.12.21	Site Submittal
05	11.09.21	Site Submittal



Addison, Texas

Wilder Belshaw Project Number: 1901

Drawing Name:

GENERAL NOTES, PLANTING LEGEND & LANDSCAPE CALCULATIONS

Sheet Number:


I 100


TREES PROPOSED (STREET TREES):	REQUIRED	PROVIDED
VITRUVIAN WAY 718 LF STREET FOOTAGE ALONG PROPERTY LINE	24 TREES 1 TREE / 30 LF PER TOWN LANDSCAPE REGULATIONS	23 TREES
SPRING VALLEY ROAD 143 LF STREET FOOTAGE ALONG PROPERTY LINE	5 TREES 1 TREE / 30 LF PER TOWN LANDSCAPE REGULATIONS	6 TREES
BELLA LANE 449 LF STREET FOOTAGE ALONG PROPERTY LINE	15 TREES 1 TREE / 30 LF PER TOWN LANDSCAPE REGULATIONS	13 TREES

TREES PROPOSED (SITE TREES):	PROPOSED	TOTAL CAL.
SHADE TREES AVERAGE 4.5" CAL.	29 TREES	130"
ORNAMENTAL TREES AVERAGE 3.5" CAL.	92 TREES	322"
SCREENING TREES AVERAGE 3" CAL.	78 TREES	234"
	TOTAL CAL. PROPOSED	686"

NO.	ТҮРЕ	SIZE (CAL.)	ON THE LIST?	CLASIFICATION	ACTION	CAL. INCH PRESERVED	CAL. INCH TO BE MITIGATED
1	LIVE OAK	12"	YES		REMOVE		12
2	LIVE OAK	10"	YES		REMOVE		10
3	PECAN	36"	YES		REMOVE		36
4	RED OAK	60"	YES		REMOVE		60
5	RED OAK	72"	YES		REMOVE		72
6	RED OAK	36"	YES		REMOVE		36
7	RED OAK	60"	YES		REMOVE		60
8	LIVE OAK	6"	YES	RIGHT-OF-WAY TREE	PRESERVE		
9	LIVE OAK	8"	YES	RIGHT-OF-WAY TREE	REMOVE		
10	LIVE OAK	6"	YES	RIGHT-OF-WAY TREE	REMOVE		
11	LIVE OAK	6"	YES	RIGHT-OF-WAY TREE	PRESERVE		
12	RED OAK	48"	YES		REMOVE		48
13	CHINESE PHOTINIA	8"	NO		REMOVE		
14	CHINESE PHOTINIA	8"	NO		REMOVE		
15	CHINESE PHOTINIA	8"	NO		REMOVE		
16	CHINESE PHOTINIA	8"	NO		REMOVE		
17	LIVE OAK	24"	YES		REMOVE		24
18	CHINESE PHOTINIA	8"	NO		REMOVE		
19	CHINESE PHOTINIA	8"	NO		REMOVE		
20	CHINESE PHOTINIA	8"	NO		REMOVE		
21	CHINESE PHOTINIA	8"	NO		REMOVE		
22	CHINESE PHOTINIA	8"	NO		REMOVE		
23	CHINESE PHOTINIA	8"	NO		REMOVE		
24	LIVE OAK	50"	YES		REMOVE		50
25	CHINESE PHOTINIA	8"	NO		REMOVE		
26	CHINESE PHOTINIA	8"	NO		REMOVE		
27	CHINESE PHOTINIA	8"	NO		REMOVE		
28	CHINESE PHOTINIA	8"	NO		REMOVE		
29	CHINESE PHOTINIA	8"	NO		REMOVE		
30	CHINESE PHOTINIA	8"	NO		REMOVE		
31	CHINESE PHOTINIA	8"	NO		REMOVE		
32	CHINESE PHOTINIA	12"	NO		REMOVE		
33	MULBERRY	36"	NO		REMOVE		

NO.	ТҮРЕ	SIZE (CAL.)	ON THE LIST?	CLASIFICATION	ACTION	CAL. INCH PRESERVED	CAL. IN BE MITIG
34	CEDAR ELM	15"	YES		REMOVE		1
35	CEDAR ELM	15"	YES		REMOVE		1
36	CEDAR ELM	15"	YES		REMOVE		1
37	YAUPON	11"	YES		REMOVE		1
38	RED OAK	36"	YES		REMOVE		3
39	LIVE OAK	24"	YES		REMOVE		2
40	LIVE OAK	24"	YES		REMOVE		2
41	LIVE OAK	24"	YES		REMOVE		2
42	LIVE OAK	30"	YES		REMOVE		3
43	MAGNOLIA	12"	YES		REMOVE		1
44	BRAD PEAR	72"	NO		REMOVE		
45	BRAD PEAR	60"	NO		REMOVE		
46	SWEET GUM	24"	NO		REMOVE		
47	BRAD PEAR	34"	NO		REMOVE		
48	CYPRESS (OUT LIMIT OF WORK)	10"	NO		PRESERVE		
49	CYPRESS (OUT LIMIT OF WORK)	10"	NO		PRESERVE		
50	CYPRESS (OUT LIMIT OF WORK)	10"	NO		PRESERVE		
51	CYPRESS (OUT LIMIT OF WORK)	10"	NO		PRESERVE		
52	LIVE OAK (OUT LIMIT OF WORK)	6"	YES		PRESERVE		
53	LIVE OAK (OUT LIMIT OF WORK)	6"	YES		PRESERVE		
54	BRAD PEAR	48"	NO		REMOVE		
55	RED OAK	15"	YES		REMOVE		:
56	LIVE OAK (OUT LIMIT OF WORK)	6"	YES	RIGHT-OF-WAY TREE	PRESERVE		
57	LIVE OAK (OUT LIMIT OF WORK)	6"	YES	RIGHT-OF-WAY TREE	PRESERVE		
58	LIVE OAK (OUT LIMIT OF WORK)	6"	YES	RIGHT-OF-WAY TREE	PRESERVE		
59	LIVE OAK (OUT LIMIT OF WORK)	6"	YES	RIGHT-OF-WAY TREE	PRESERVE		
60	LIVE OAK (OUT LIMIT OF WORK)	6"	YES	RIGHT-OF-WAY TREE	PRESERVE		
61	LIVE OAK (OUT LIMIT OF WORK)	6"	YES	RIGHT-OF-WAY TREE	PRESERVE		
62	LIVE OAK (OUT LIMIT OF WORK)	6"	YES	RIGHT-OF-WAY TREE	PRESERVE		
63	LIVE OAK (OUT LIMIT OF WORK)	6"	YES	RIGHT-OF-WAY TREE	PRESERVE		
64	LIVE OAK (OUT LIMIT OF WORK)	6"	YES	RIGHT-OF-WAY TREE	PRESERVE		
65	LIVE OAK (OUT LIMIT OF WORK)	8"	YES	RIGHT-OF-WAY TREE	PRESERVE		
66	LIVE OAK (OUT LIMIT OF WORK)	6"	YES	RIGHT-OF-WAY TREE	PRESERVE		
67	LIVE OAK (OUT LIMIT OF WORK)	6"	YES	RIGHT-OF-WAY TREE	PRESERVE		
68	LIVE OAK (OUT LIMIT OF WORK)	6"	YES	RIGHT-OF-WAY TREE	PRESERVE		
69	LIVE OAK (OUT LIMIT OF WORK)	6"	YES	RIGHT-OF-WAY TREE	PRESERVE		
70	LIVE OAK (OUT LIMIT OF WORK)	6"	YES	RIGHT-OF-WAY TREE	PRESERVE		
71	LIVE OAK (OUT LIMIT OF WORK)	6"	YES	RIGHT-OF-WAY TREE	PRESERVE		
72	LIVE OAK (OUT LIMIT OF WORK)	6"	YES	RIGHT-OF-WAY TREE	PRESERVE		
73	LIVE OAK (OUT LIMIT OF WORK)	6"	YES	RIGHT-OF-WAY TREE	PRESERVE		
74	LIVE OAK (OUT LIMIT OF WORK)	6"	YES	RIGHT-OF-WAY TREE	PRESERVE		
75	ASH (OUT LIMIT OF WORK)	10"	YES	RIGHT-OF-WAY TREE	PRESERVE		
	TOTAL CAL. INCHES TO BE MITIGATED	1					6
	TOTAL CAL. INCHES TO BE PRESERVED					0	1

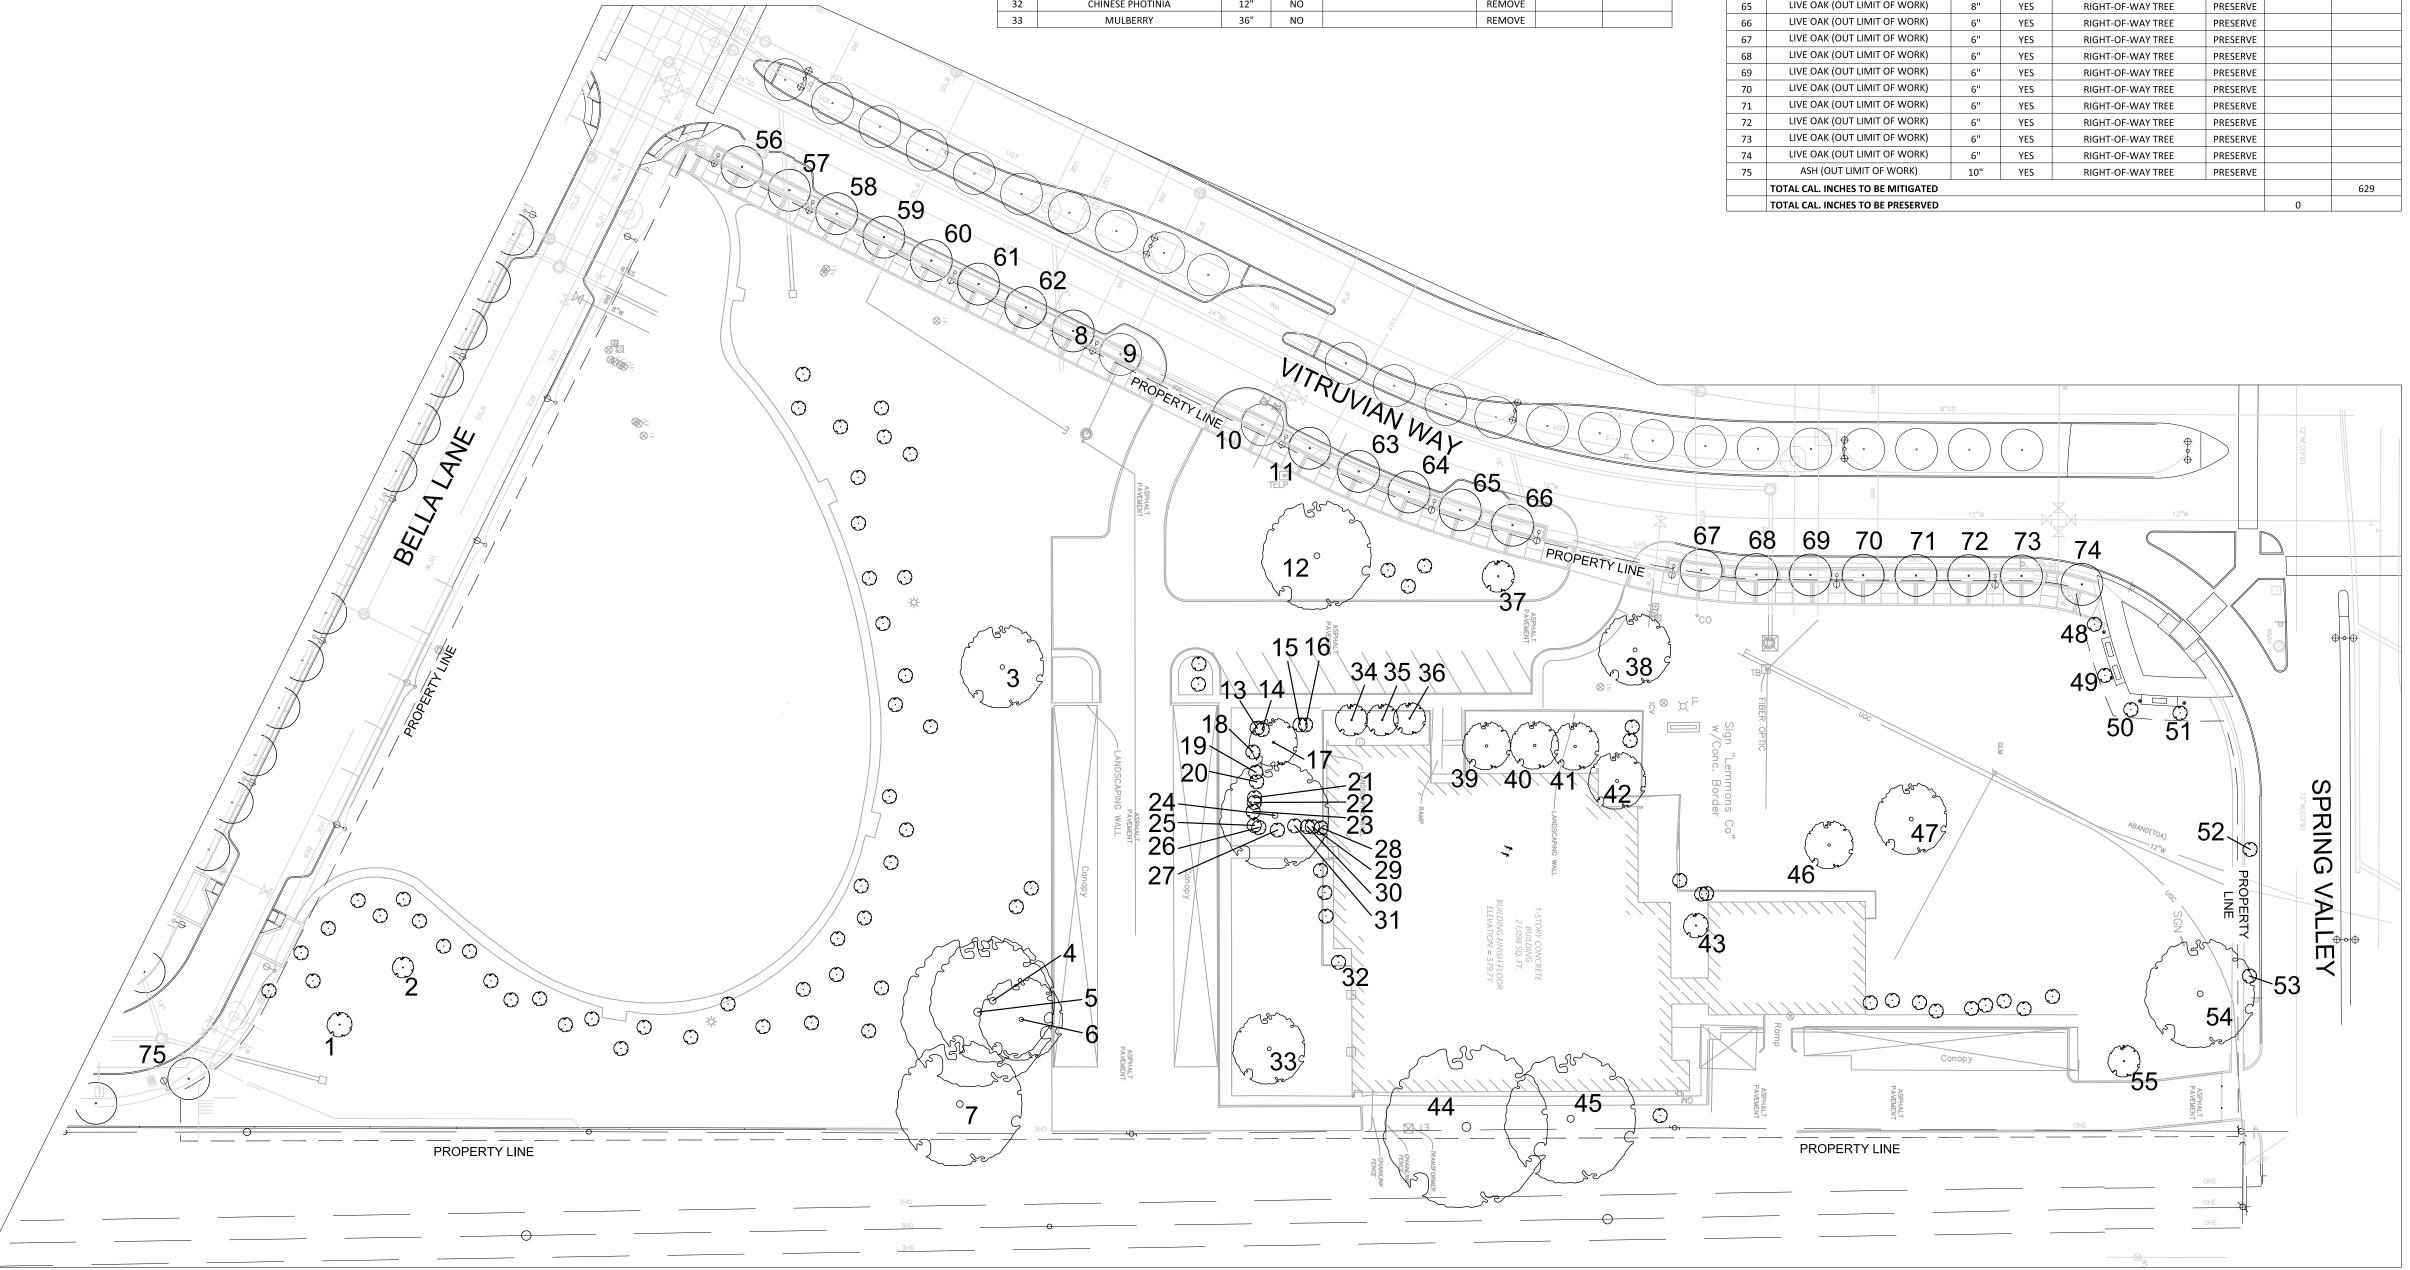

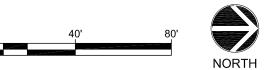

Tree Mitigation Plan



Scale: 1"=40'

© 2021 WILDER BELSHAW ARCHITECTS

Wilder Belshaw Architects
Dallas · Austin



Savoye2 at Vitruvian Park 3875 Ponte Ave Suite 410Addison Texas 75001

The Arnold in East Austin 1621 E 6th Street Suite 1151Austin Texas 78702

214 969.0500 phone www wilderbelshaw com

Project Owner:

UDR

3875 Ponte Ave, Suite 400 Addison, TX 75001

> Contact Information: Robert P. St. John (720) 348-7722 RStJohn@udr.com

Landscape Architect:

824 Exposition Avenue, Ste. 5 Dallas, Texas 75226 o214.954.7160 f214.954.7162

Issues and Revisions:

No.	Date	Issues	
01	04.30.21	Site Submittal	
02	07.30.21	Site Submittal	
03	09.03.21	Site Submittal	
04	10.12.21	Site Submittal	
05	11.09.21	Site Submittal	



Addison, Texas


Wilder Belshaw Project Number: 1901

Drawing Name:

TREE MITIGATION PLAN

Sheet Number:

L101

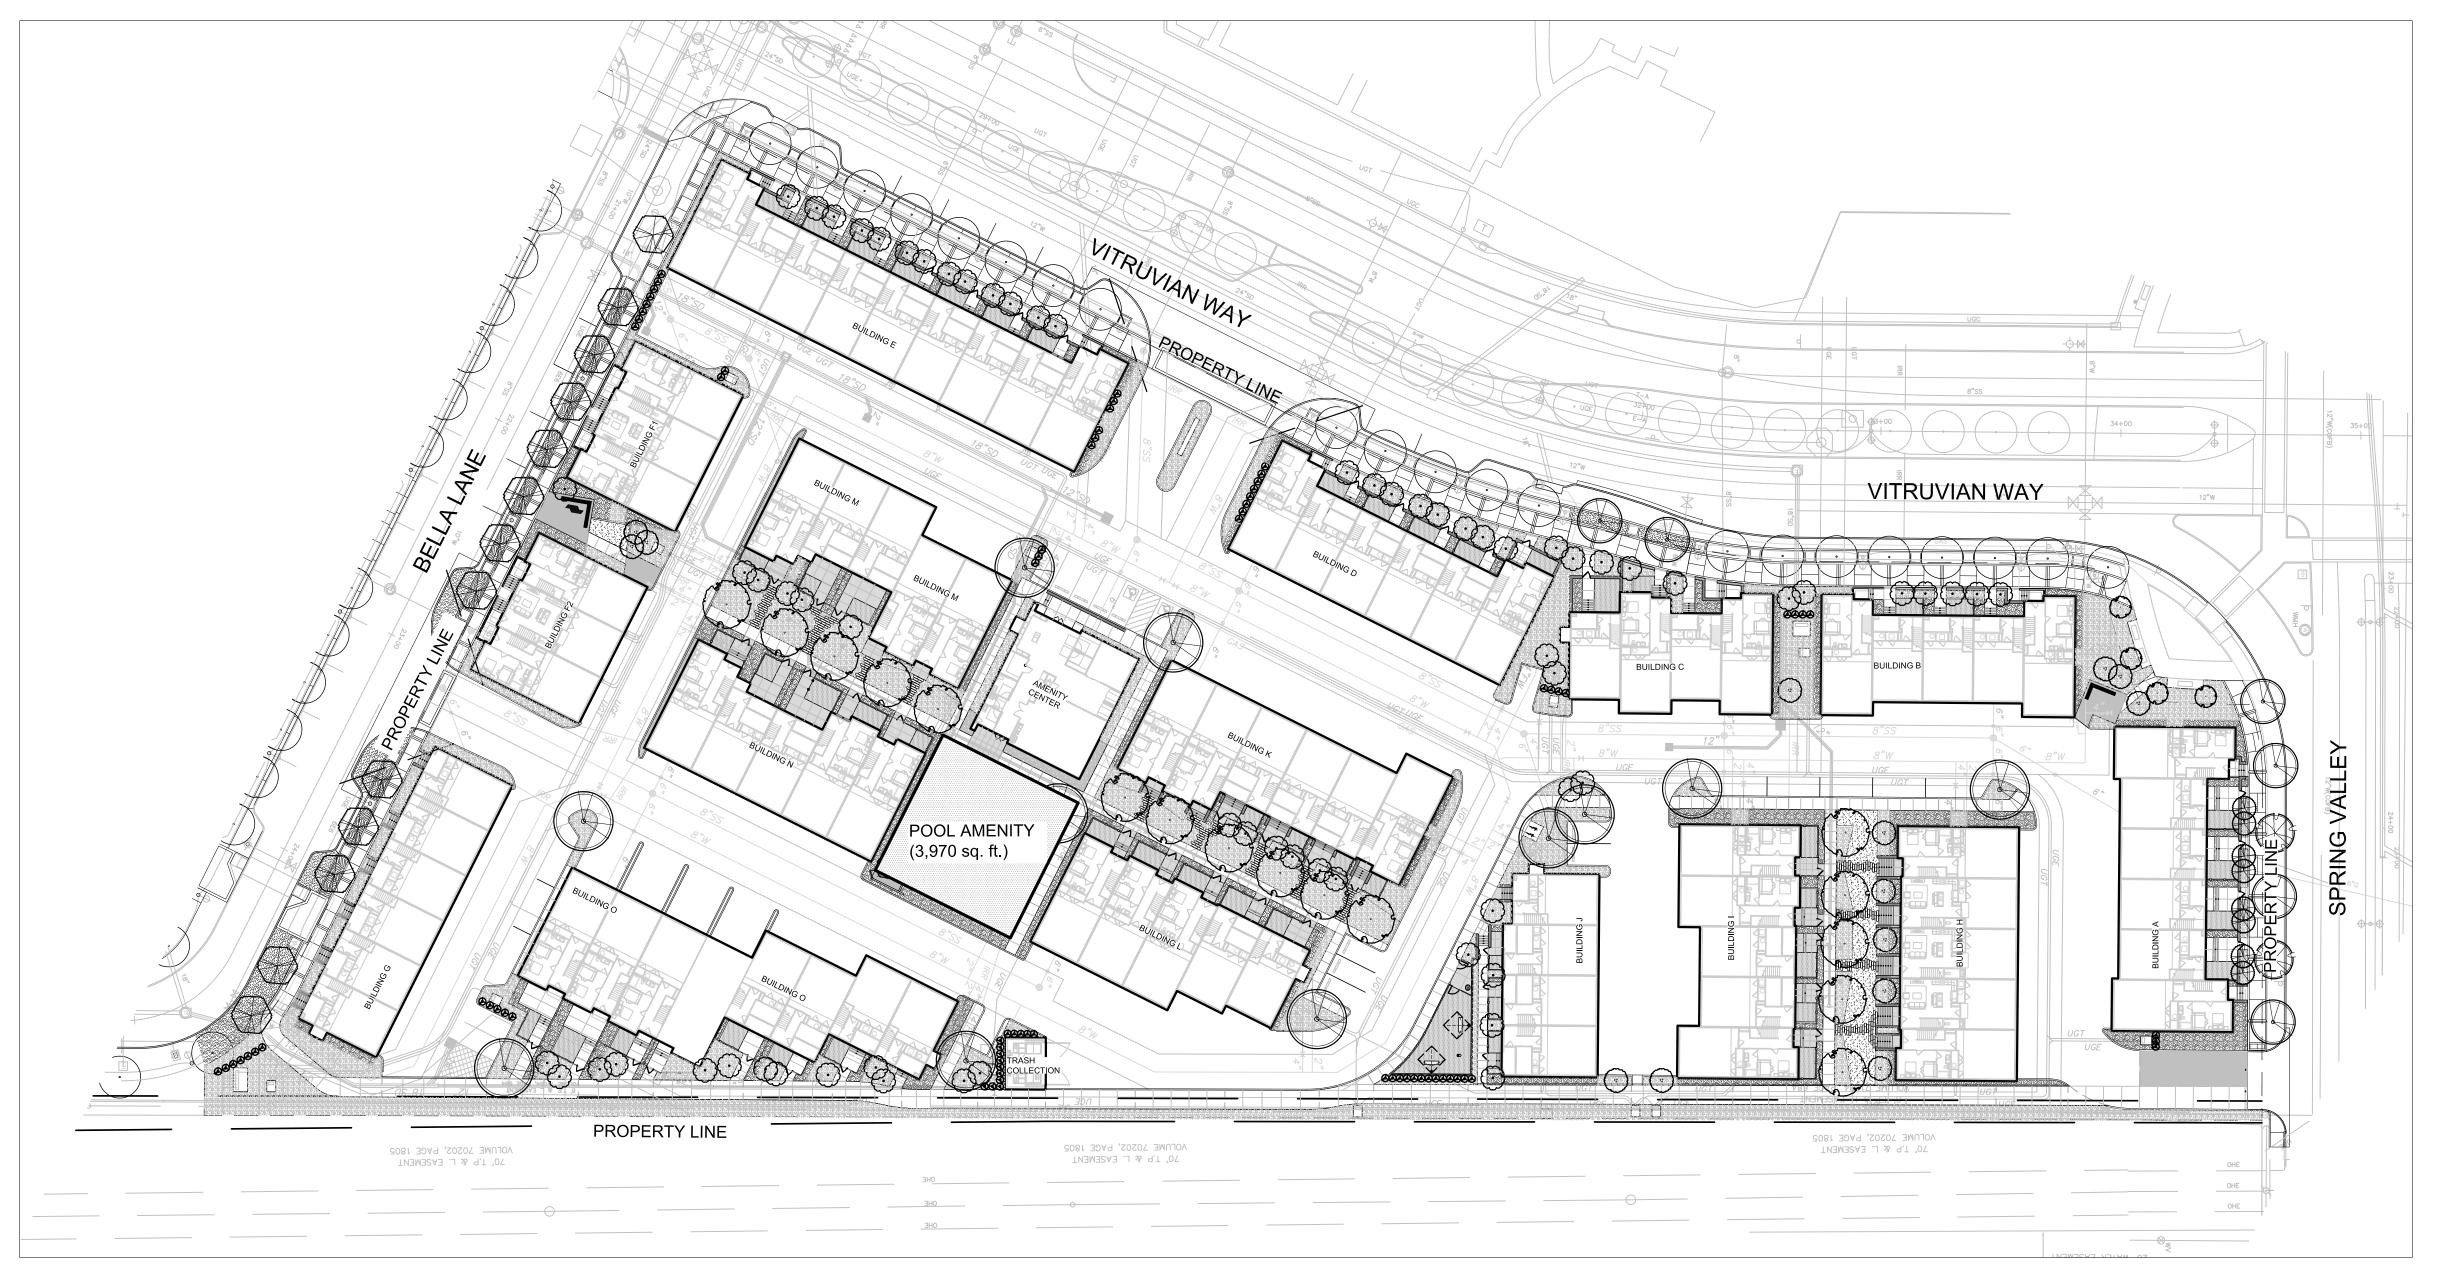



Overall Landscape Plan

Scale: 1"=40'

L103

© 2021 WILDER BELSHAW ARCHITECTS

Wilder Belshaw Architects
Dallas · Austin



Savoye2 at Vitruvian Park 3875 Ponte Ave Suite 410Addison Texas 75001

The Arnold in East Austin 1621 E 6th Street Suite 1151Austin Texas 78702

214 969.0500 phone www wilderbelshaw com

Project Owner:

UDR

3875 Ponte Ave, Suite 400 Addison, TX 75001

Contact Information: Robert P. St. John (720) 348-7722 RStJohn@udr.com

Landscape Architect:

studioOutside

824 Exposition Avenue, Ste. 5 Dallas, Texas 75226 o214.954.7160 f214.954.7162

Issues and Revisions:

No.	Date	Issues	
01	04.30.21	Site Submittal	
02	07.30.21	Site Submittal	
03	09.03.21	Site Submittal	
04	10.12.21	Site Submittal	
05	11.09.21	Site Submittal	




Addison, Texas

Wilder Belshaw Project Number: 1901

Drawing Name:

LANDSCAPE PLAN

Sheet Number:

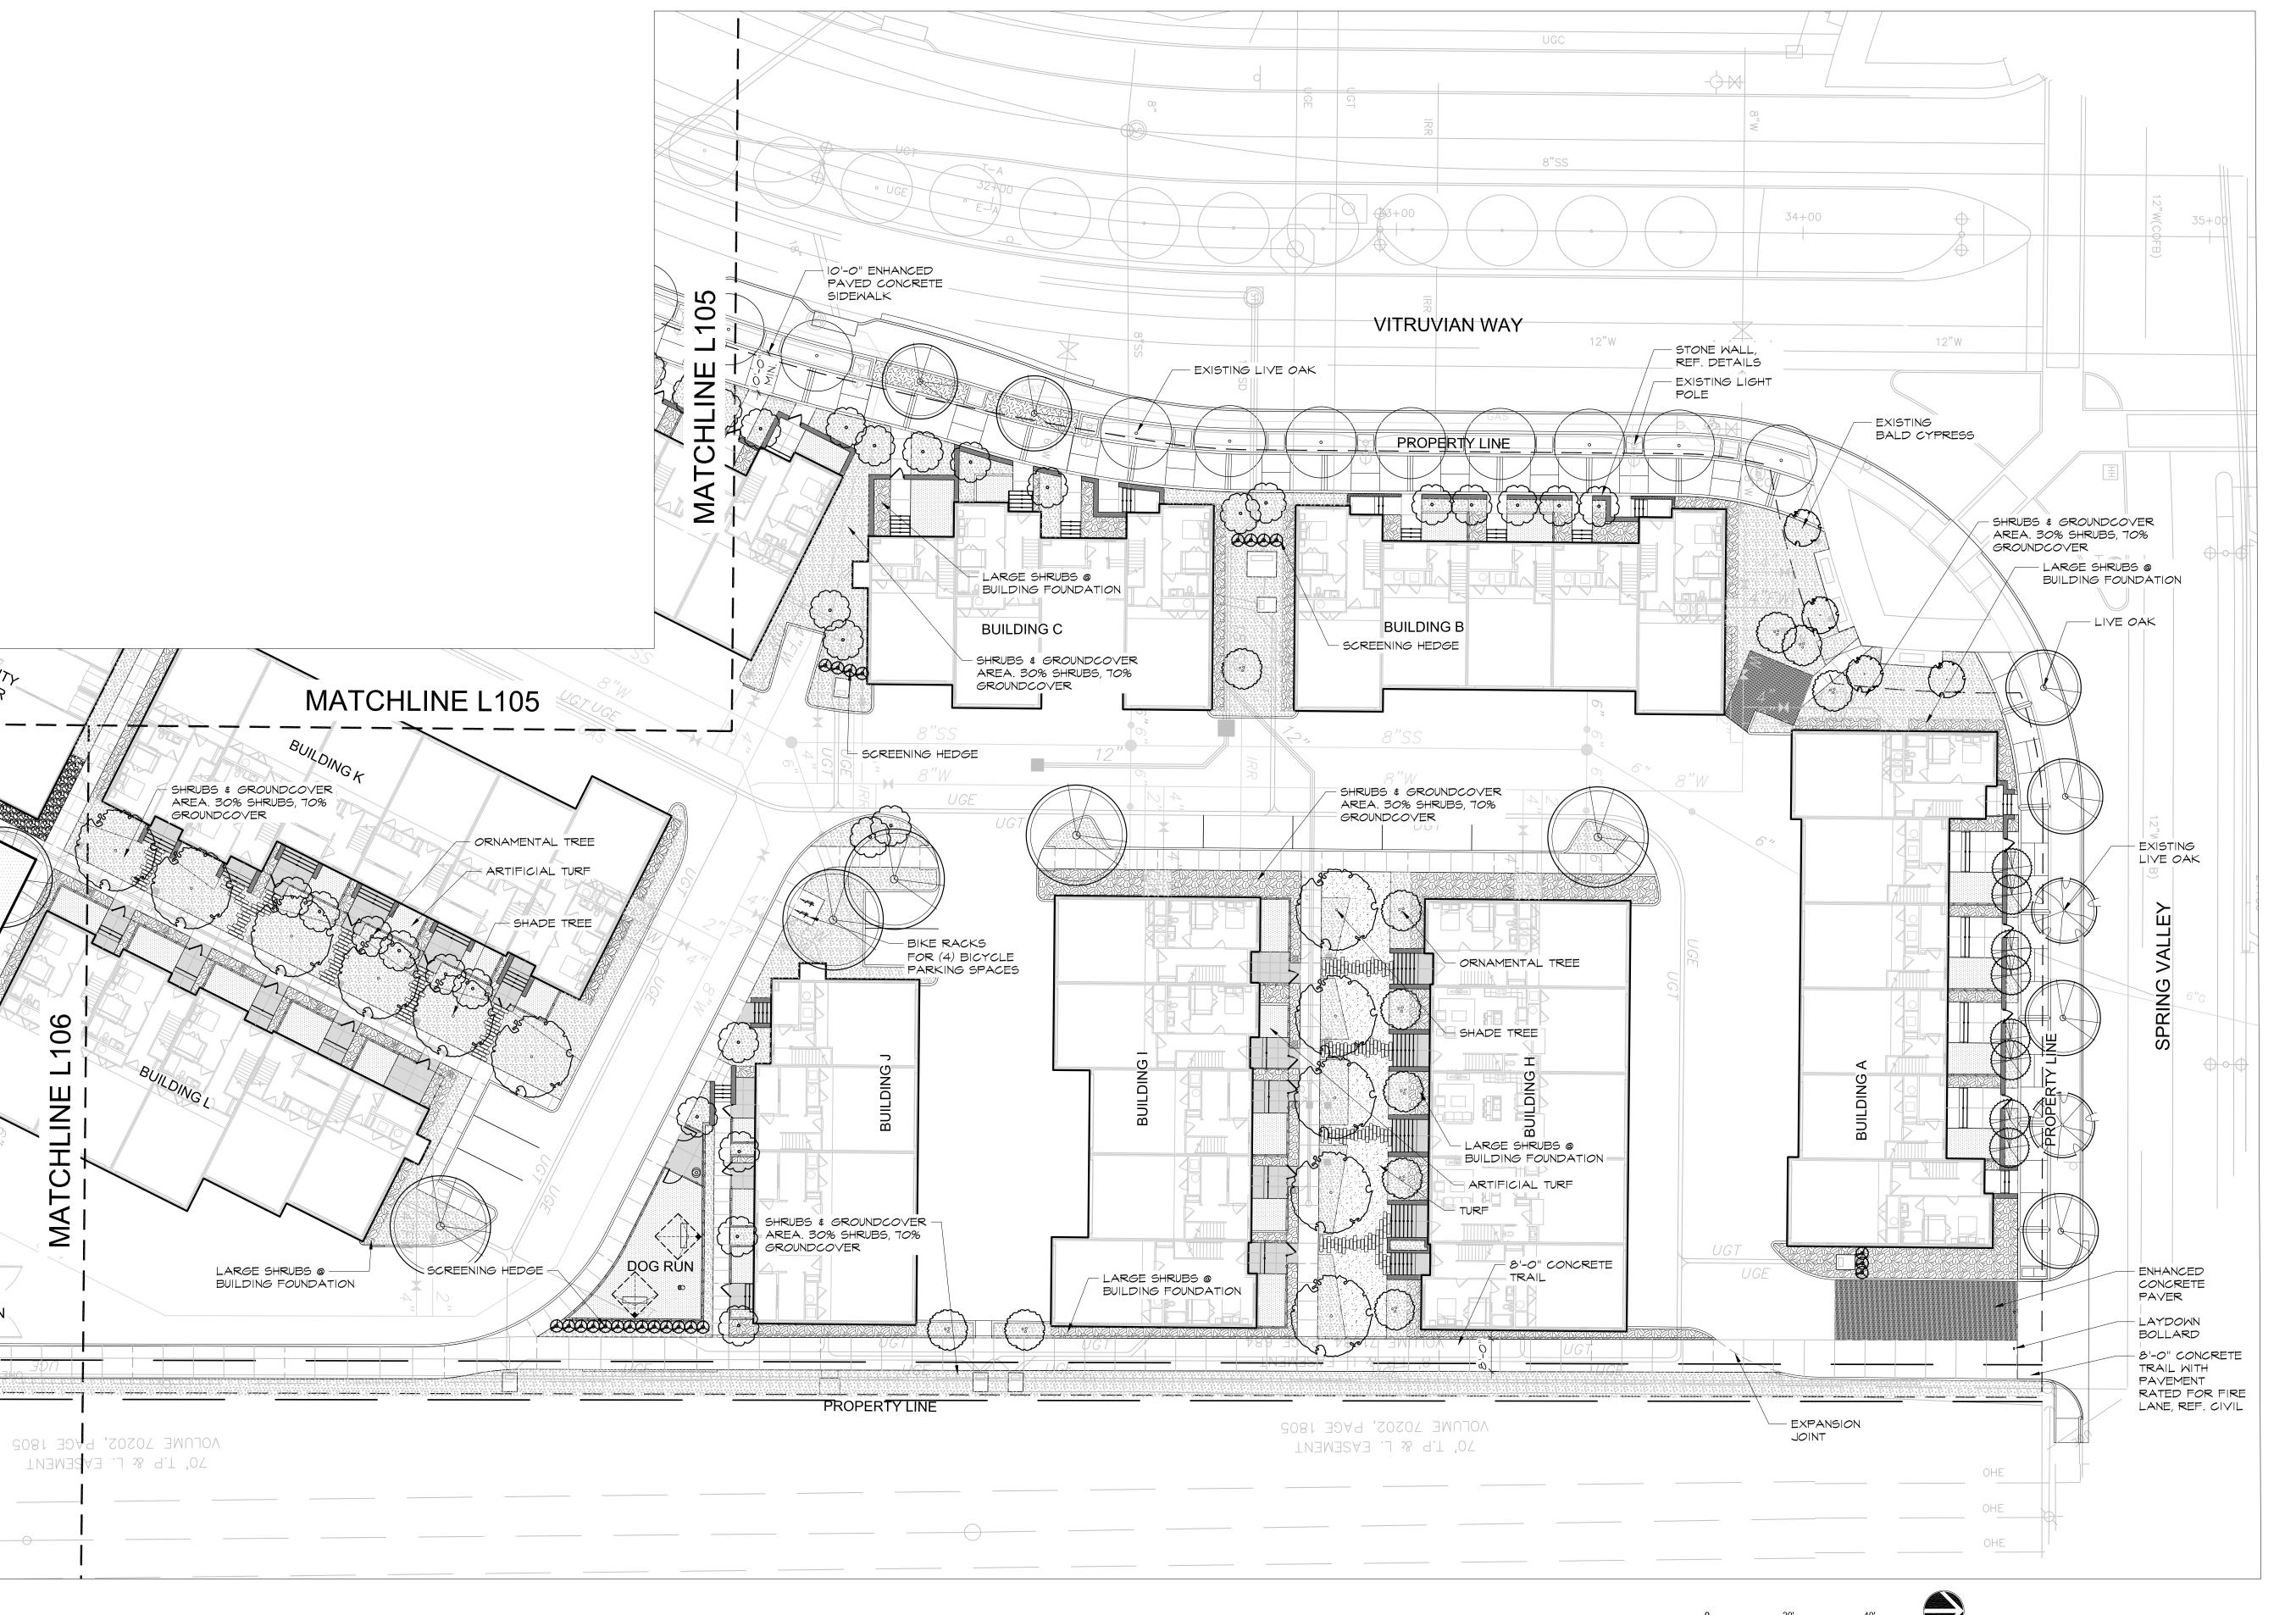



Savoye2 at Vitruvian Park 3875 Ponte Ave Suite 410Addison Texas 75001

The Arnold in East Austin 1621 E 6th Street Suite 1151Austin Texas 78702 214 969.0500 phone www.wilderbelshaw.com

Project Owner:

UDR

3875 Ponte Ave, Suite 400 Addison, TX 75001

Contact Information: Robert P. St. John (720) 348-7722 RStJohn@udr.com

Landscape Architect:

studioOutside

824 Exposition Avenue, Ste. 5 Dallas, Texas 75226 o214.954.7160 f214.954.7162

Issues and Revisions:

No.	Date	Issues
01	04.30.21	Site Submittal
02	07.30.21	Site Submittal
03	09.03.21	Site Submittal
04	10.12.21	Site Submittal
05	11.09.21	Site Submittal



Addison, Texas

Wilder Belshaw Project Number: 1901

Drawing Name:


LANDSCAPE PLAN

Sheet Number:

L104

Landscape Plan

Scale: 1"=20'

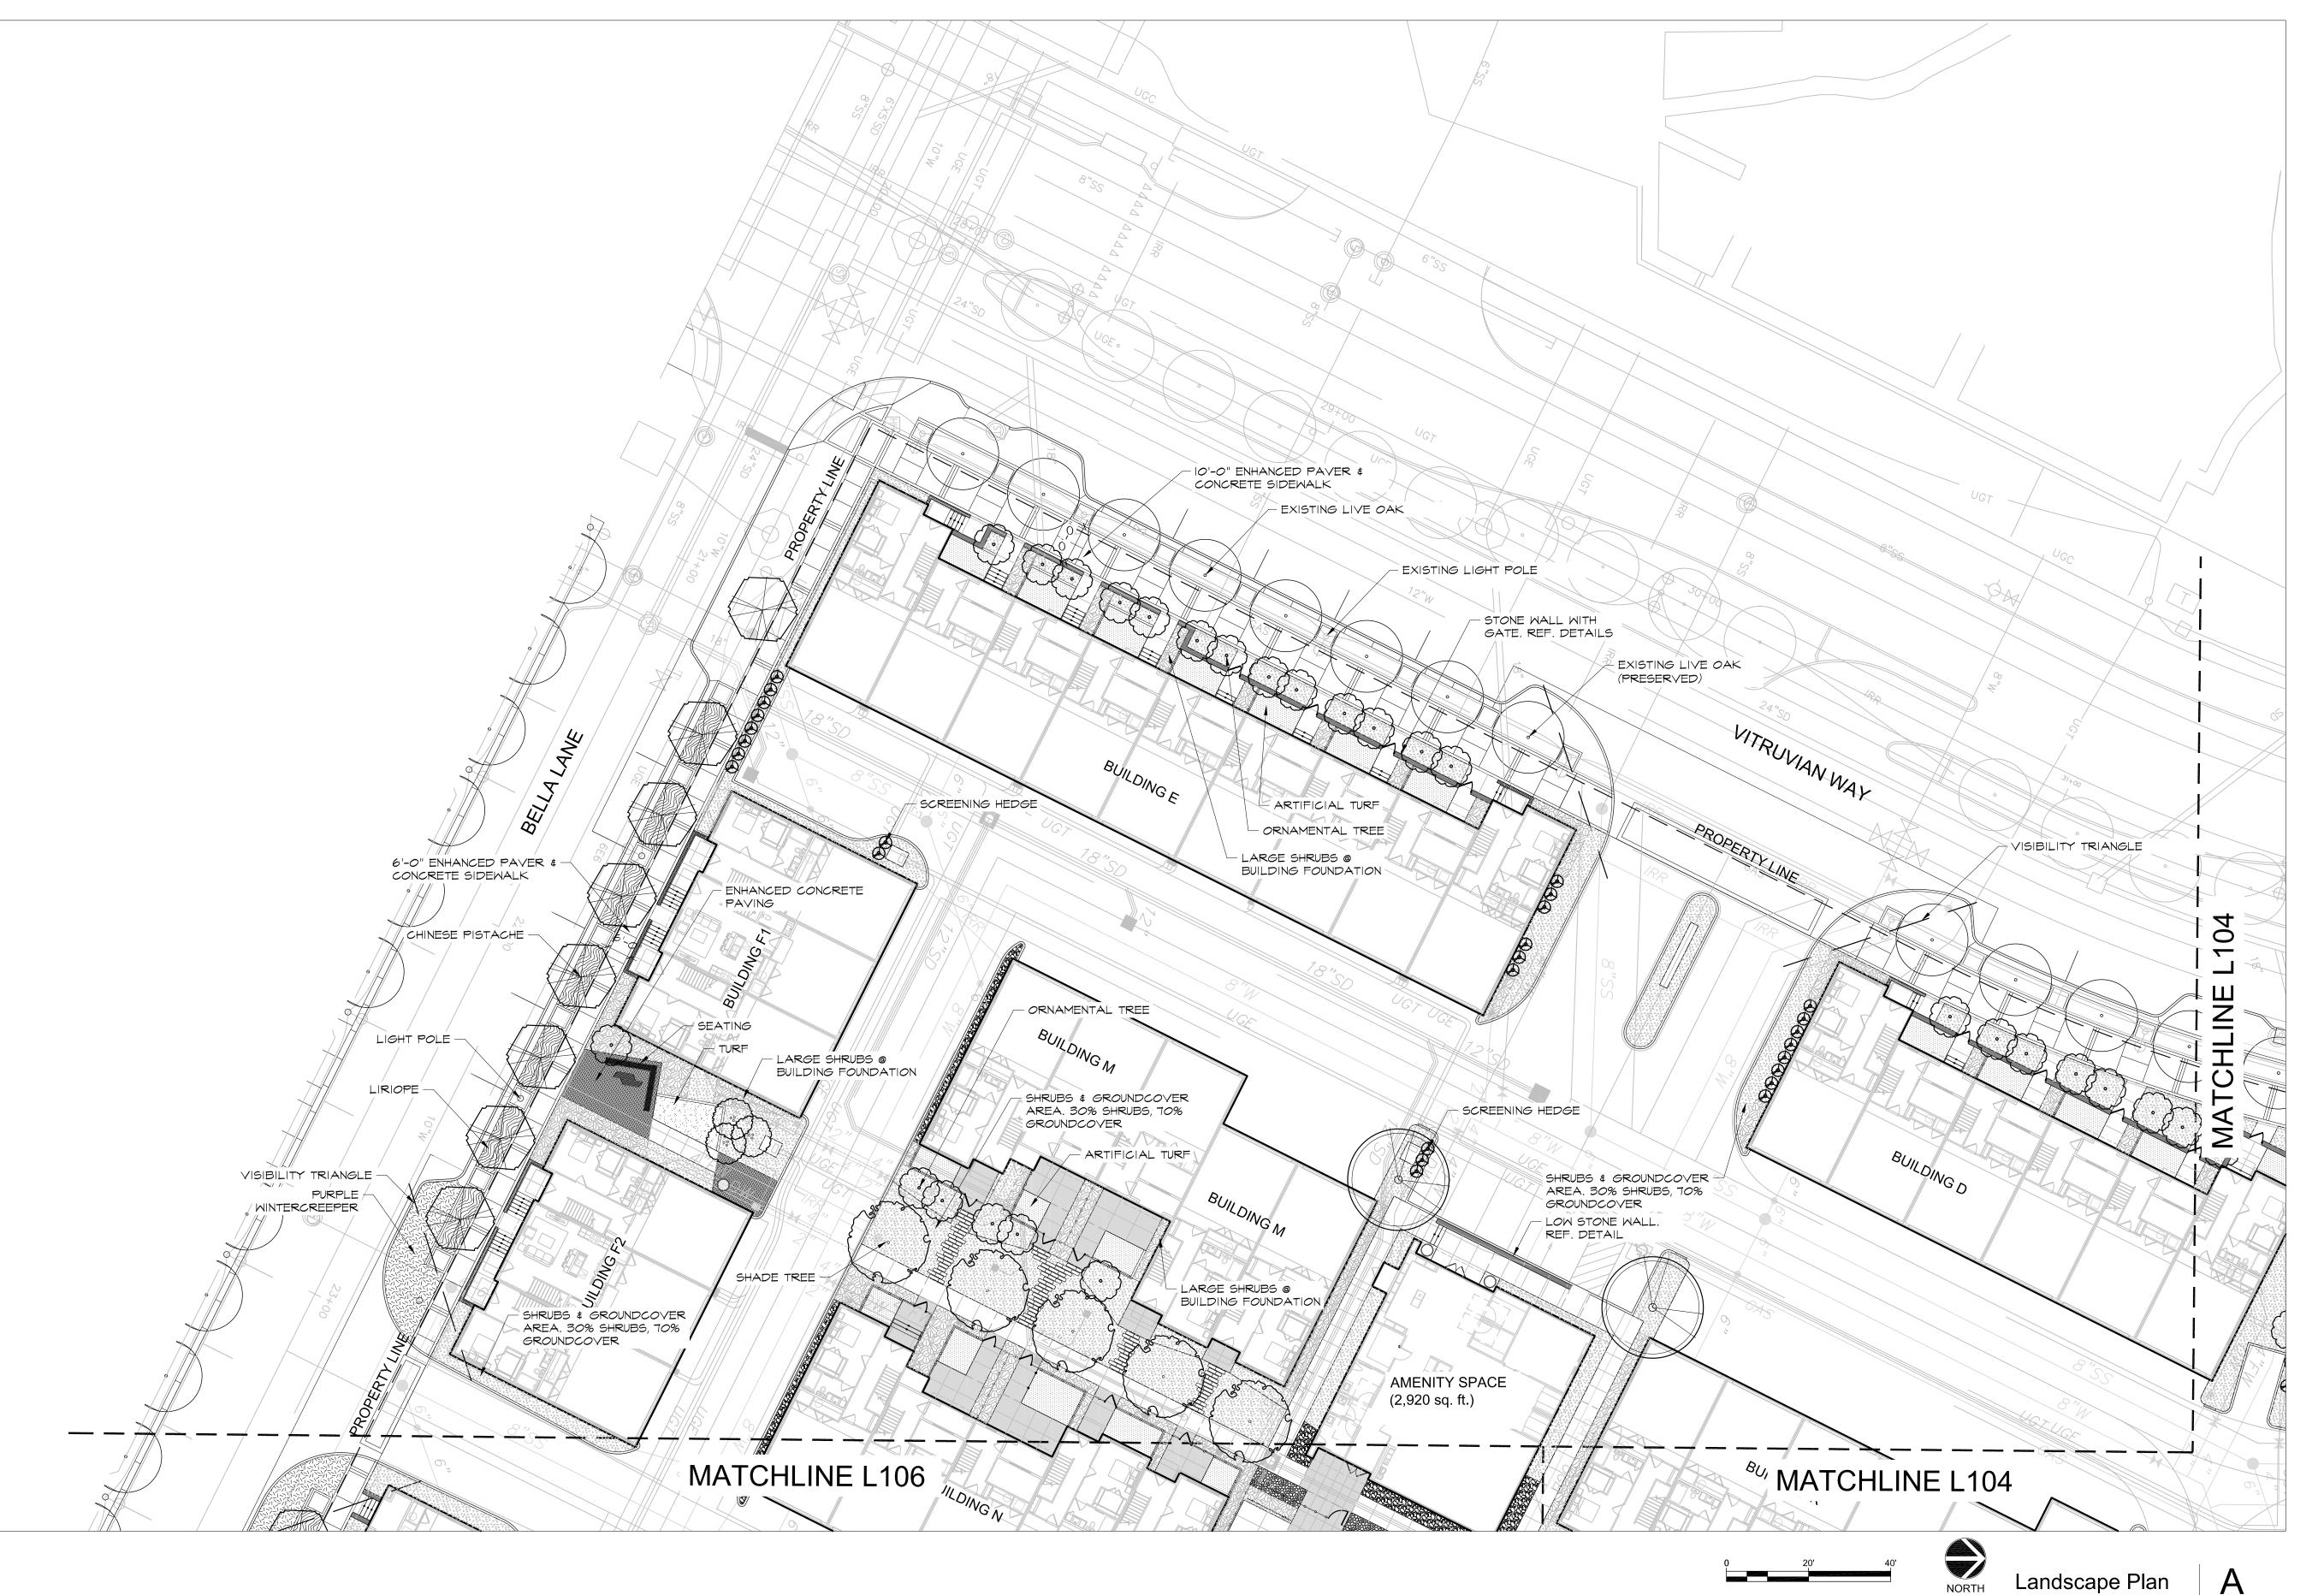



Savoye2 at Vitruvian Park 3875 Ponte Ave Suite 410Addison Texas 75001

The Arnold in East Austin 1621 E 6th Street Suite 1151Austin Texas 78702

214 969.0500 phone www wilderbelshaw com

Project Owner:

UDR

3875 Ponte Ave, Suite 400 Addison, TX 75001

Contact Information: Robert P. St. John (720) 348-7722 RStJohn@udr.com


Landscape Architect:

studioOutside

824 Exposition Avenue, Ste. 5 Dallas, Texas 75226 o214.954.7160 f214.954.7162

Issues and Revisions:

No.	Date	Issues	
01	04.30.21	Site Submittal	
02	07.30.21	Site Submittal	
03	09.03.21	Site Submittal	
04	10.12.21	Site Submittal	
O.F.	11 00 01	C'1 - C. d '11 -d	

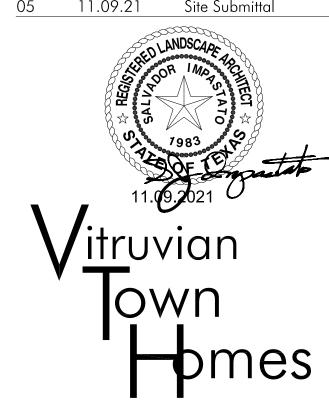

Addison, Texas

Wilder Belshaw Project Number: 1901


Drawing Name:

LANDSCAPE PLAN

Sheet Number:

L105

Scale: 1"=20'

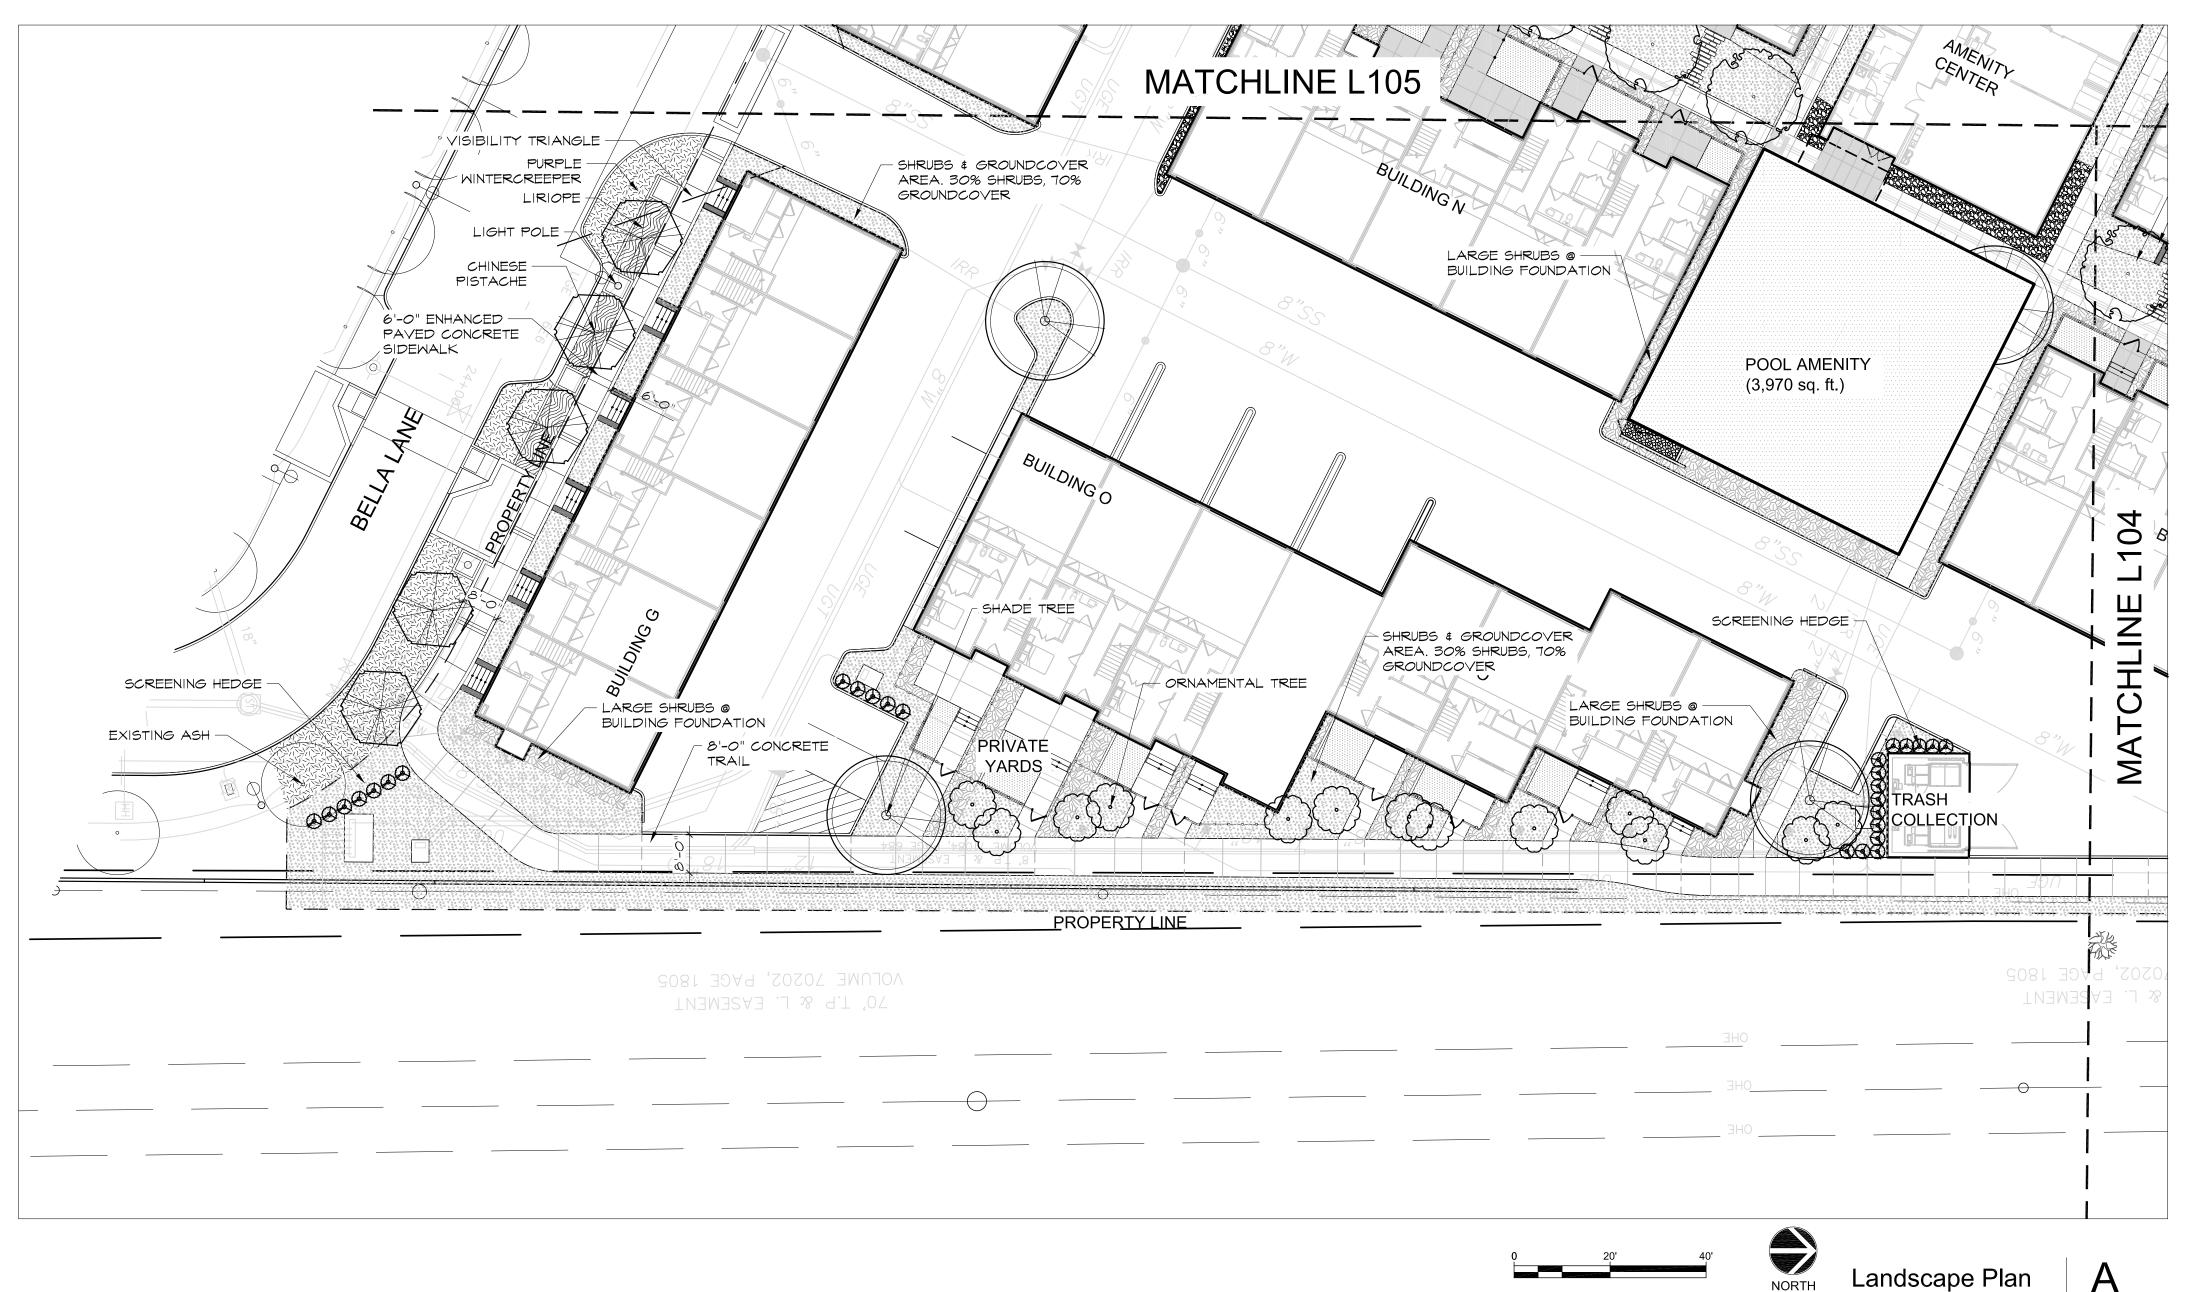



Savoye2 at Vitruvian Park 3875 Ponte Ave Suite 410Addison Texas 75001

The Arnold in East Austin 1621 E 6th Street Suite 1151Austin Texas 78702

214 969.0500 phone www wilderbelshaw com

Project Owner:

UDR

3875 Ponte Ave, Suite 400 Addison, TX 75001

Contact Information: Robert P. St. John (720) 348-7722 RStJohn@udr.com

Landscape Architect:

studioOutside

824 Exposition Avenue, Ste. 5 Dallas, Texas 75226 o214.954.7160 f214.954.7162

Issues and Revisions:

No.	Date	Issues
01	04.30.21	Site Submittal
02	07.30.21	Site Submittal
03	09.03.21	Site Submittal
04	10.12.21	Site Submittal
05	11.09.21	Site Submittal



Addison, Texas

Wilder Belshaw Project Number: 1901


Drawing Name:


LANDSCAPE PLAN

Sheet Number:

L106

Scale: 1"=20'

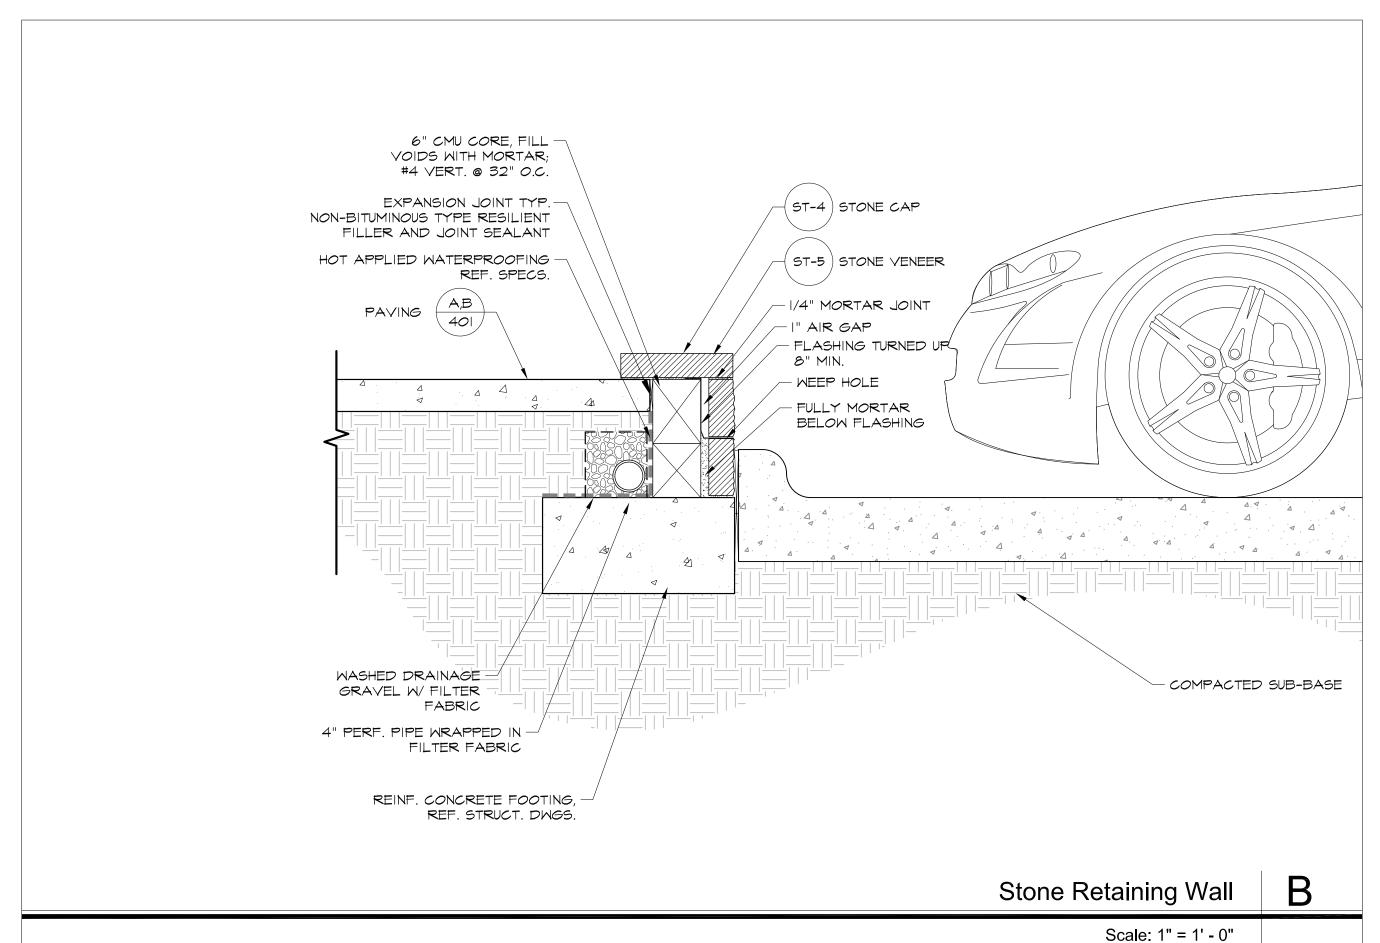

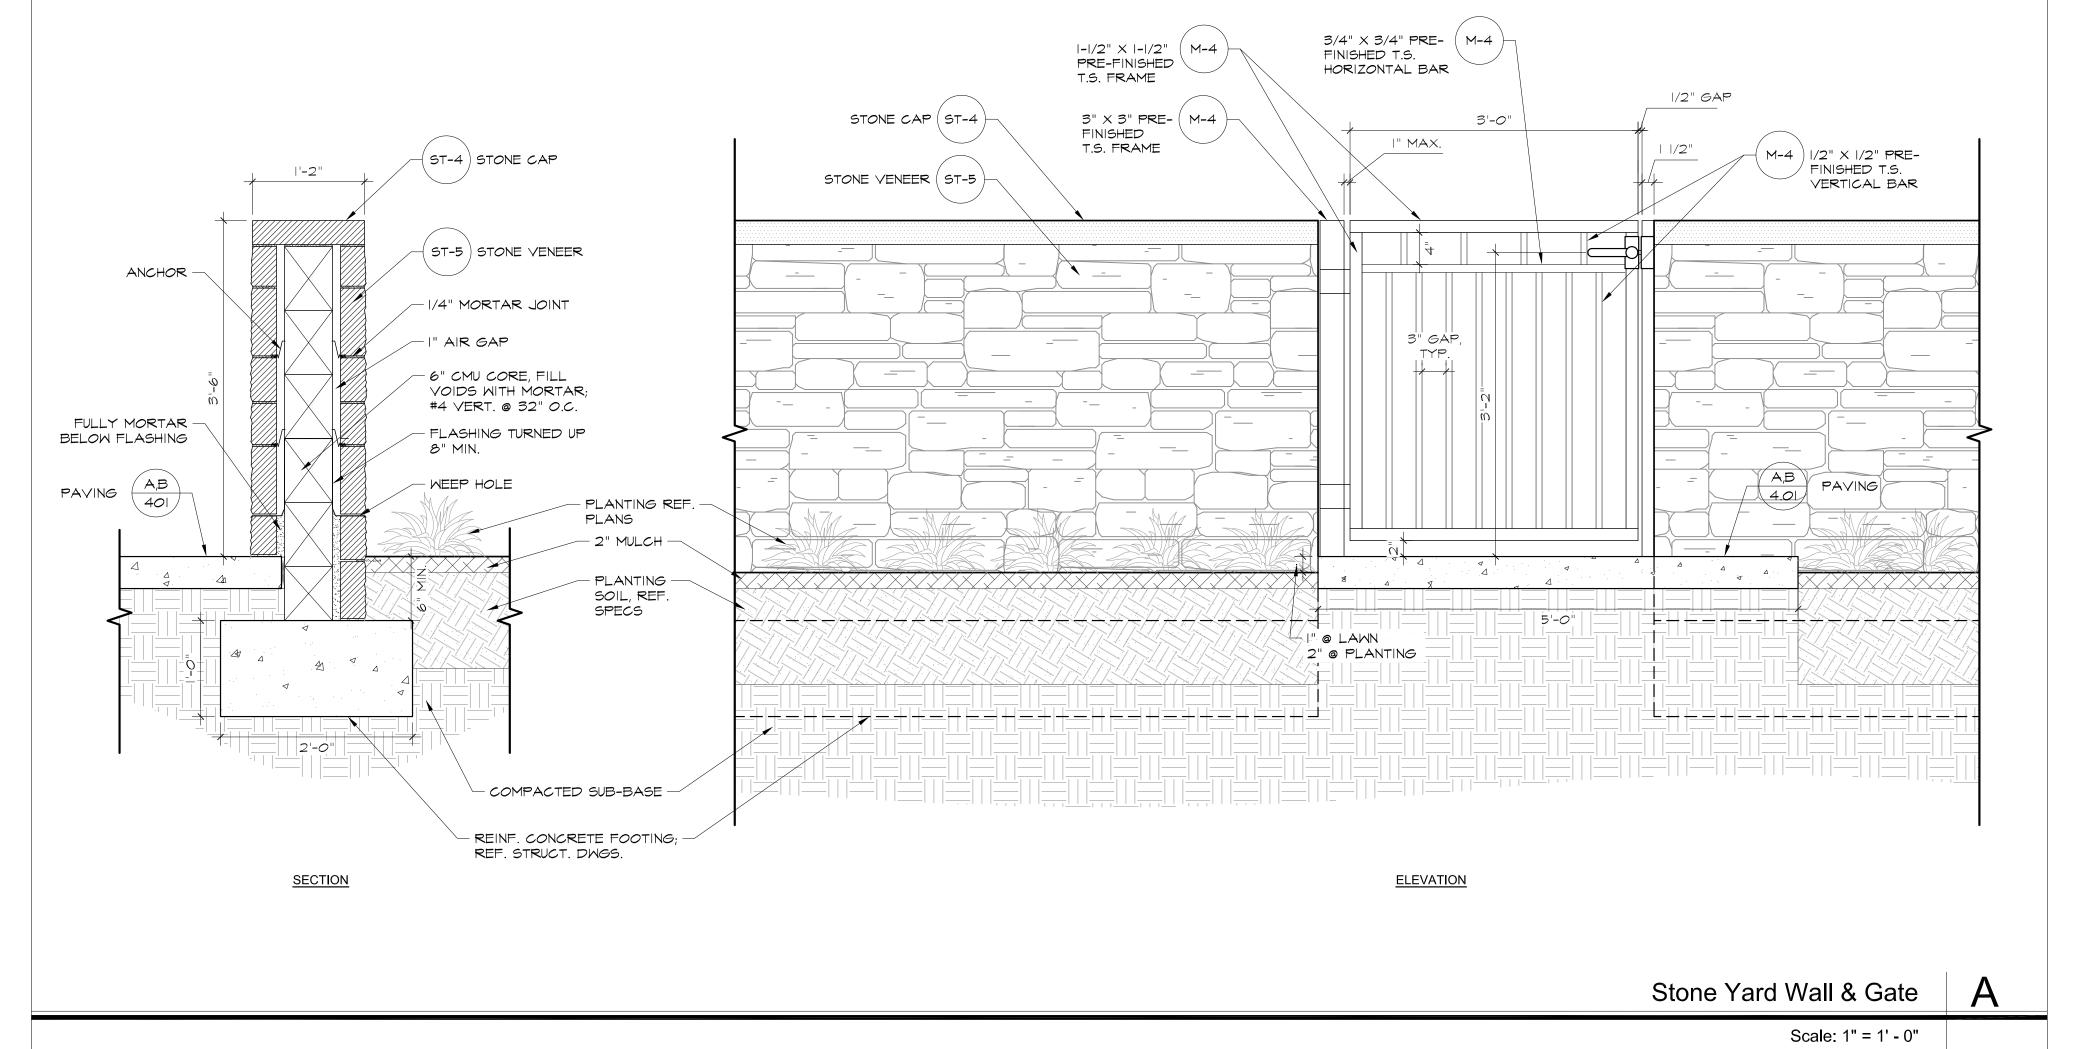



Savoye2 at Vitruvian Park 3875 Ponte Ave Suite 410Addison Texas 75001 The Arnold in East Austin 1621 E 6th Street

Suite 1151Austin Texas 78702

214 969.0500 phone www wilderbelshaw com

Project Owner:

UDR

3875 Ponte Ave, Suite 400 Addison, TX 75001

Contact Information: Robert P. St. John (720) 348-7722 RStJohn@udr.com

Landscape Architect:

studioOutside

824 Exposition Avenue, Ste. 5 Dallas, Texas 75226 o214.954.7160 f214.954.7162

Issues and Revisions:

No.	Date	Issues	
01	04.30.21	Site Submittal	
02	07.30.21	Site Submittal	
03	09.03.21	Site Submittal	
04	10.12.21	Site Submittal	
05	11 00 21	C:40 C. Jone:4401	



Addison, Texas


Wilder Belshaw Project Number: 1901


Drawing Name:

HARDSCAPE DETAILS


Sheet Number:

L102.1

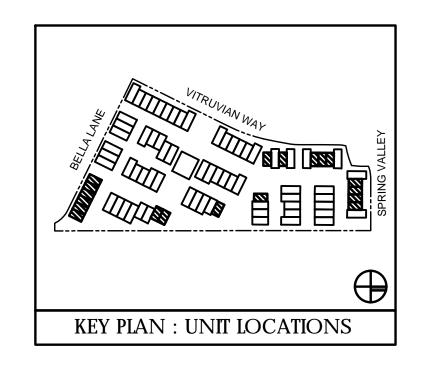


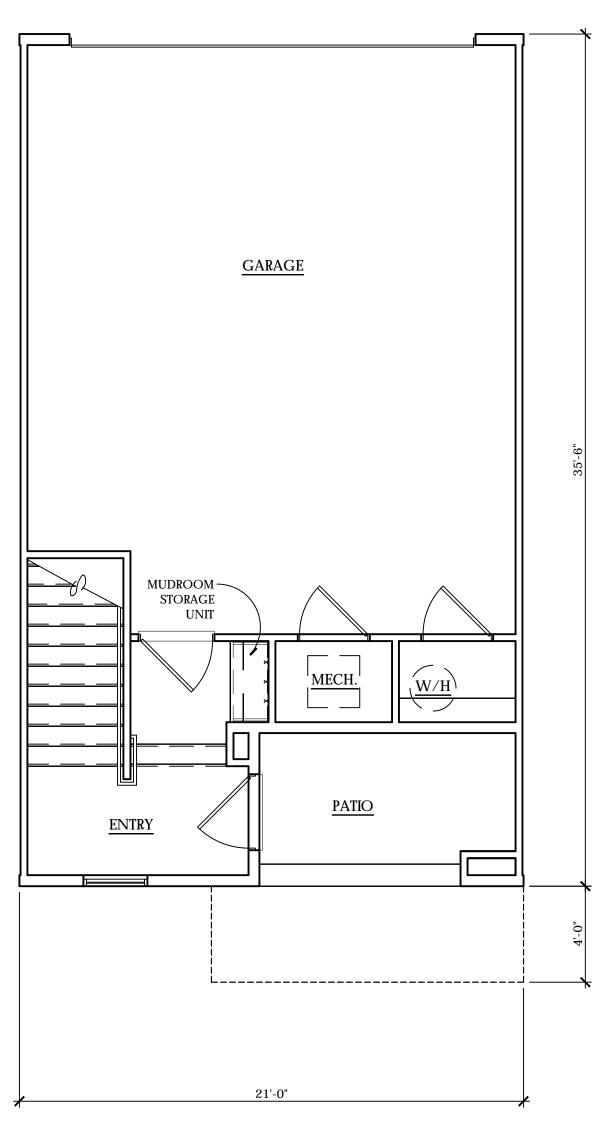

O2 UNIT A1-Level O1 SQUARE FOOTAGE: 172 S.F.

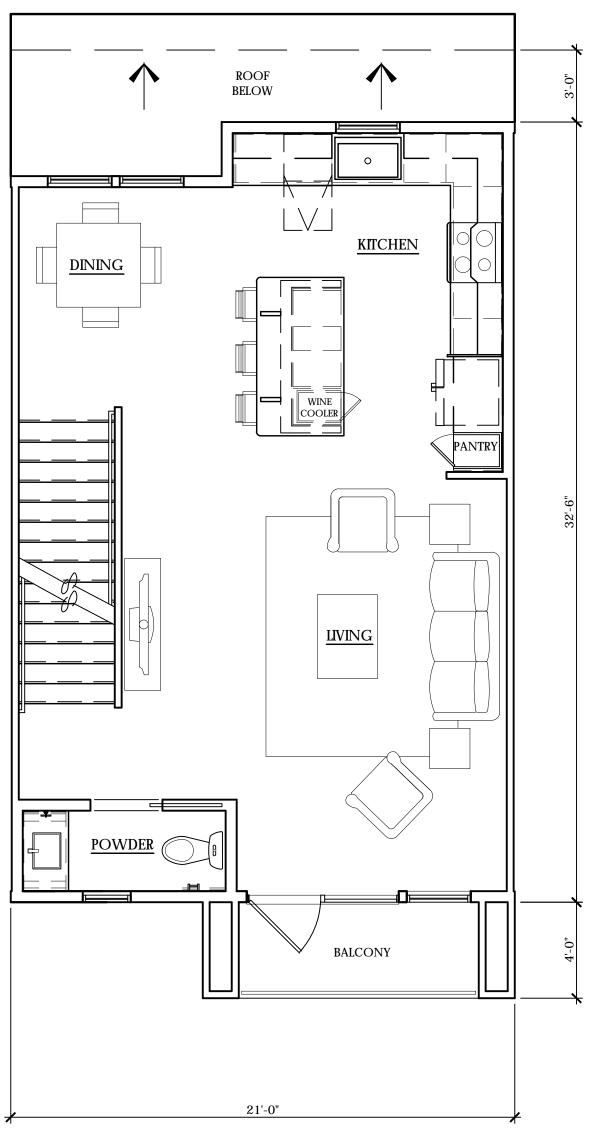

04 UNIT A 1-Level 02 SQUARE FOOTAGE: 663 S.F.

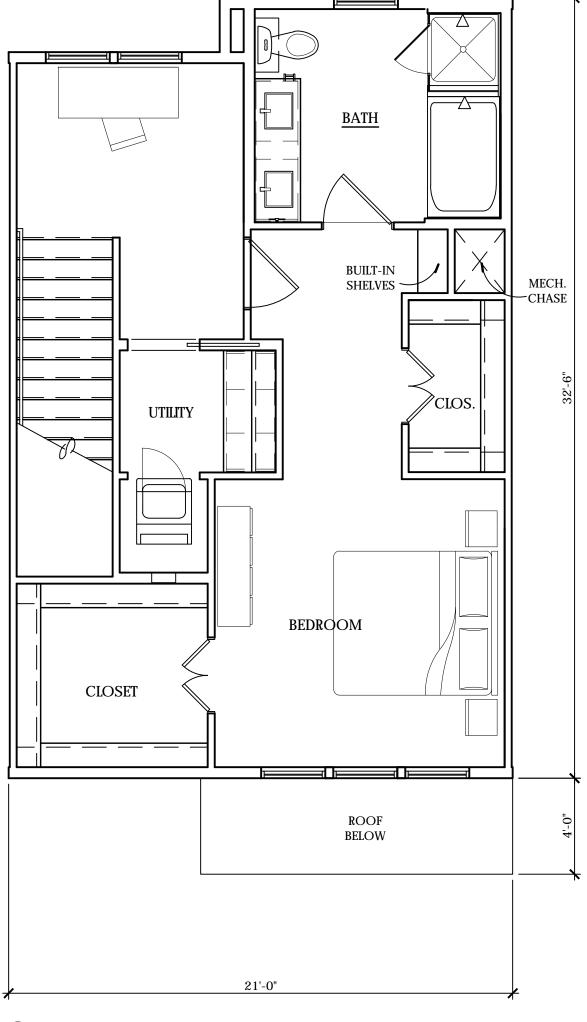

O6 UNIT A1-Level O3 square footage: 663 s.f.

SCALE: 1/4" = 1'-0" (22"X34" SHEET) TOTAL SQUARE FOOTAGE: 1,500 S.F.

VBarchitects

Wilder Belshaw Architects

D A L L A S o A U S T I N 3875 Ponte Ave Suite 410, Addison, TX 75001 1621 E. 6th Street Suite 1151, Austin, TX 78702 214-969-0500 phone o wilderbelshaw.com

VITRUVIAN TOWNHOMES


Addison, TX




UDR 3875 Ponte Ave, Suite 400 Addison, TX 75001 972.774.0552 phone


Sheet Number: <u>A201</u>

Issue Date: <u>07.30.21</u>

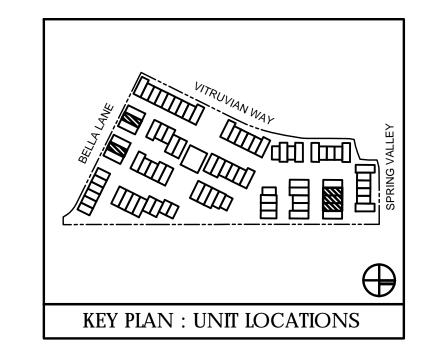


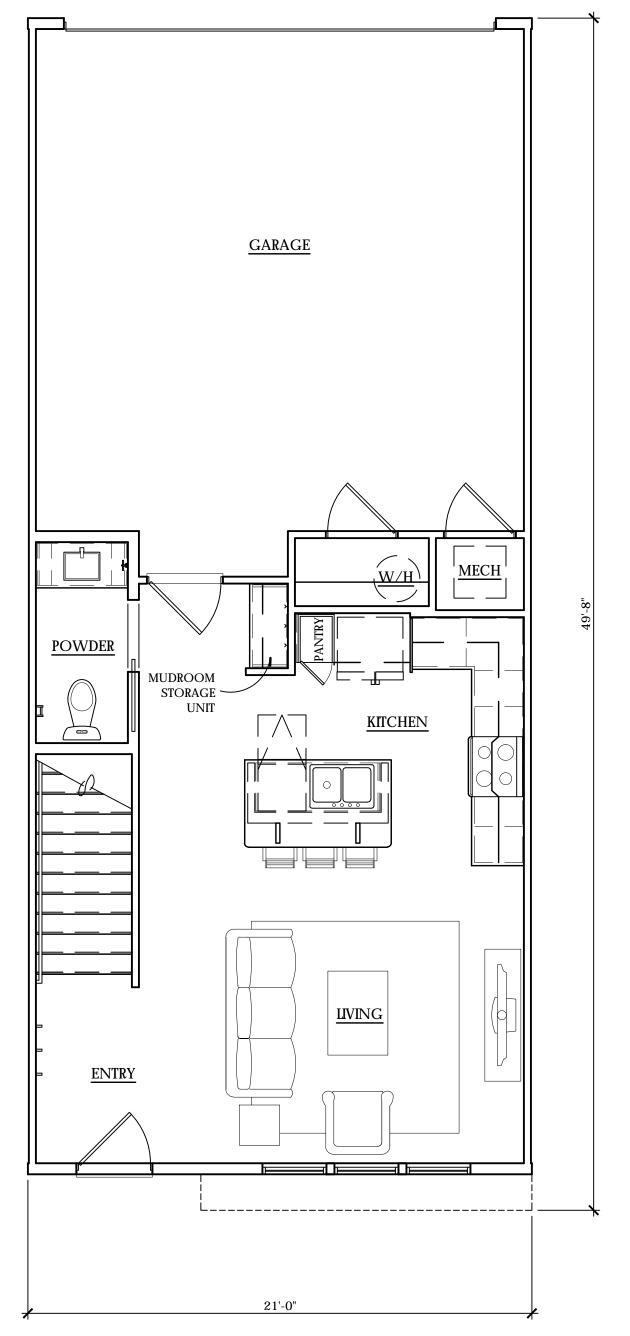

02 UNIT B1-Level 01 SQUARE FOOTAGE: 551 S.F.

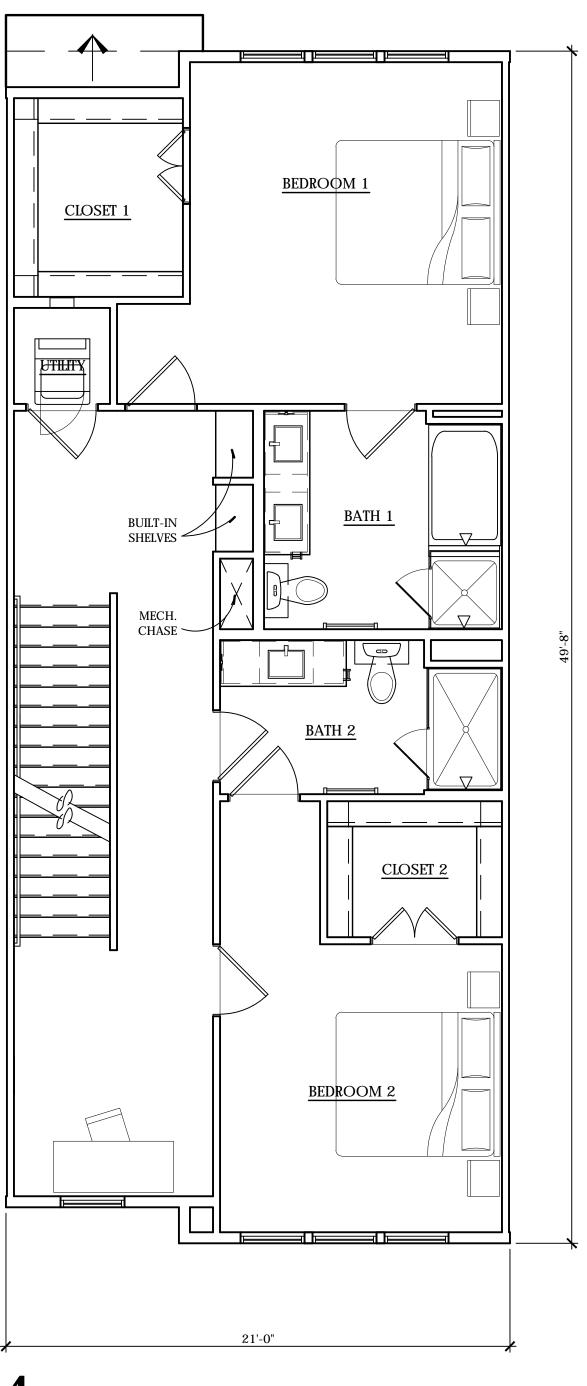

04 UNIT B1-Level 02 square footage: 1,021 S.F.

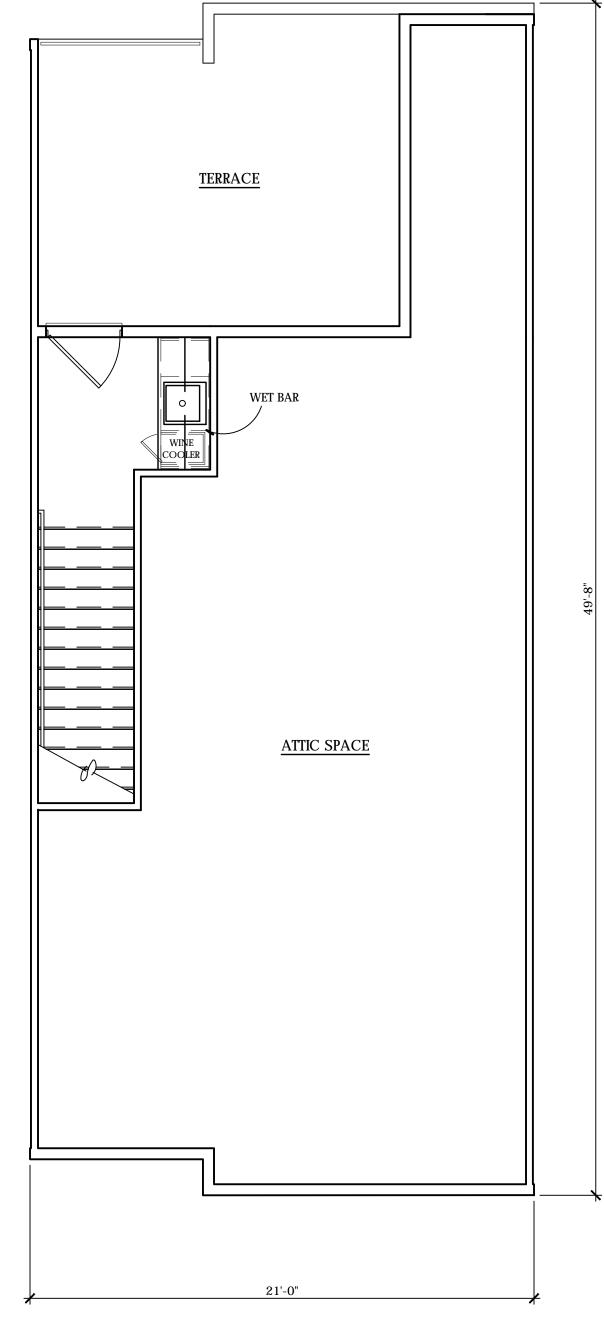

06 UNIT B1-Level 03 SQUARE FOOTAGE: 114 S.F.

SCALE: 1/4" = 1'-0" (22"X34" SHEET) TOTAL SQUARE FOOTAGE: 1,686 S.F.



Wilder Belshaw Architects

D A L L A S o A U S T I N 3875 Ponte Ave Suite 410, Addison, TX 75001 1621 E. 6th Street Suite 1151, Austin, TX 78702 214-969-0500 phone o wilderbelshaw.com


VITRUVIAN TOWNHOMES


Addison, TX




UDR 3875 Ponte Ave, Suite 400 Addison, TX 75001 972.774.0552 phone

Sheet Number: A202

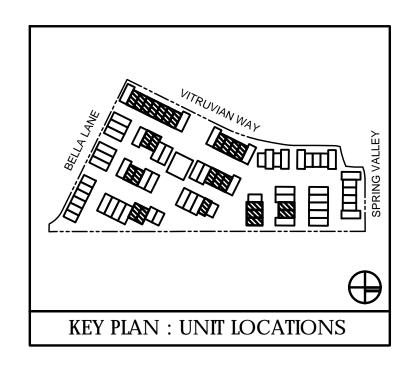


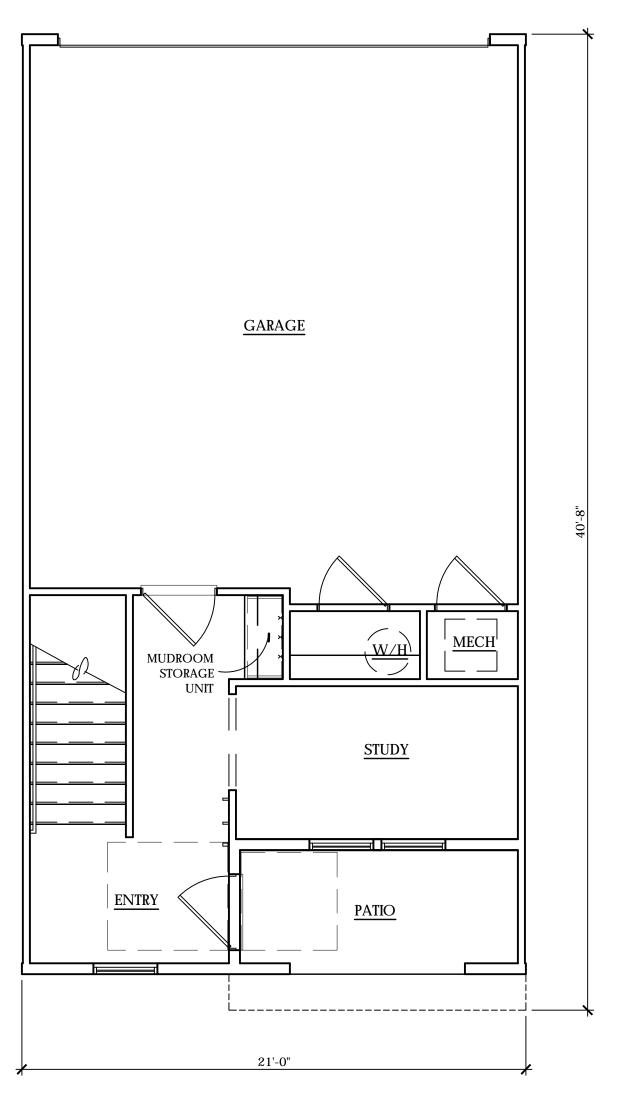

O2 UNIT B2-Level 01 SQUARE FOOTAGE:282 S.F.

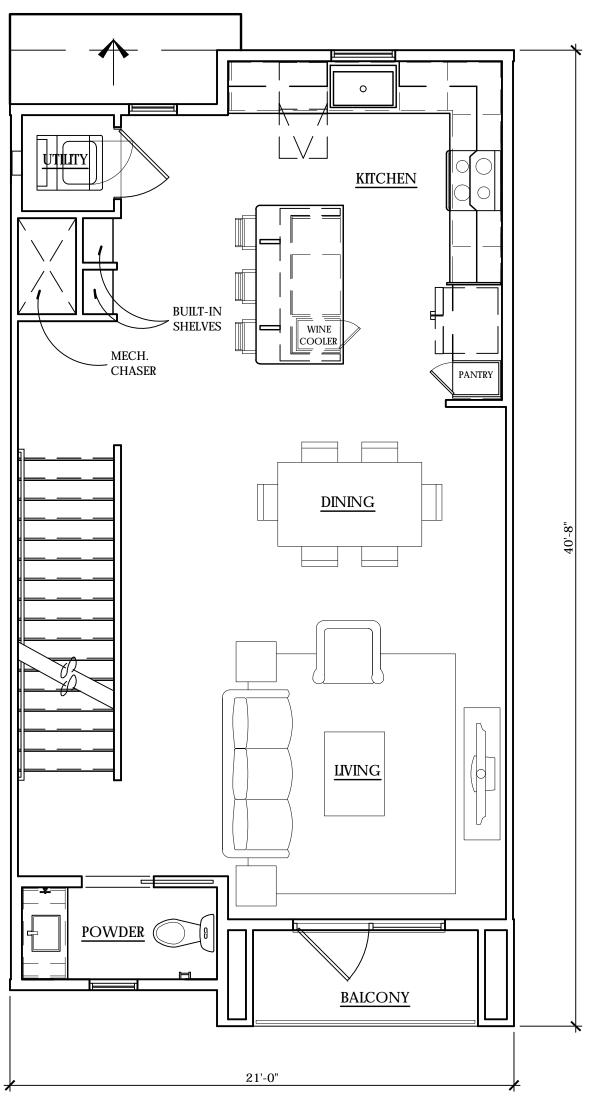

O4 UNIT B2-Level 02 SQUARE FOOTAGE:773 S.F.

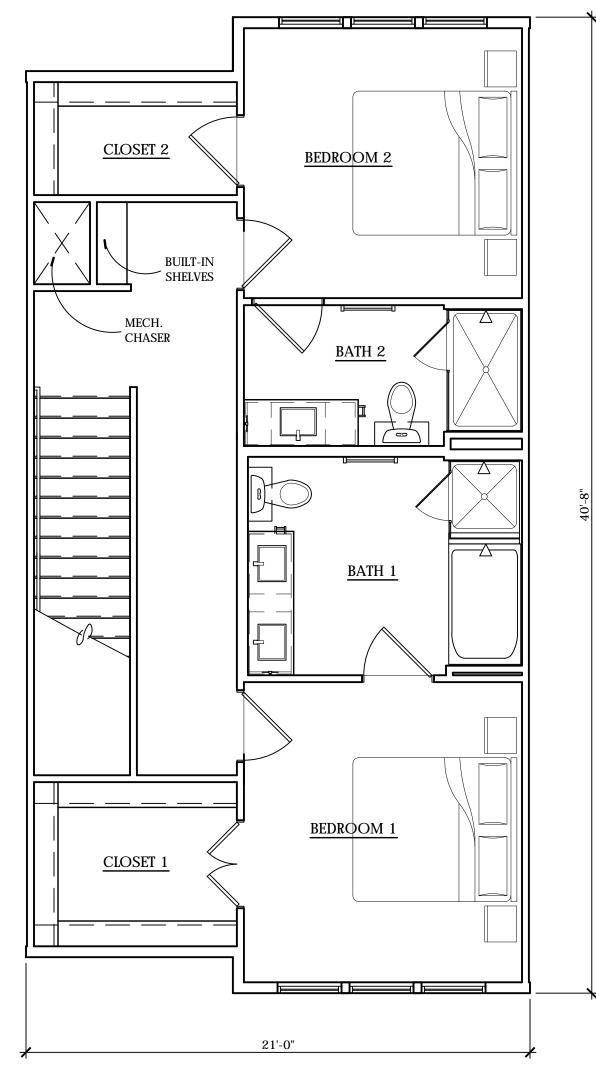

06 UNIT B2-Level 03 SQUARE FOOTAGE:822 S.F.

UNITS TOTAL SQUARE FOOTAGE: 1,880 S.F. SCALE: 1/4" = 1'-0" (22"X34" SHEET)



Wilder Belshaw Architects

214-969-0500 phone o wilderbelshaw.com


VITRUVIAN TOWNHOMES


Addison, TX





UDR 3875 Ponte Ave, Suite 400 Addison, TX 75001 972.774.0552 phone

A203 Sheet Number:

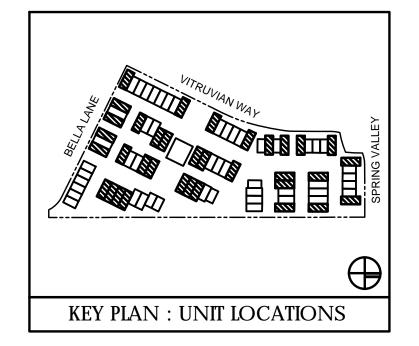

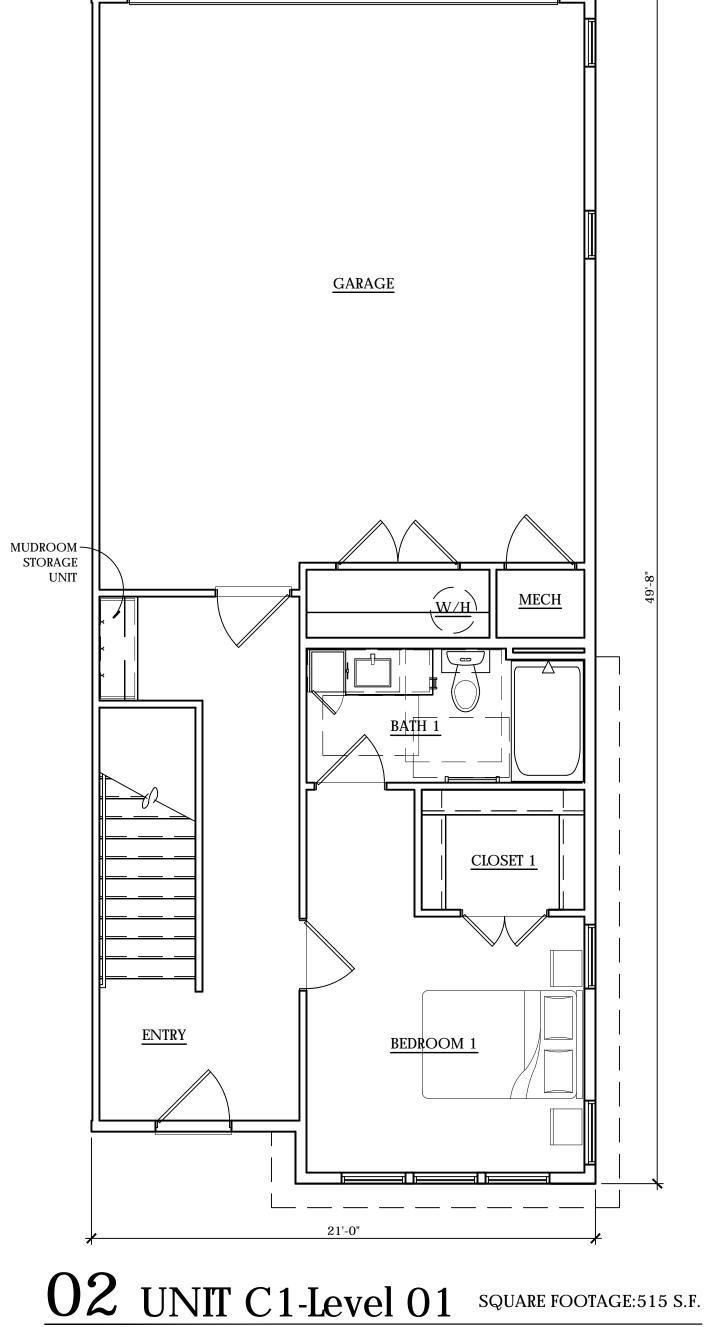

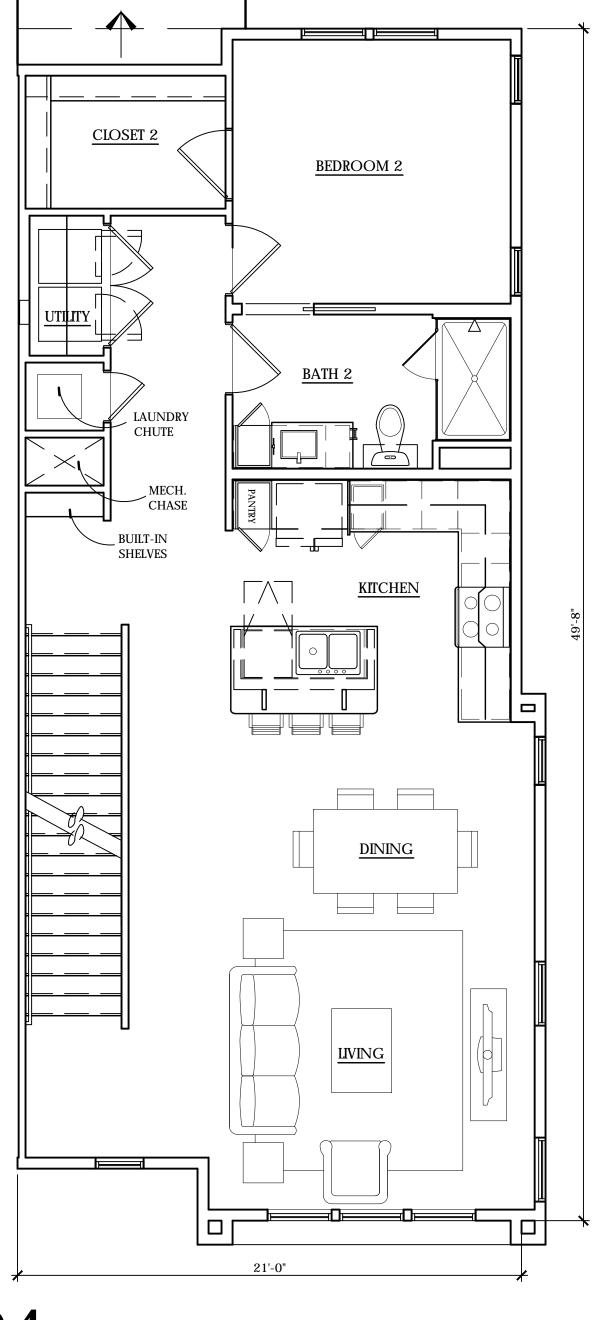

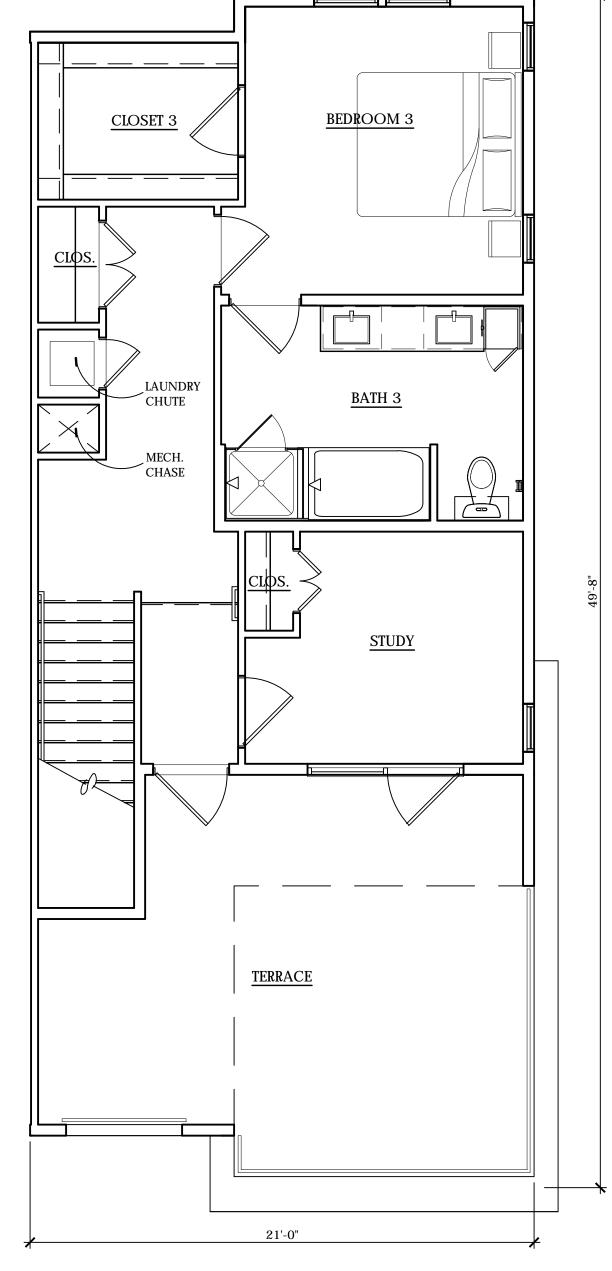

04 UNIT C1-Level 02 SQUARE FOOTAGE: 1,036 S.F.

UNITS

06 UNIT C1-Level 03 SQUARE FOOTAGE:698 S.F.

SCALE: 1/4" = 1'-0" (22"X34" SHEET)

214-969-0500 phone o wilderbelshaw.com

TOTAL SQUARE FOOTAGE:2,249 S.F.

VITRUVIAN TOWNHOMES


Addison, TX




- THIS FACADE PLAN IS FOR CONCEPTUAL PURPOSES ONLY.
ALL BUILDING PLANS REQUIRE REVIEW AND APPROVAL BY
DEVELOPMENT SERVICES


- ALL ROOF MECHANICAL UNITS SHALL BE SCREENED FROM PUBLIC VIEW AS REQUIRED BY THE ZONING ORDINANCE
- WHEN PERMITTED, EXPOSED UTILITY BOXES AND CONDUITS SHALL BE PAINTED TO MATCH THE BUILDING
- ALL SIGNAGE AREAS AND LOCATIONS ARE SUBJECT TO APPROVAL BY DEVELOPMENT SERVICES


- ROOF ACCESS SHALL BE PROVIDED INTERNALLY, UNLESS OTHERWISE PERMITTED BY THE CHIEF BUILDING OFFICIAL

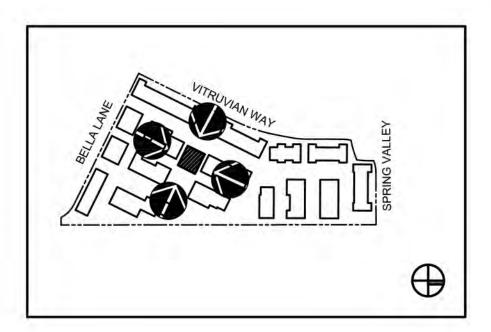

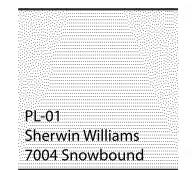




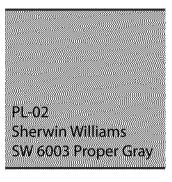

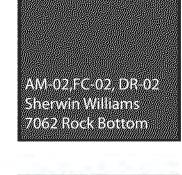



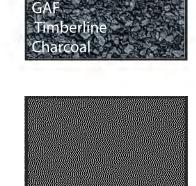

Sherwin Williams SW7048 Urban Bronze



AM-01, RF-02

Charcoal Grey

Berndoe XXNAR 500




Vitruvian Town Homes


Material Selection Summary Project Number: 1901

Material	Manufacturer	Color	Color System	Finish / Type	Location & Notes
Architec	tural Metal Finish ((Metal)			
AM-01	Berridge	Charcoal Grey	KYNAR 500	Standing Seam System	Standing seam metal wall panel (Cee-lock Panel)
AM-02	-	SW 7062 - Rock Bottom	Sherwin Williams		Metail Railings
Brick					
BR-01	ACME	Westchester	ACME	Velour Texture	Brick Veneer
Cementi	tious Panel (Fiber	Cement)			
FC-01	Woodtone	Aspen Ridge		RusticSeries	Lap siding
FC-02	James Hardie	SW 7062 - Rock Bottom	Sherwin Williams	Smooth	Lap siding
Portland	Cement Plaster (S	Stucco)			
PL-01	Sherwin Williams	SW 7004 - Snowbound	Sherwin Williams	Light Sand	
PL-02	Sherwin Williams	SW 6003 - Proper Gray	Sherwin Williams	Light Sand	
Roof					
RF-01	*GAF-Timberline	Charcoal		Shingle Roof	Sloped roofs
	Berridge	Charcoal Grey	KYNAR 500	Standing Seam System	Standing seam metal roof panel (Cee-lock Panel)
Door and	d Window Frames				
WD-01		Desert Sand	N/A	N/A	Vinyl Window Frames & Mullions
WD-02		Dark Bronze	N/A	N/A	Vinyl Window Frames & Mullions
WD-03		Dark Bronze	N/A	N/A	Storefront frames
DR-01	Sherwin Williams	SW 7048 - Urbane Bronze	Sherwin Williams		Residential Balcony Doors & Frames
DR-02	Sherwin Williams	SW 7062 - Rock Bottom	Sherwin Williams		Exit doors/ overhead doors/garage door

*GAF Timberline shingle product will have 50 year life

Please reference L102.1 for private yard/patio wall details. Material selection is provided below.

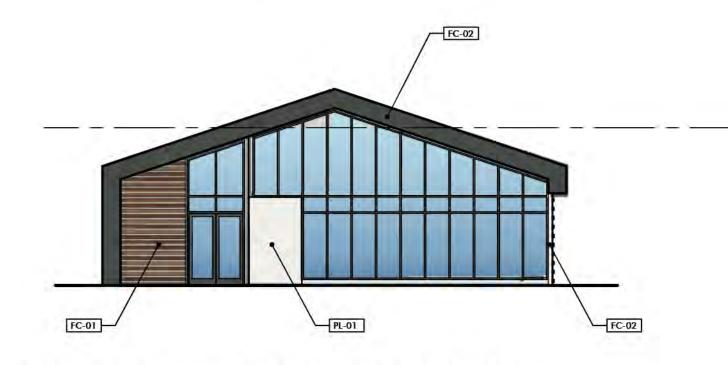

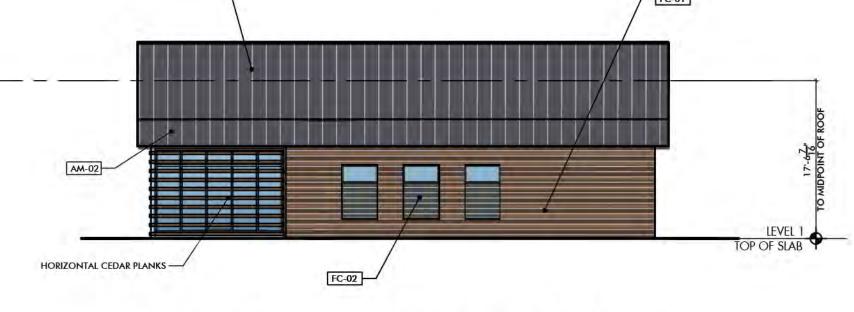

AMENITY - EAST ELEVATION

SCALE: 3/32" = 1'-0"


MATERIAL CALCULATIONS:
TOTAL SURFACE SF: 888sf

GLAZING: 582sf 65.5%
BRICK 0sf 0%
STUCCO 60sf 6.8%
METAL: 0sf 0%
FIBER CEMENT: 250sf 28.2%

AMENITY - NORTH ELEVATION

SCALE: 3/32" = 1'-0"

ATIONS:	
: 1,258sf	
182sf	14.5%
Osf	0%
Osf	0%
691sf	54.9%
421sf	33.5%
	182sf Osf Osf 691sf

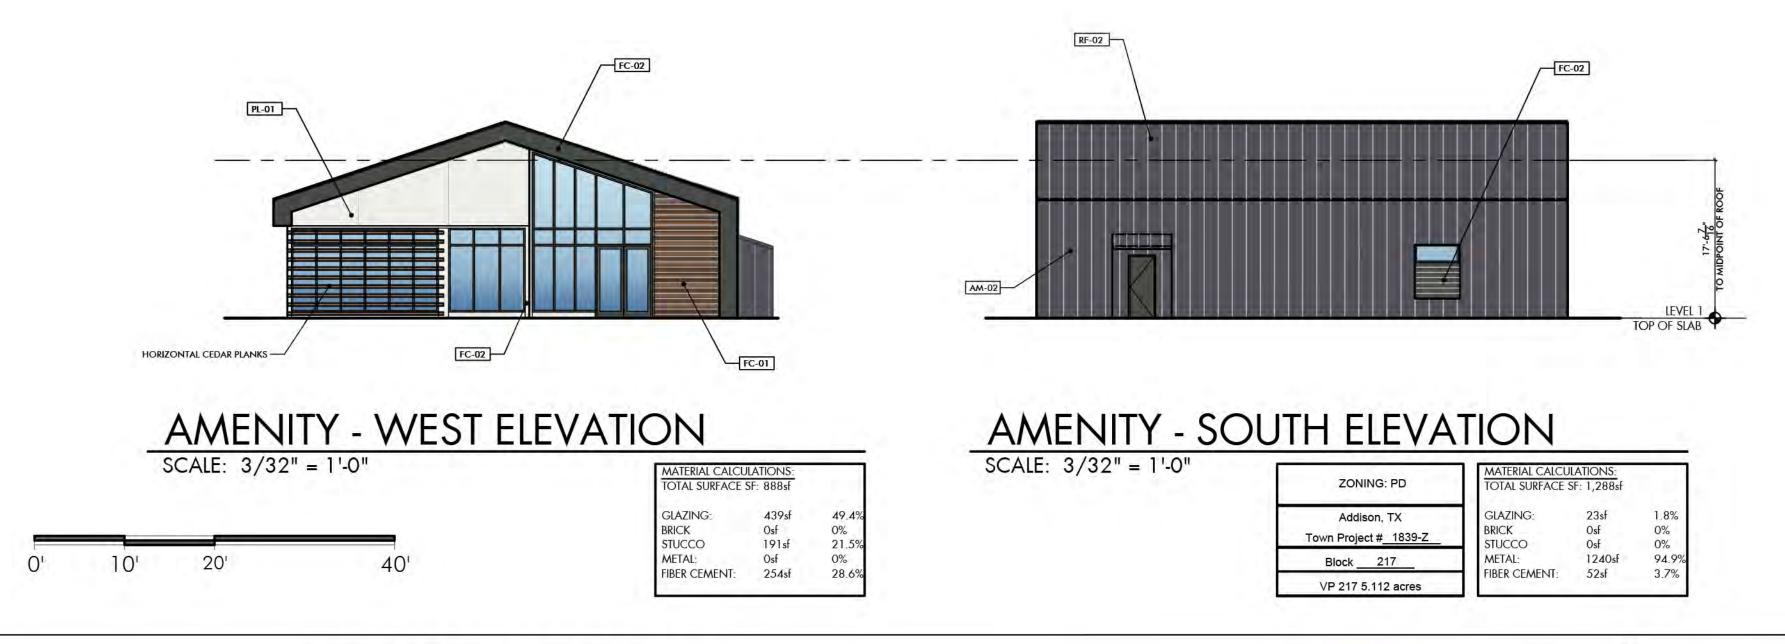



D A L L A S o A U S T I N 3875 Ponte Ave Suite 410, Addison, TX 75001 1621 E. 6th Street Suite 1151, Austin, TX 78702 214-969-0500 phone o wilderbelshaw.com



Issue Date: ____11.01.21





DEVELOPMENT SERVICES

- THIS FACADE PLAN IS FOR CONCEPTUAL PURPOSES ONLY ALL BUILDING PLANS REQUIRE REVIEW AND APPROVAL BY

D A L L A S o A U S T I N 3875 Ponte Ave Suite 410, Addison, TX 75001 1621 E. 6th Street Suite 1151, Austin, TX 78702 214-969-0500 phone o wilderbelshaw.com

VITRUVIAN TOWNHOMES Addison, TX



UDR Addison, TX 75001 972.774.0552 phone


A302 Sheet Number:

- THIS FACADE PLAN IS FOR CONCEPTUAL PURPOSES ONLY ALL BUILDING PLANS REQUIRE REVIEW AND APPROVAL BY DEVELOPMENT SERVICES

- ALL ROOF MECHANICAL UNITS SHALL BE SCREENED FROM PUBLIC VIEW AS REQUIRED BY THE ZONING ORDINANCE - WHEN PERMITTED, EXPOSED UTILITY BOXES AND CONDUITS SHALL BE PAINTED TO MATCH THE BUILDING


- ALL SIGNAGE AREAS AND LOCATIONS ARE SUBJECT TO APPROVAL BY DEVELOPMENT SERVICES


- ROOF ACCESS SHALL BE PROVIDED INTERNALLY, UNLESS OTHERWISE PERMITTED BY THE CHIEF BUILDING OFFICIAL

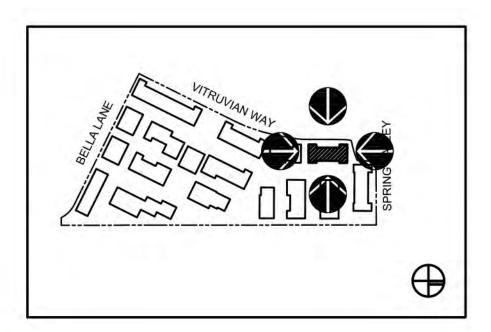







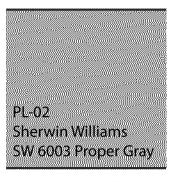


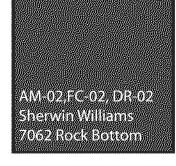



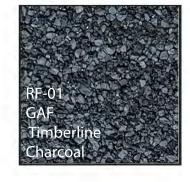

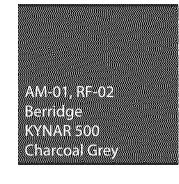

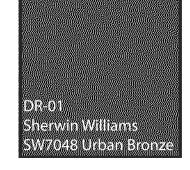









SCALE: 3/32" = 1'-0" MATERIAL CALCULATIONS: GLAZING: BRICK 459sf STUCCO 953sf METAL: 286sf 15.5% FIBER CEMENT:

SCALE: 3/32" = 1'-0"



NORTH ELEVATION (SPRING VALLEY ROAD) SCALE: 3/32" = 1'-0"

METAL: 286sf FIBER CEMENT: Osf

WEST ELEVATION (VITRUVIAN WAY)

SCALE: 3/32" = 1'-0"

ZONING: PD]
Addison, TX Town Project # 1839-Z	1
Block217	11
VP 217 5.112 acres	1

TERIAL CALCULATIONS: TAL SURFACE SF: 3,467sf 849sf 1,300sf 173sf R CEMENT: 485sf

MATERIAL CALCULATIONS:

FIBER CEMENT: 99sf

546sf

638sf

559sf

1,447sf

44%

GLAZING:

STUCCO

METAL:

Wilder Belshaw Architects WB

D A L L A S o A U S T I N 3875 Ponte Ave Suite 410, Addison, TX 75001 1621 E. 6th Street Suite 1151, Austin, TX 78702 214-969-0500 phone o wilderbelshaw.com

VITRUVIAN TOWNHOMES Addison, TX



UDR 3875 Ponte Ave, Suite 400 Addison, TX 75001 972.774.0552 phone


A303 Sheet Number:


- THIS FACADE PLAN IS FOR CONCEPTUAL PURPOSES ONLY.
ALL BUILDING PLANS REQUIRE REVIEW AND APPROVAL BY
DEVELOPMENT SERVICES

- ALL ROOF MECHANICAL UNITS SHALL BE SCREENED FROM PUBLIC VIEW AS REQUIRED BY THE ZONING ORDINANCE
- WHEN PERMITTED, EXPOSED UTILITY BOXES AND CONDUITS SHALL BE PAINTED TO MATCH THE BUILDING


CONDUITS SHALL BE PAINTED TO MATCH THE BUILDING
- ALL SIGNAGE AREAS AND LOCATIONS ARE SUBJECT TO
APPROVAL BY DEVELOPMENT SERVICES


- ROOF ACCESS SHALL BE PROVIDED INTERNALLY, UNLESS OTHERWISE PERMITTED BY THE CHIEF BUILDING OFFICIAL

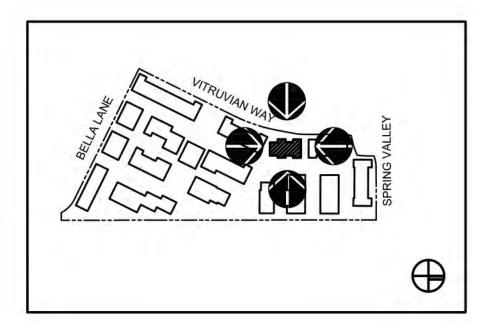

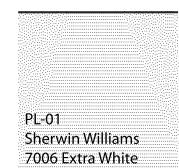




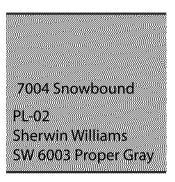


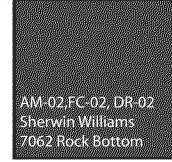






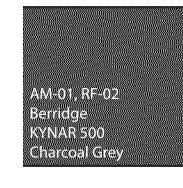


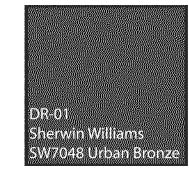





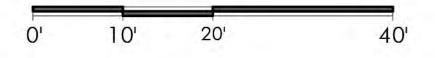

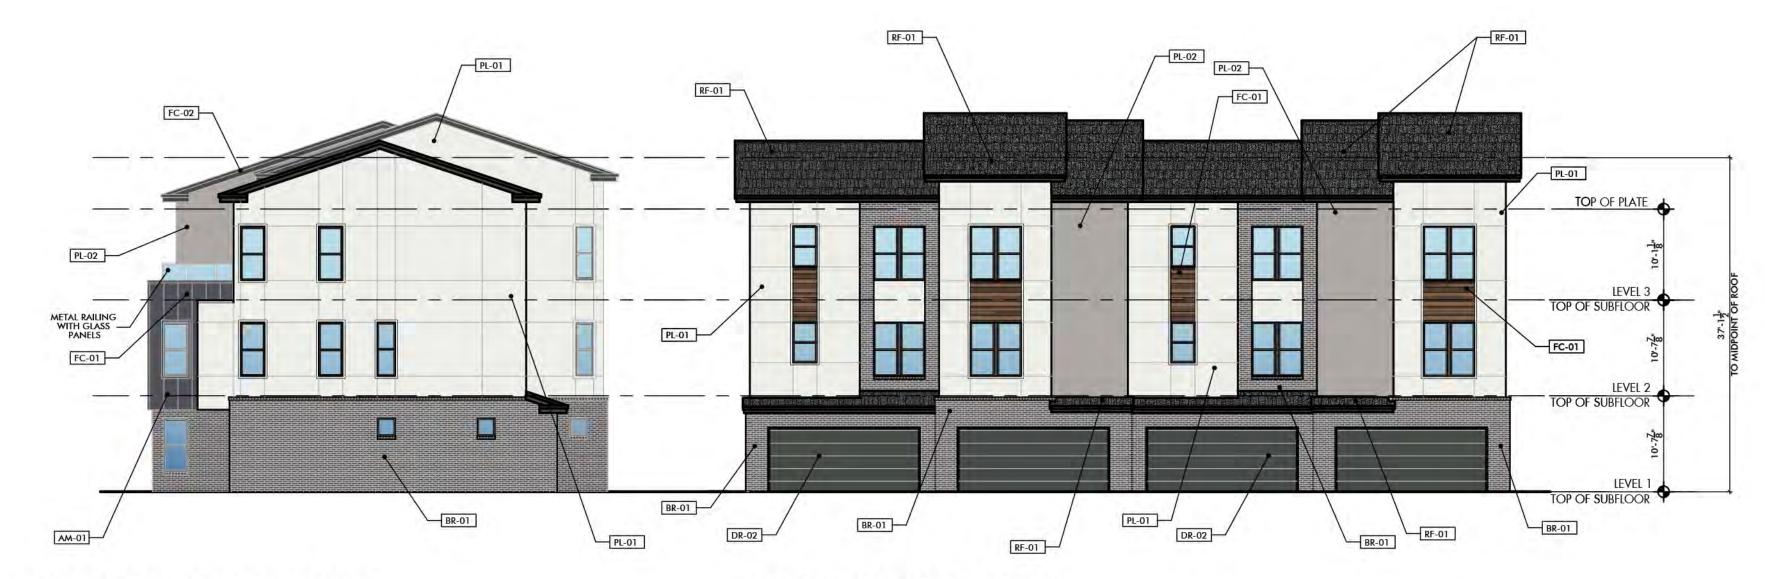

SOUTH ELEVATION

EAST ELEVATION



NORTH ELEVATION SCALE: 3/32" = 1'-0"

/32" = 1'-0" MATERIA TOTAL S

MATERIAL CALCULATIONS:
TOTAL SURFACE SF: 1,843sf

GLAZING: 144sf 7.8%
BRICK 459sf 24.9%
STUCCO 953sf 51.7%
METAL: 286sf 15.5%
FIBER CEMENT: 0sf 0%

WEST ELEVATION (VITRUVIAN WAY)

SCALE: 3/32" = 1'-0"

MATERIAL CALCULATIONS:
TOTAL SURFACE SF: 2,778sf

GLAZING: 528sf 19%
BRICK 611sf 22%
STUCCO 1083sf 39%
METAL: 164sf 5.9%
FIBER CEMENT: 392sf 14.1%

Wilder Belshaw Architects

D A L L A S o A U S T I N 3875 Ponte Ave Suite 410, Addison, TX 75001 1621 E. 6th Street Suite 1151, Austin, TX 78702 214-969-0500 phone o wilderbelshaw.com

VITRUVIAN TOWNHOMES

Addison, TX



UDR 3875 Ponte Ave, Suite 400 Addison, TX 75001 972.774.0552 phone

Sheet Number: A304


Issue Date: 11.01.21


WB


- THIS FACADE PLAN IS FOR CONCEPTUAL PURPOSES ONLY ALL BUILDING PLANS REQUIRE REVIEW AND APPROVAL BY DEVELOPMENT SERVICES

- ALL ROOF MECHANICAL UNITS SHALL BE SCREENED FROM PUBLIC VIEW AS REQUIRED BY THE ZONING ORDINANCE - WHEN PERMITTED, EXPOSED UTILITY BOXES AND CONDUITS SHALL BE PAINTED TO MATCH THE BUILDING - ALL SIGNAGE AREAS AND LOCATIONS ARE SUBJECT TO


APPROVAL BY DEVELOPMENT SERVICES

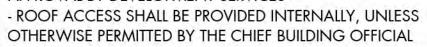


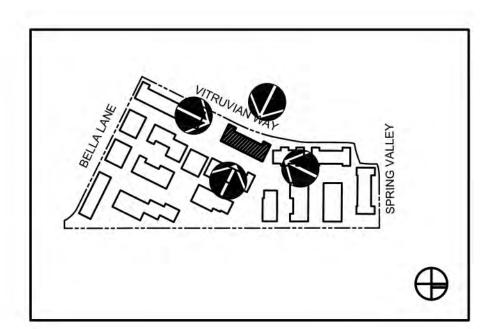

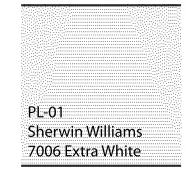




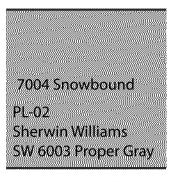

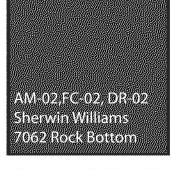





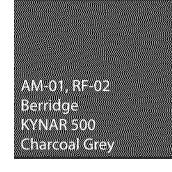





Sherwin Williams SW7048 Urban Bronze



SOUTH ELEVATION (MAIN ENTRY)

MATERIAL CALCULATIONS: GLAZING: 144sf BRICK 459sf 953sf STUCCO METAL: 286sf 15.5% FIBER CEMENT:

EAST ELEVATION

SCALE: 3/32" = 1'-0" MATERIAL CALCULATIONS: GLAZING: STUCCO METAL: FIBER CEMENT:



NORTH ELEVATION

SCALE: 3/32" = 1'-0"

SCALE: 3/32" = 1'-0"

MATERIAL CALCULATIONS: TOTAL SURFACE SF: 1,843sf 144sf 459sf 953sf 286sf Osf GLAZING: BRICK STUCCO METAL: FIBER CEMENT:

WEST ELEVATION (VITRUVIAN WAY)

SCALE: 3/32" = 1'-0"

ZONING: PD Addison, TX Town Project # 1839-Z Block 217 VP 217 5.112 acres

766sf 1,375sf 1,420sf STUCCO METAL: 128sf FIBER CEMENT: 553sf

518sf

486sf

726sf

52sf

2,456sf

59% 17.4%



Wilder Belshaw Architects

3875 Ponte Ave Suite 410, Addison, TX 75001 1621 E. 6th Street Suite 1151, Austin, TX 78702 214-969-0500 phone o wilderbelshaw.com

VITRUVIAN TOWNHOMES Addison, TX



UDR Addison, TX 75001 972.774.0552 phone

A305 Sheet Number:



3875 Ponte Ave Suite 410, Addison, TX 75001 1621 E. 6th Street Suite 1151, Austin, TX 78702 214-969-0500 phone o wilderbelshaw.com

Addison, TX




UDR Addison, TX 75001 972.774.0552 phone


A306 Sheet Number:

- THIS FACADE PLAN IS FOR CONCEPTUAL PURPOSES ONLY ALL BUILDING PLANS REQUIRE REVIEW AND APPROVAL BY DEVELOPMENT SERVICES


- ALL ROOF MECHANICAL UNITS SHALL BE SCREENED FROM PUBLIC VIEW AS REQUIRED BY THE ZONING ORDINANCE - WHEN PERMITTED, EXPOSED UTILITY BOXES AND CONDUITS SHALL BE PAINTED TO MATCH THE BUILDING - ALL SIGNAGE AREAS AND LOCATIONS ARE SUBJECT TO APPROVAL BY DEVELOPMENT SERVICES


- ROOF ACCESS SHALL BE PROVIDED INTERNALLY, UNLESS OTHERWISE PERMITTED BY THE CHIEF BUILDING OFFICIAL

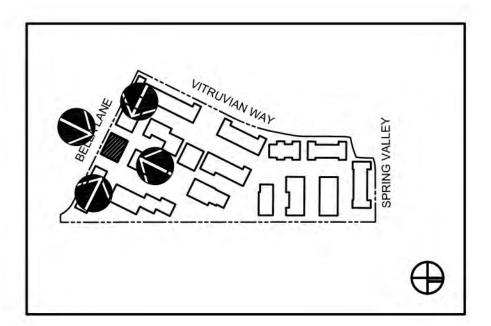

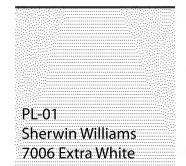




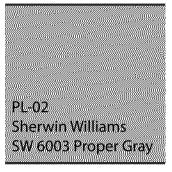


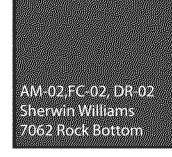





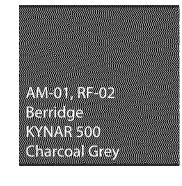

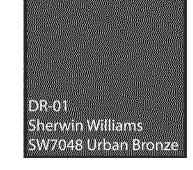










SCALE: 3/32" = 1'-0" MATERIAL CALCULATIONS: GLAZING: BRICK 144sf 459sf 953sf STUCCO 286sf Osf METAL: FIBER CEMENT:

SCALE: 3/32" = 1'-0" MATERIAL CALCULATIONS: GLAZING: 351sf 265sf STUCCO 993sf METAL: 343sf FIBER CEMENT:

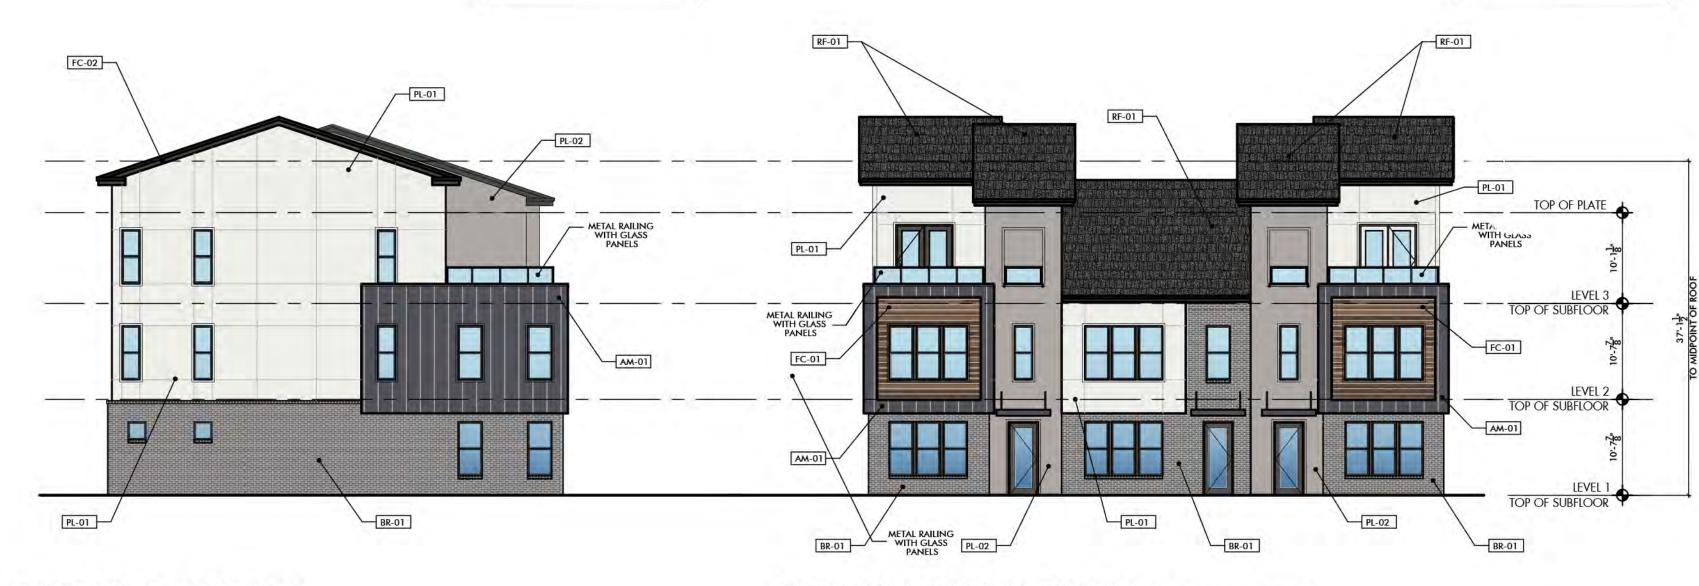

WEST ELEVATION SCALE: 3/32" = 1'-0"

MATERIAL CALCULATIONS: TOTAL SURFACE SF: 1,843sf 144sf 459sf 953sf 286sf Osf GLAZING: BRICK STUCCO METAL: FIBER CEMENT:

SOUTH ELEVATION (BELLA LANE)

SCALE: 3/32" = 1'-0"

ZONING: PD	MA [*] TOT
Addison, TX Town Project #_ 1839-Z	GLA BRIC STU
Block217	MET
VP 217 5.112 acres	FIBE

ATERIAL CALCULATIONS: TAL SURFACE SF: 1,891sf 330sf UCCO 791sf NETAL: 168sf BER CEMENT: 171sf

Wilder Belshaw Architects WB





THIS FACADE PLAN IS FOR CONCEPTUAL PURPOSES ONLY. ALL BUILDING PLANS REQUIRE REVIEW AND APPROVAL BY DEVELOPMENT SERVICES

- ALL ROOF MECHANICAL UNITS SHALL BE SCREENED FROM PUBLIC VIEW AS REQUIRED BY THE ZONING ORDINANCE - WHEN PERMITTED, EXPOSED UTILITY BOXES AND CONDUITS SHALL BE PAINTED TO MATCH THE BUILDING - ALL SIGNAGE AREAS AND LOCATIONS ARE SUBJECT TO


- ROOF ACCESS SHALL BE PROVIDED INTERNALLY, UNLESS OTHERWISE PERMITTED BY THE CHIEF BUILDING OFFICIAL


APPROVAL BY DEVELOPMENT SERVICES

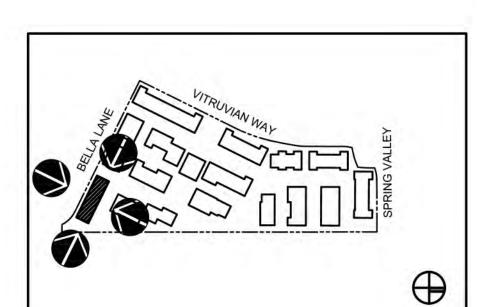

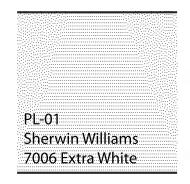




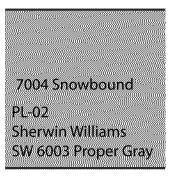

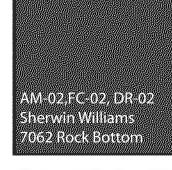



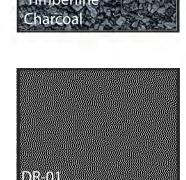

Sherwin Williams SW7048 Urban Bronze



AM-01 RF-02

Charcoal Grey

Berridge KNAR 500



0' 10'



EAST ELEVATION

SCALE: 3/32" = 1'-0"

MATERIAL CALCULATIONS: TOTAL SURFACE SF: 1,296sf GLAZING: BRICK 406sf 733sf STUCCO METAL: FIBER CEMENT: 63sf

NORTH ELEVATION

SCALE: 3/32" = 1'-0"

MATERIAL CALCULATIONS: GLAZING: 533sf BRICK 953sf STUCCO 1,505sf METAL: 724sf FIBER CEMENT: 95sf 2.5%



WEST ELEVATION SCALE: 3/32" = 1'-0"

OTAL SURFACE SF: 1,296sf 6.8% 31.3% 56.6% 0% 4.9% 406sf 733sf STUCCO Osf 63sf METAL: FIBER CEMENT:

SOUTH ELEVATION (BELLA LANE)

SCALE: 3/32" = 1'-0"

ZONING: PD Addison, TX Town Project # 1839-2 Block 217 VP 217 5.112 acres

1,418sf STUCCO 1,250sf METAL: FIBER CEMENT: 714sf



Wilder Belshaw Architects


DALLAS o AUSTIN 3875 Ponte Ave Suite 410, Addison, TX 75001 1621 E. 6th Street Suite 1151, Austin, TX 78702 214-969-0500 phone o wilderbelshaw.com


VITRUVIAN TOWNHOMES Addison, TX



UDR 3875 Ponte Ave, Suite 400 Addison, TX 75001 972.774.0552 phone


A308 Sheet Number:

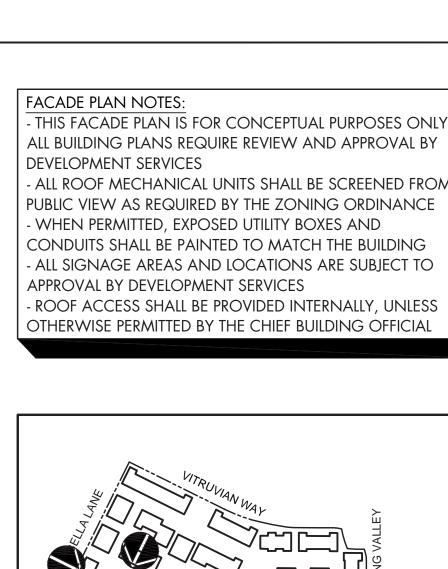


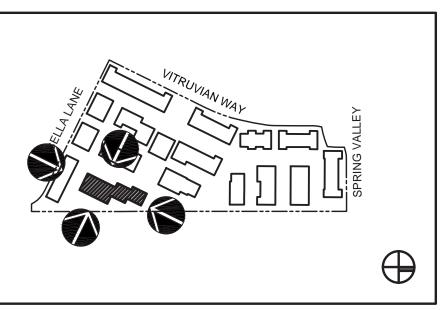





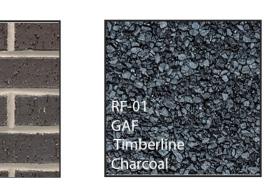

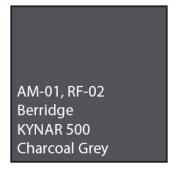





SW7048 Urban Bronze

DR-01, AM-02



NORTH ELEVATION

SCALE: 3/32" = 1'-0" TOTAL SURFACE SF: 1,783sf

MATERIAL CALCULATIONS: 498sf 1,209sf Osf 27.9% STUCCO 67.8% 0% 0% FIBER CEMENT: Osf

WEST ELEVATION

SCALE: 3/32" = 1'-0"

MATERIAL CALCULATIONS: TOTAL SURFACE SF: 5,410sf 811sf 15% 2,759sf 865sf 51% 16% STUCCO FIBER CEMENT: 135sf 2.5%



SOUTH ELEVATION SCALE: 3/32" = 1'-0"

MATERIAL CALCULATIONS: TOTAL SURFACE SF: 1,843sf GLAZING: 144sf BRICK 459sf STUCCO 953sf METAL: 286sf FIBER CEMENT: 0sf 24.9% 51.7% 15.5% 0%

EAST ELEVATION SCALE: 3/32" = 1'-0"

ZONING: PD] [<u>^</u>
Addison, TX	
Town Project #_ 1839-Z_	■ B
Block217	۱۱۸
VP 217 5.112 acres	1

MATERIAL CALCULATIONS: OTAL SURFACE SF: 5,581sf 1,828sf 1,900sf 172sf STUCCO 34% 3.1% METAL: 628sf FIBER CEMENT:



Wilder Belshaw Architects

3875 Ponte Ave Suite 410, Addison, TX 75001 1621 E. 6th Street Suite 1151, Austin, TX 78702 214-969-0500 phone o wilderbelshaw.com

VITRUVIAN TOWNHOMES

Addison, TX




UDR Addison, TX 75001 972.774.0552 phone


A309 Sheet Number:

- THIS FACADE PLAN IS FOR CONCEPTUAL PURPOSES ONLY ALL BUILDING PLANS REQUIRE REVIEW AND APPROVAL BY DEVELOPMENT SERVICES


- ALL ROOF MECHANICAL UNITS SHALL BE SCREENED FROM PUBLIC VIEW AS REQUIRED BY THE ZONING ORDINANCE - WHEN PERMITTED, EXPOSED UTILITY BOXES AND CONDUITS SHALL BE PAINTED TO MATCH THE BUILDING - ALL SIGNAGE AREAS AND LOCATIONS ARE SUBJECT TO APPROVAL BY DEVELOPMENT SERVICES


- ROOF ACCESS SHALL BE PROVIDED INTERNALLY, UNLESS OTHERWISE PERMITTED BY THE CHIEF BUILDING OFFICIAL

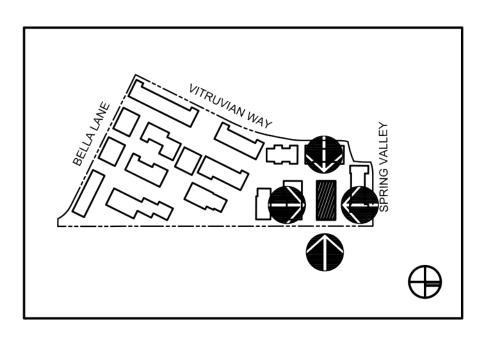

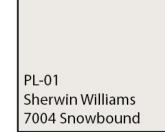



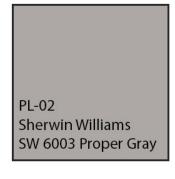

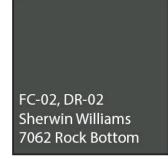
















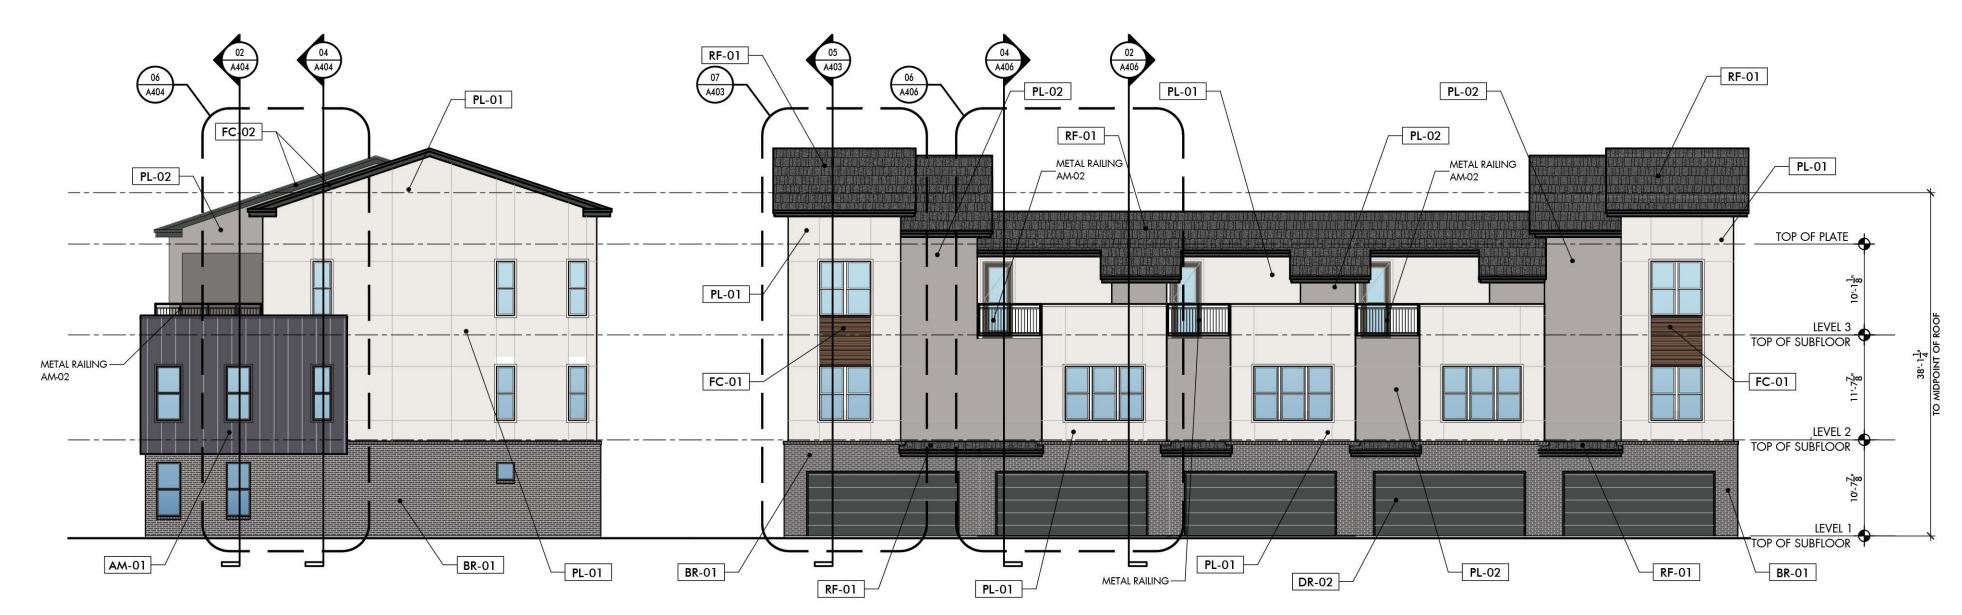



SCALE: 3/32" = 1'-0" MATERIAL CALCULATIONS: TOTAL SURFACE SF: 1,843sf 24.99

NORTH ELEVATION



WEST ELEVATION

SCALE: 3/32" = 1'-0"

MATERIAL CALCULATIONS: TOTAL SURFACE SF: 1,843sf 144sf 459sf 953sf 286sf Osf 24.9% 51.7% 15.5% STUCCO METAL: FIBER CEMENT:

SOUTH ELEVATION

SCALE: 3/32" = 1'-0"

ZONING: PD	TO
Addison, TX	GL
Town Project # <u>1839-Z</u>	BRI STU
Block <u>217</u>	ME
VP 217 5.112 acres	FIB

ATERIAL CALCULATIONS: DTAL SURFACE SF: 2,792sf 705sf 700sf 1,029sf 176sf 36.9% 6.3% UCCO 198sf IBER CEMENT:

MATERIAL CALCULATIONS: TOTAL SURFACE SF: 2,812sf



Wilder Belshaw Architects


D A L L A S o A U S T I N 3875 Ponte Ave Suite 410, Addison, TX 75001 1621 E. 6th Street Suite 1151, Austin, TX 78702 214-969-0500 phone o wilderbelshaw.com





- THIS FACADE PLAN IS FOR CONCEPTUAL PURPOSES ONLY ALL BUILDING PLANS REQUIRE REVIEW AND APPROVAL BY DEVELOPMENT SERVICES


- ALL ROOF MECHANICAL UNITS SHALL BE SCREENED FROM PUBLIC VIEW AS REQUIRED BY THE ZONING ORDINANCE - WHEN PERMITTED, EXPOSED UTILITY BOXES AND CONDUITS SHALL BE PAINTED TO MATCH THE BUILDING - ALL SIGNAGE AREAS AND LOCATIONS ARE SUBJECT TO APPROVAL BY DEVELOPMENT SERVICES


- ROOF ACCESS SHALL BE PROVIDED INTERNALLY, UNLESS OTHERWISE PERMITTED BY THE CHIEF BUILDING OFFICIAL

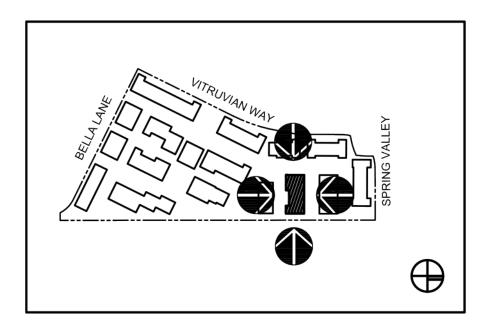

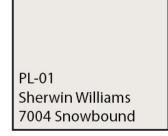

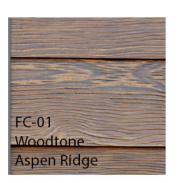

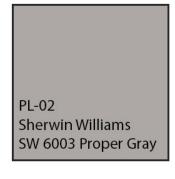

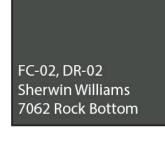








Patio Wall

80% of mix

Limestone


Antique Brushed

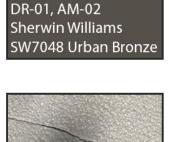



Brushhammer Finish

10'

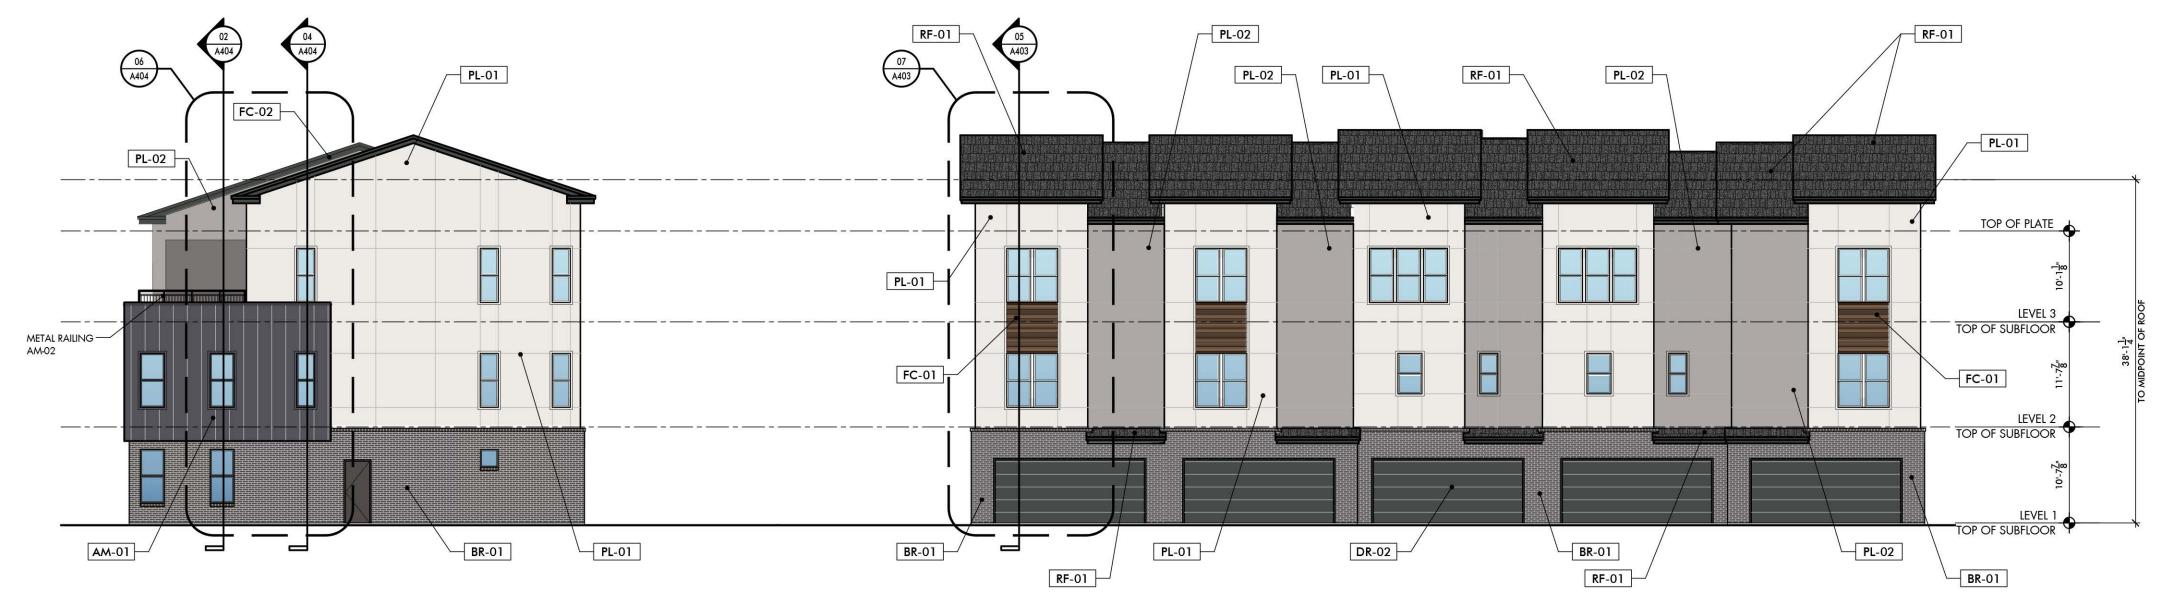

WEST ELEVATION

SCALE: 3/32" = 1'-0"

ATERIAL CALCULATIONS: 459sf 953sf 286sf 24.9% STUCCO 51.7% METAL: 15.59 FIBER CEMENT: Osf 0%

7.8% 24.9%

51.79 15.59 0%

SOUTH ELEVATION

SCALE: 3/32" = 1'-0"

MATERIAL CALCULATIONS: 416sf BRICK STUCCO METAL: 1,850sf 52.4% 605sf 72sf FIBER CEMENT:



EAST ELEVATION SCALE: 3/32" = 1'-0"

MATERIAL CALCULATIONS: OTAL SURFACE SF: 1,843sf 144sf 459sf 953sf STUCCO METAL: 286sf FIBER CEMENT: Osf

SCALE: 3/32" = 1'-0"

ZONING: PD
Addison, TX
Town Project #1839-Z
Block217
VP 217 5.112 acres
VI 217 3.112 acres

OTAL SURFACE SF: 3,545sf 1,050sf STUCCO 1,300sf METAL: 168sf FIBER CEMENT: 390sf

Wilder Belshaw Architects

D A L L A S o A U S T I N 3875 Ponte Ave Suite 410, Addison, TX 75001 1621 E. 6th Street Suite 1151, Austin, TX 78702 214-969-0500 phone o wilderbelshaw.com

VITRUVIAN TOWNHOMES Addison, TX



UDR 3875 Ponte Ave, Suite 400 Addison, TX 75001


972.774.0552 phone

A311 Sheet Number:

- THIS FACADE PLAN IS FOR CONCEPTUAL PURPOSES ONLY. ALL BUILDING PLANS REQUIRE REVIEW AND APPROVAL BY DEVELOPMENT SERVICES


- ALL ROOF MECHANICAL UNITS SHALL BE SCREENED FROM PUBLIC VIEW AS REQUIRED BY THE ZONING ORDINANCE
- WHEN PERMITTED, EXPOSED UTILITY BOXES AND CONDUITS SHALL BE PAINTED TO MATCH THE BUILDING
- ALL SIGNAGE AREAS AND LOCATIONS ARE SUBJECT TO APPROVAL BY DEVELOPMENT SERVICES


- ROOF ACCESS SHALL BE PROVIDED INTERNALLY, UNLESS OTHERWISE PERMITTED BY THE CHIEF BUILDING OFFICIAL

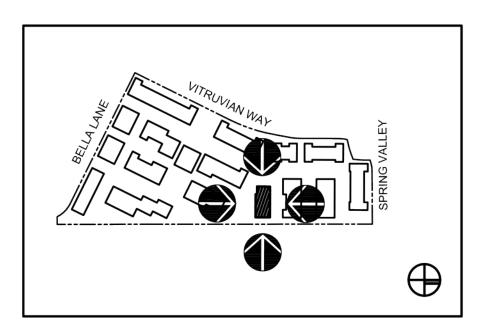






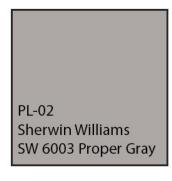

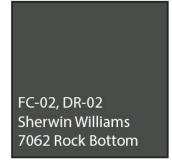



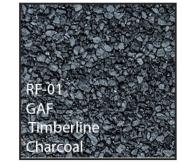











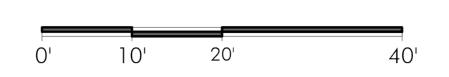


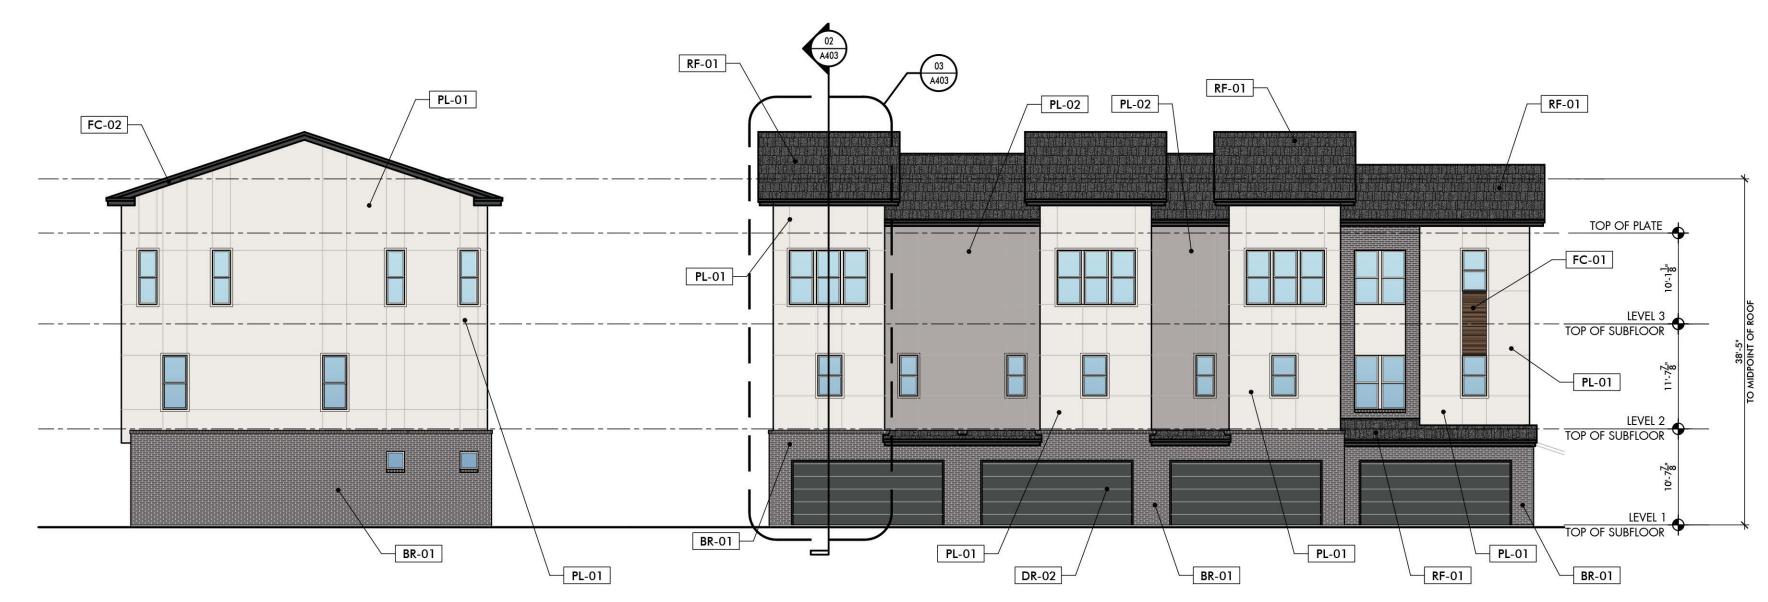

EAST ELEVATION

SCALE: 3/32" = 1'-0"

NORTH ELEVATION

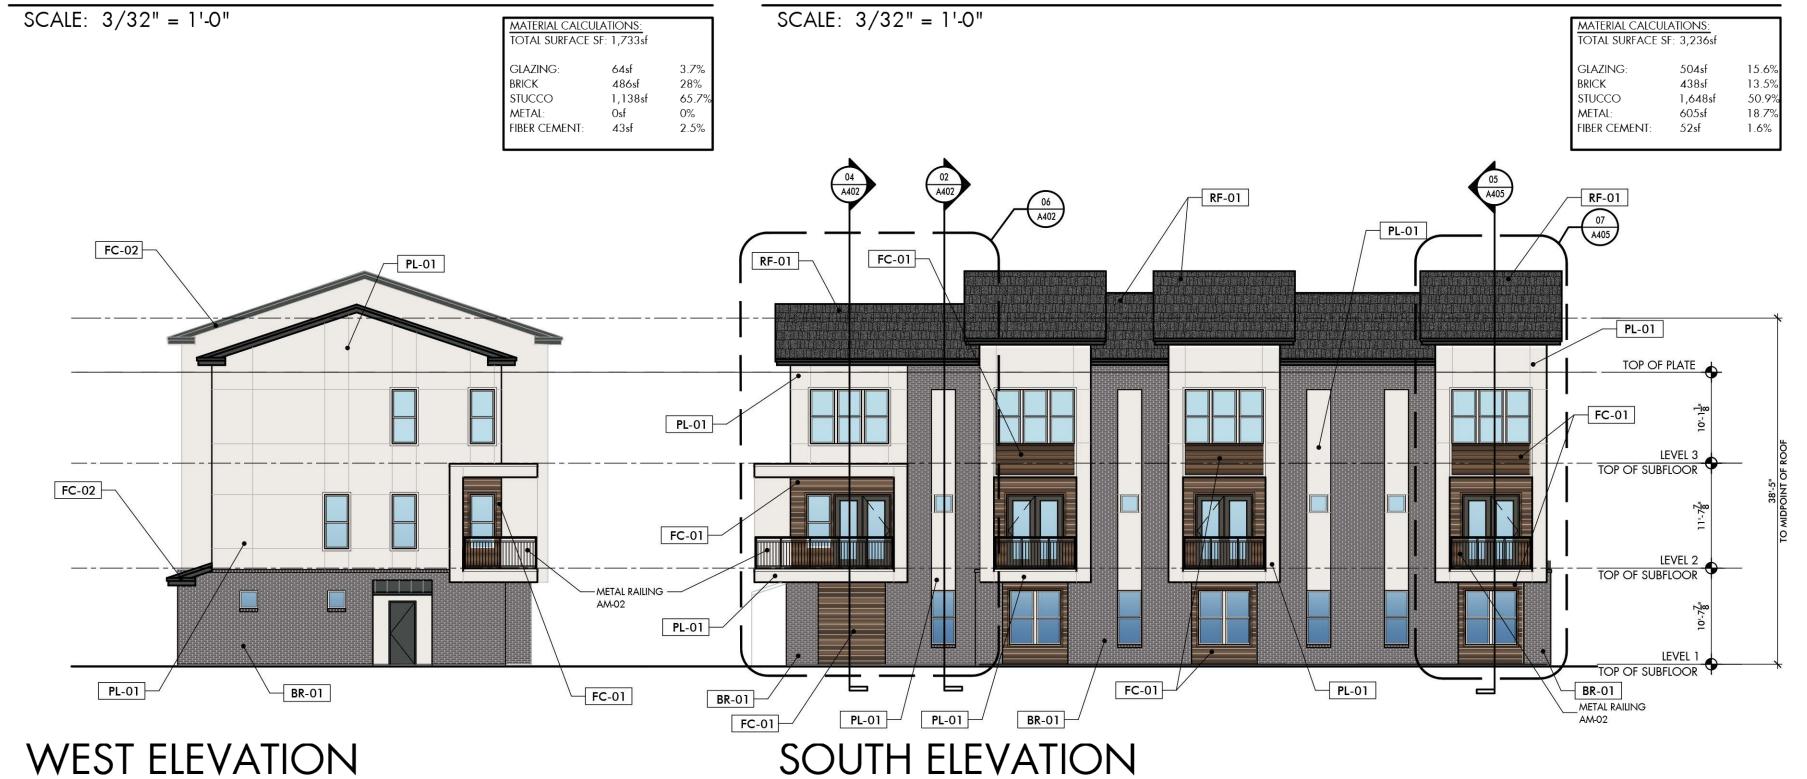

SCALE: 3/32" = 1'-0"

VITRUVIAN TOWNHOMES

Addison, TX

FIBER CEMENT:

MATERIAL CALCULATIONS:

OTAL SURFACE SF: 1,296sf

406sf

733sf

63sf

31.3%

56.6% 0%



ZONING: PD

Addison, TX

Town Project # 1839-Z

VP 217 5.112 acres

Block ____217

MATERIAL CALCULATIONS: TOTAL SURFACE SF: 2,809sf

FIBER CEMENT:

1,213sf

606sf

482sf

Sheet Number: A312

43.2%


21.6% 0% 17.2%


Issue Date: <u>12.03.21</u>

- THIS FACADE PLAN IS FOR CONCEPTUAL PURPOSES ONLY ALL BUILDING PLANS REQUIRE REVIEW AND APPROVAL BY DEVELOPMENT SERVICES


- ALL ROOF MECHANICAL UNITS SHALL BE SCREENED FROM PUBLIC VIEW AS REQUIRED BY THE ZONING ORDINANCE - WHEN PERMITTED, EXPOSED UTILITY BOXES AND CONDUITS SHALL BE PAINTED TO MATCH THE BUILDING - ALL SIGNAGE AREAS AND LOCATIONS ARE SUBJECT TO APPROVAL BY DEVELOPMENT SERVICES


- ROOF ACCESS SHALL BE PROVIDED INTERNALLY, UNLESS OTHERWISE PERMITTED BY THE CHIEF BUILDING OFFICIAL

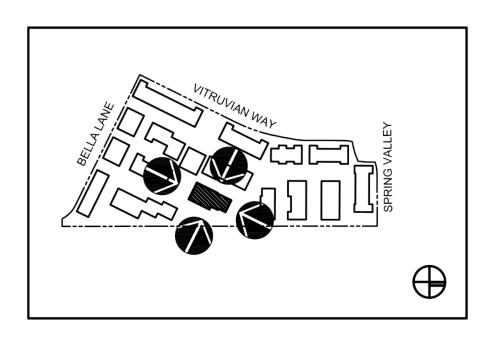

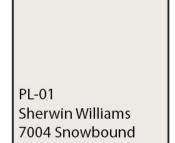



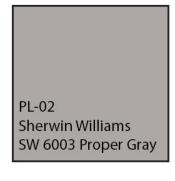


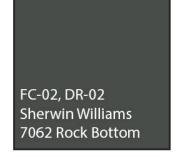







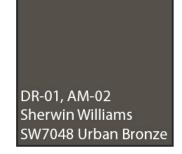









SOUTH ELEVATION

SCALE: 3/32" = 1'-0"

EAST ELEVATION

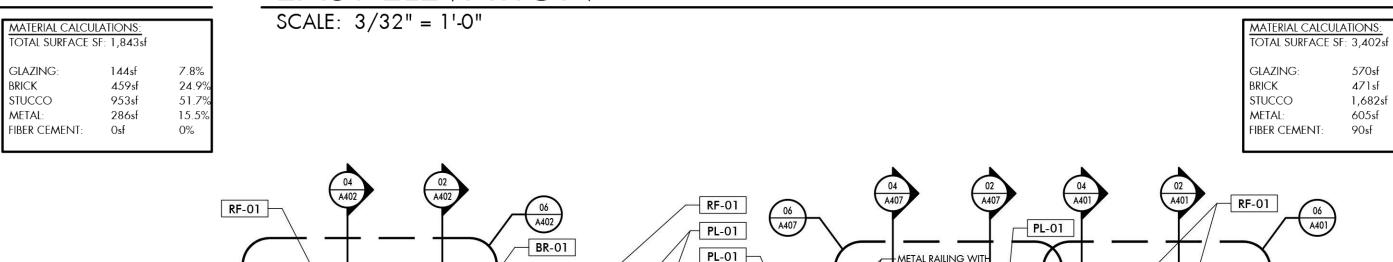

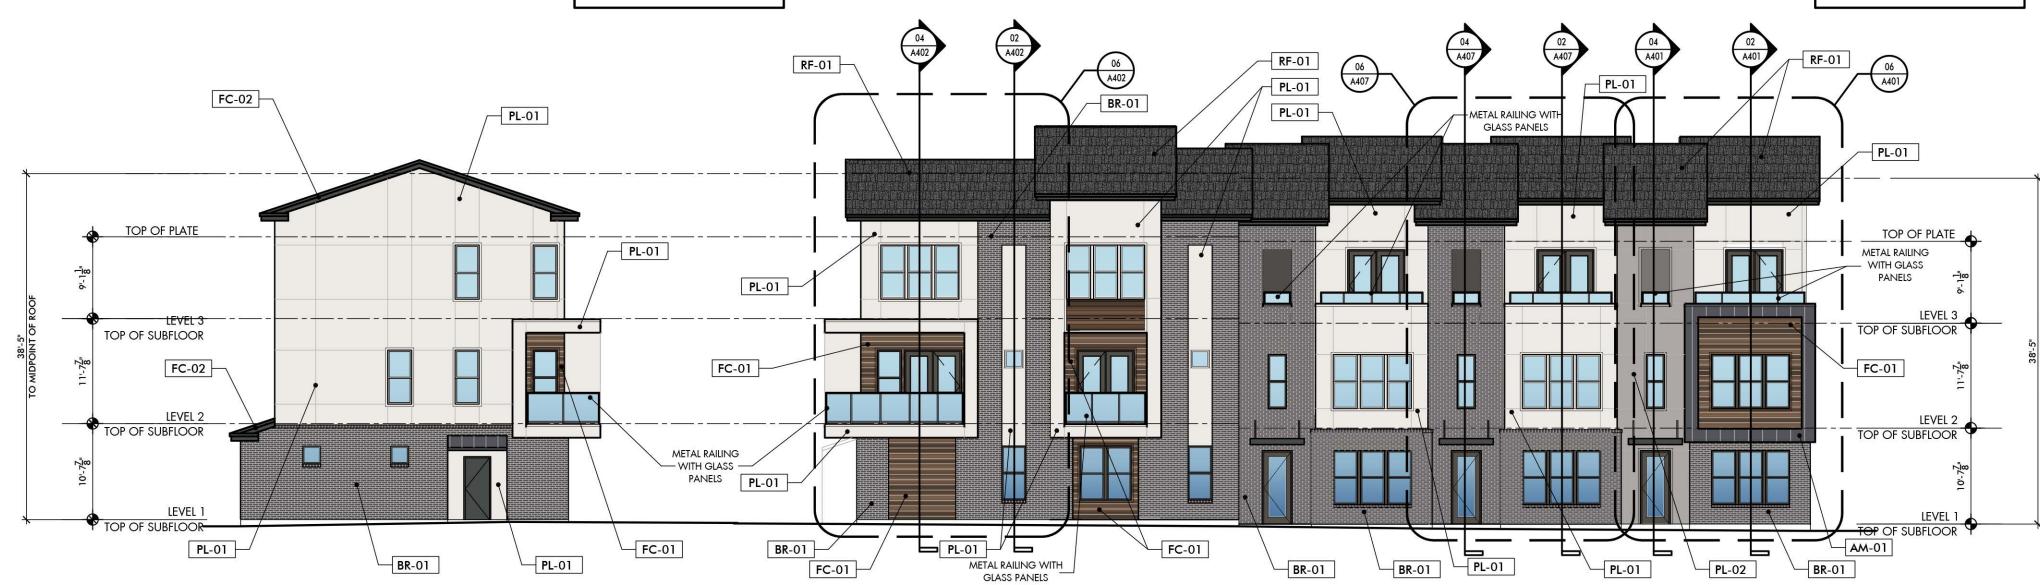

NORTH ELEVATION SCALE: 3/32" = 1'-0"

MATERIAL CALCULATIONS: OTAL SURFACE SF: 1,296sf 406sf 31.3% 733sf 56.69

0%

4.9%

63sf

FIBER CEMENT:

WEST ELEVATION

SCALE: 3/32" = 1'-0"

ZONING: PD	TO
Addison, TX	GL
Town Project # <u>1839-Z</u>	BRI STU
Block217	ME
VP 217 5.112 acres	FIBI

ATERIAL CALCULATIONS: DTAL SURFACE SF: 3,499sf 718sf 1,213sf 1,235sf 87sf UCCO 2.5% IBER CEMENT: 230sf 6.6%

471sf

1,682sf 605sf

13.8%

49.4% 17.8% 2.6%





D A L L A S o A U S T I N 3875 Ponte Ave Suite 410, Addison, TX 75001 1621 E. 6th Street Suite 1151, Austin, TX 78702 214-969-0500 phone o wilderbelshaw.com




UDR Addison, TX 75001 972.774.0552 phone


A313 Sheet Number:

- THIS FACADE PLAN IS FOR CONCEPTUAL PURPOSES ONLY. ALL BUILDING PLANS REQUIRE REVIEW AND APPROVAL BY DEVELOPMENT SERVICES


- ALL ROOF MECHANICAL UNITS SHALL BE SCREENED FROM PUBLIC VIEW AS REQUIRED BY THE ZONING ORDINANCE - WHEN PERMITTED, EXPOSED UTILITY BOXES AND CONDUITS SHALL BE PAINTED TO MATCH THE BUILDING - ALL SIGNAGE AREAS AND LOCATIONS ARE SUBJECT TO APPROVAL BY DEVELOPMENT SERVICES


- ROOF ACCESS SHALL BE PROVIDED INTERNALLY, UNLESS OTHERWISE PERMITTED BY THE CHIEF BUILDING OFFICIAL

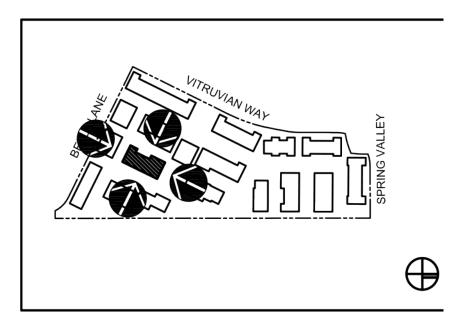

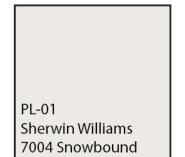



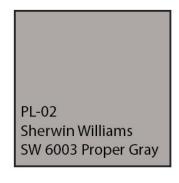

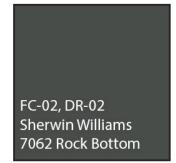
















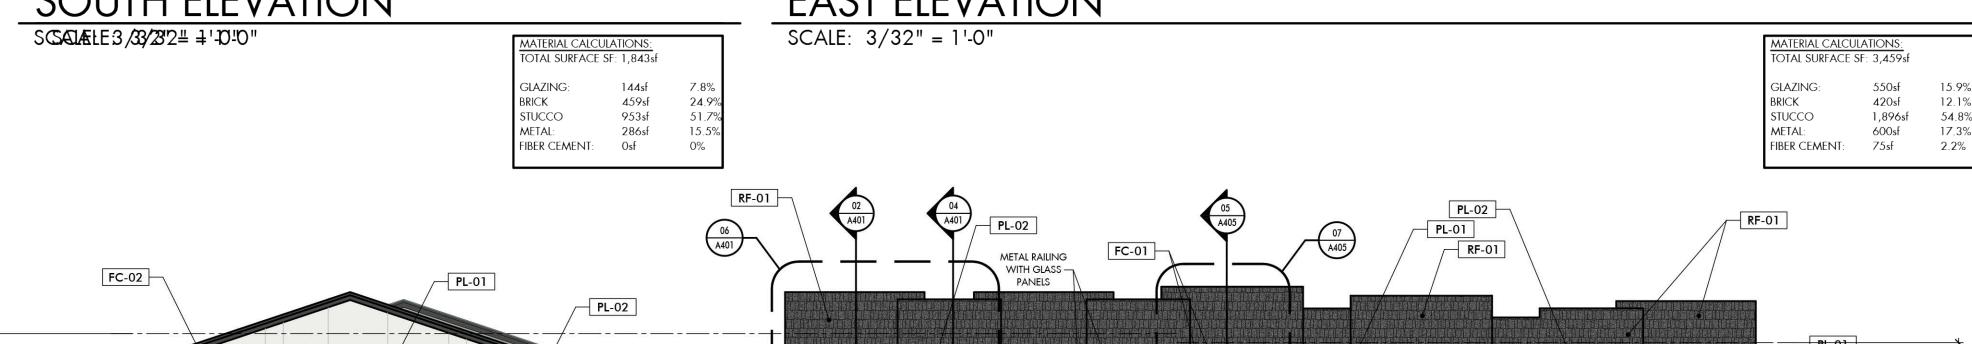



NORTH ELEVATION SCALE: 3/32" = 1'-0"

SCALE: 3/32" = 1'-0"

TOTAL SURFACE S	bf: 1,843sf	
GLAZING:	144sf	7.8
BRICK	459sf	24
STUCCO	953sf	51
METAL:	286sf	15
FIBER CEMENT:	Osf	0%

ZONING: PD Addison, TX Town Project #_ 1839-Z Block ____217_ VP 217 5.112 acres

MATERIAL CALCULATIONS: TOTAL SURFACE SF: 3,542sf 1,050sf 29.6% 33.7% 1,195sf 160sf 4.5% FIBER CEMENT: 390sf

0' 10' 20' **Wilder Belshaw Architects**

> D A L L A S o A U S T I N 3875 Ponte Ave Suite 410, Addison, TX 75001 1621 E. 6th Street Suite 1151, Austin, TX 78702 214-969-0500 phone o wilderbelshaw.com

VITRUVIAN TOWNHOMES Addison, TX



UDR 3875 Ponte Ave, Suite 400 Addison, TX 75001


972.774.0552 phone


A314 Sheet Number:

- THIS FACADE PLAN IS FOR CONCEPTUAL PURPOSES ONLY ALL BUILDING PLANS REQUIRE REVIEW AND APPROVAL BY DEVELOPMENT SERVICES


- ALL ROOF MECHANICAL UNITS SHALL BE SCREENED FROM PUBLIC VIEW AS REQUIRED BY THE ZONING ORDINANCE - WHEN PERMITTED, EXPOSED UTILITY BOXES AND CONDUITS SHALL BE PAINTED TO MATCH THE BUILDING - ALL SIGNAGE AREAS AND LOCATIONS ARE SUBJECT TO APPROVAL BY DEVELOPMENT SERVICES


- ROOF ACCESS SHALL BE PROVIDED INTERNALLY, UNLESS OTHERWISE PERMITTED BY THE CHIEF BUILDING OFFICIAL

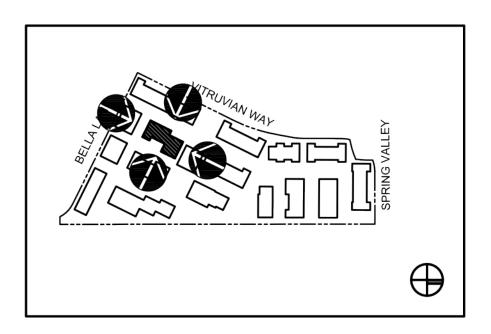

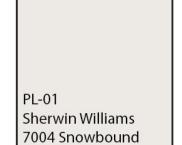



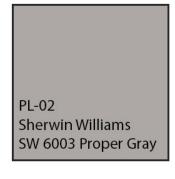


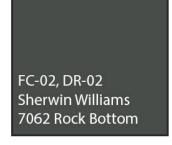







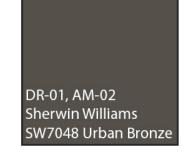








NORTH ELEVATION SCALE: 3/32" = 1'-0"

SCALE: 3/32" = 1'-0"

TOTAL SURFACE SF: 1,843sf 459sf 24.9% 953sf 286sf STUCCO METAL: 15.5% FIBER CEMENT: Osf 0%

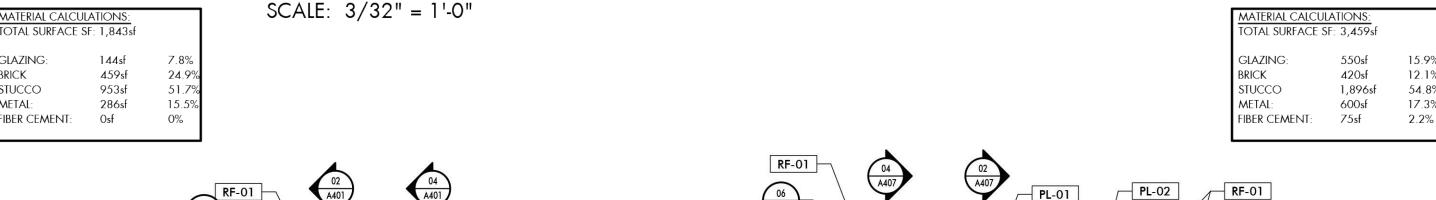



SOUTH ELEVATION SCALE: 3/32" = 1'-0"

MATERIAL CALCULATIONS: OTAL SURFACE SF: 1,843sf 459sf STUCCO METAL: 953sf 286sf FIBER CEMENT: Osf

EAST ELEVATION SCALE: 3/32" = 1'-0"

ZONING: PD Addison, TX Town Project #_ 1839-Z Block ____217 VP 217 5.112 acres

MATERIAL CALCULATIONS: TOTAL SURFACE SF: 3,542sf 1,050sf 1,195sf 160sf 4.5% FIBER CEMENT: 390sf

10' 20'

Wilder Belshaw Architects

D A L L A S o A U S T I N 3875 Ponte Ave Suite 410, Addison, TX 75001 1621 E. 6th Street Suite 1151, Austin, TX 78702 214-969-0500 phone o wilderbelshaw.com

VITRUVIAN TOWNHOMES Addison, TX




UDR 3875 Ponte Ave, Suite 400 Addison, TX 75001 972.774.0552 phone


A315 Sheet Number:


FACADE PLAN NOTES: - THIS FACADE PLAN IS FOR CONCEPTUAL PURPOSES ONLY. ALL BUILDING PLANS REQUIRE REVIEW AND APPROVAL BY DEVELOPMENT SERVICES


- ALL ROOF MECHANICAL UNITS SHALL BE SCREENED FROM PUBLIC VIEW AS REQUIRED BY THE ZONING ORDINANCE - WHEN PERMITTED, EXPOSED UTILITY BOXES AND CONDUITS SHALL BE PAINTED TO MATCH THE BUILDING - ALL SIGNAGE AREAS AND LOCATIONS ARE SUBJECT TO APPROVAL BY DEVELOPMENT SERVICES


- ROOF ACCESS SHALL BE PROVIDED INTERNALLY, UNLESS OTHERWISE PERMITTED BY THE CHIEF BUILDING OFFICIAL

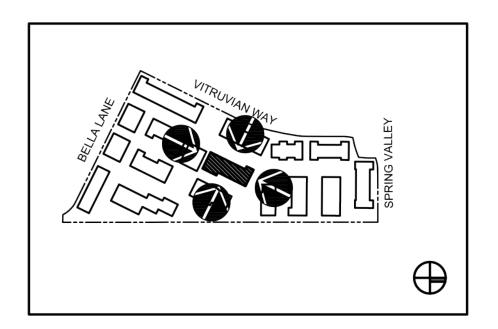

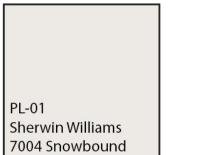

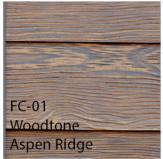

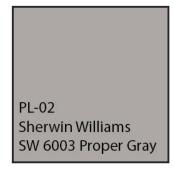


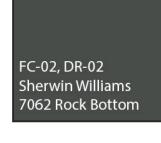







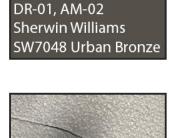





10'



NORTH ELEVATION

SCALE: 3/32" = 1'-0" TOTAL SURFACE SF: 1,843sf

GLAZING: 459sf 953sf 286sf BRICK 24.99 STUCCO 51.79 METAL: 15.59 Osf FIBER CEMENT: 0%

WEST ELEVATION

SCALE: 3/32" = 1'-0" MATERIAL CALCULATIONS: TOTAL SURFACE SF: 4,150sf GLAZING: BRICK STUCCO FIBER CEMENT:



SOUTH ELEVATION SCALE: 3/32" = 1'-0"

MATERIAL CALCULATIONS: TOTAL SURFACE SF: 1,843sf 144sf 459sf 953sf 286sf Osf 24.9% STUCCO METAL: FIBER CEMENT: 51.7% 15.5%

EAST ELEVAITON

SCALE: 3/32" = 1'-0"

ZONING: PD	1
Addison, TX	(
Town Project # <u>1839-Z</u> Block <u>217</u>	;
VP 217 5.112 acres	

MATERIAL CALCULATIONS: TOTAL SURFACE SF: 4,246sf GLAZING: 1,295sf 1,400sf 160sf STUCCO 33% 3.8% 500sf FIBER CEMENT:

504sf

2,300sf 1700sf

75sf

12.1%

55.49

16.9%

1.8%



Wilder Belshaw Architects

D A L L A S o A U S T I N 3875 Ponte Ave Suite 410, Addison, TX 75001 1621 E. 6th Street Suite 1151, Austin, TX 78702 214-969-0500 phone o wilderbelshaw.com



UDR 3875 Ponte Ave, Suite 400 Addison, TX 75001

972.774.0552 phone

A316 Sheet Number:





D A L L A S o A U S T I N 3875 Ponte Ave Suite 410, Addison, TX 75001 1621 E. 6th Street Suite 1151, Austin, TX 78702 214-969-0500 phone o wilderbelshaw.com VITRUVIAN TOWNHOMES

Addison, TX



UDR3875 Ponte Ave, Suite 400
Addison, TX 75001
972.774.0552 phone

Sheet Number:

Issue Date: <u>07.30.21</u>





D A L L A S o A U S T I N 3875 Ponte Ave Suite 410, Addison, TX 75001 1621 E. 6th Street Suite 1151, Austin, TX 78702 214-969-0500 phone o wilderbelshaw.com VITRUVIAN TOWNHOMES

Addison, TX



UDR3875 Ponte Ave, Suite 400
Addison, TX 75001
972.774.0552 phone

Sheet Number: ____





D A L L A S o A U S T I N 3875 Ponte Ave Suite 410, Addison, TX 75001 1621 E. 6th Street Suite 1151, Austin, TX 78702 214-969-0500 phone o wilderbelshaw.com VITRUVIAN TOWNHOMES

Addison, TX



UDR3875 Ponte Ave, Suite 400
Addison, TX 75001
972.774.0552 phone

Sheet Number:





D A L L A S o A U S T I N 3875 Ponte Ave Suite 410, Addison, TX 75001 1621 E. 6th Street Suite 1151, Austin, TX 78702 214-969-0500 phone o wilderbelshaw.com

VITRUVIAN TOWNHOMES Addison, TX



UDR3875 Ponte Ave, Suite 400
Addison, TX 75001
972.774.0552 phone

Sheet Number:





D A L L A S o A U S T I N 3875 Ponte Ave Suite 410, Addison, TX 75001 1621 E. 6th Street Suite 1151, Austin, TX 78702 214-969-0500 phone o wilderbelshaw.com

VITRUVIAN TOWNHOMES Addison, TX



UDR3875 Ponte Ave, Suite 400
Addison, TX 75001
972.774.0552 phone

Sheet Number:





D A L L A S o A U S T I N 3875 Ponte Ave Suite 410, Addison, TX 75001 1621 E. 6th Street Suite 1151, Austin, TX 78702 214-969-0500 phone o wilderbelshaw.com VITRUVIAN TOWNHOMES

Addison, TX



UDR3875 Ponte Ave, Suite 400
Addison, TX 75001
972.774.0552 phone

Sheet Number:

Issue Date: <u>07.30.21</u>





D A L L A S o A U S T I N 3875 Ponte Ave Suite 410, Addison, TX 75001 1621 E. 6th Street Suite 1151, Austin, TX 78702 214-969-0500 phone o wilderbelshaw.com VITRUVIAN TOWNHOMES

Addison, TX



UDR3875 Ponte Ave, Suite 400
Addison, TX 75001
972.774.0552 phone

Sheet Number:

Issue Date: <u>07.30.21</u>





D A L L A S o A U S T I N 3875 Ponte Ave Suite 410, Addison, TX 75001 1621 E. 6th Street Suite 1151, Austin, TX 78702 214-969-0500 phone o wilderbelshaw.com

VITRUVIAN TOWNHOMES Addison, TX



UDR3875 Ponte Ave, Suite 400
Addison, TX 75001
972.774.0552 phone

Sheet Number:





D A L L A S o A U S T I N 3875 Ponte Ave Suite 410, Addison, TX 75001 1621 E. 6th Street Suite 1151, Austin, TX 78702 214-969-0500 phone o wilderbelshaw.com VITRUVIAN TOWNHOMES

Addison, TX



UDR3875 Ponte Ave, Suite 400
Addison, TX 75001
972.774.0552 phone

Sheet Number:

ieei i tuilibei.





D A L L A S o A U S T I N 3875 Ponte Ave Suite 410, Addison, TX 75001 1621 E. 6th Street Suite 1151, Austin, TX 78702 214-969-0500 phone o wilderbelshaw.com VITRUVIAN TOWNHOMES

Addison, TX



UDR3875 Ponte Ave, Suite 400
Addison, TX 75001
972.774.0552 phone

Sheet Number:

Issue Date: <u>07.30.21</u>