

#### PLANNING AND ZONING COMMISSION AGENDA

Planning and Zoning Commission Public Hearing Thursday, OCTOBER 20, 2020 6:00 p.m.

# Addison Town Hall 5300 Belt Line Road, Addison, Texas

Notice is hereby given that the Addison Planning and Zoning Commission, using electronic medium, will conduct its meeting on Tuesday, October 20, 2020. No meeting will be conducted at Town Hall. A temporary suspension of the Open Meetings Act to allow telephone or videoconference public meetings has been granted by Governor Greg Abbott. These actions are being taken to mitigate the spread of COVID-19 by avoiding meetings that bring people into a group setting and in accordance with Section 418.016 of the Texas Government Code. Telephonic or videoconferencing capabilities will be utilized to allow individuals to address the Commission. Email comments may also be submitted to <a href="wkerr@addisontx.gov">wkerr@addisontx.gov</a> by 3:00 pm the day of the meeting. Members of the public are entitled to participate remotely via Toll-Free Dial-in Number: 877.853.5247; <a href="Meeting ID: 409.327.0683#">Meeting ID: 409.327.0683#</a>, <a href="Participant ID: #">Participant ID: #</a>. For more detailed instructions on how to participate in this meeting visit our Agenda Page. The meeting will be live streamed on Addison's website at <a href="www.addisontexas.net">www.addisontexas.net</a>.

#### Call Meeting to Order & Recite the Pledge of Allegiance

- 1. Discuss and take action regarding approval of the minutes of the September 15, 2020 Planning and Zoning Commission meeting.
- 2. Case 1809-Z/Baumann Building. Discussion, and take action on a recommendation regarding an ordinance changing the zoning on a .57-acre property located at 4901 Arapaho Road, which property is currently zoned PD, Planned Development, through Ordinance O04-048, by approving a new PD district, to allow a 5-story mixed use building.

3. **PUBLIC HEARING** Case 1818-Z/3820 Belt Line Road. Public hearing, discussion, and take action on a recommendation regarding an ordinance changing the zoning on property located at 3820 Belt Line Road, from PD, Planned Development, to a new PD district to allow a two-story retail and office building.

#### Adjourn Meeting

NOTE: The Planning & Zoning Commission reserves the right to meet in Executive Session closed to the public at any time in the course of this meeting to discuss matters listed on the agenda, as authorized by the Texas Open Meetings Act, Texas Government Code, Chapter 551, including §551.071 (private consultation with the attorney for the City); §551.072 (purchase, exchange, lease or value of real property); §551.074 (personnel or to hear complaints against personnel); §551.076 (deployment, or specific occasions for implementation of security personnel or devices); and §551.087 (economic development negotiations). Any decision held on such matters will be taken or conducted in Open Session following the conclusion of the Executive Session.

Posted:		
	Irma G. Parker, City Secretary	

DATE: Thursday, October 15, 2020

TIME: 2:00 pm

THE TOWN OF ADDISON IS ACCESSIBLE TO PERSONS WITH DISABILITIES. PLEASE CALL (972) 450-7090 AT LEAST 48 HOURS IN ADVANCE IF YOU NEED ASSISTANCE.

#### **Planning & Zoning Commission**

**Meeting Date:** 10/20/2020

#### **Agenda Caption:**

Discuss and take action regarding approval of the minutes of the September 15, 2020 Planning and Zoning Commission meeting.

#### **Attachments**

09-15-20 Minutes

# DRAFT

# OFFICIAL ACTIONS OF THE ADDISON PLANNING AND ZONING COMMISSION

September 15, 2020 6:00 P.M. - Council Chambers Addison Town Hall, 5300 Belt Line Road

Present: Chair Kathryn Wheeler; Vice Chair Eileen Resnik; Commissioner Robert Catalani;

Commissioner Nancy Craig; Commissioner Chris DeFrancisco; Commissioner John

Meleky; Commissioner Tom Souers

#### Pledge of Allegiance

1. Discuss and take action regarding approval of the minutes of the August 18, 2020 Planning and Zoning Commission meeting.

Moved by Commissioner John Meleky, Seconded by Vice Chair Eileen Resnik

AYE: Chair Kathryn Wheeler, Vice Chair Eileen Resnik, Commissioner Robert Catalani, Commissioner Nancy Craig, Commissioner Chris DeFrancisco, Commissioner John Meleky, Commissioner Tom Souers

Passed

 Case 1809-Z/Baumann Building. Discussion, and take action on a recommendation regarding an ordinance changing the zoning on a .57-acre property located at 4901 Arapaho Road, which property is currently zoned PD, Planned Development, through Ordinance O04-048, by approving a new PD district, to allow a 5-story mixed use building.

Commissioner Souers inquired about the applicant wanting an answer on the issue on the night of the Planning and Zoning Commission meeting. Charles Goff responded that he did not have the opportunity to speak with the applicant about the timeline for the project after the call with the FAA and TXDOT the day prior.

Commissioner Resnik inquired as to who was the ultimate decision maker on the project as there is a concern that the proposed development would cause the FAA to revoke future funding from the Addison Airport. Charles Goff responded that the FAA would be the ultimate decision maker as to whether the town would be in violation of FAA grant assurances if a residential use is allowed within the airport noise contours.

Commissioner DeFrancisco requested that, if the issue were further tabled, that Charles Goff communicate with the applicant that the proposed plans must be complete and that such plans must meet requirements laid out by the Master Transportation Plan. Charles Goff responded that the Addison Development Services Department would use the following month to communicate with the applicant and the applicant's architectural team to ensure that the plans come as close as possible to compliance with the Master Transportation Plan.

The applicant, Bob Baumann, and the applicant's representative, Dan Anderson, answered questions from the council. They also stated that other developments that include residential use in the DFW metroplex have been completed within the same noise contour of an airport but conceded to wait for a response from the FAA as to whether the building would violate the grant assurances. Mr. Anderson also requested that the commission approve the plans subject to the approval of the FAA. Chair Wheeler asked Charles Goff for a staff recommendation on approving the plans subject to the approval of the FAA. Charles Goff responded that there were still issues with the submitted plans and that it would not be recommended for the commission to move forward with the approval process. The commission agreed that the plans should not be approved as shown.

The commission discussed tabling the item for another month to allow the FAA to respond and give a definite answer on grant assurances to the the Addison Airport, as well as allowing the applicant to present completed plans to staff.

Motion: Table the request until October 20, 2020 P&Z Commission hearing in order to allow the FAA time address the funding issues and allow the applicant to submit completed plans.

Moved by Commissioner John Meleky, Seconded by Commissioner Tom Souers

AYE: Chair Kathryn Wheeler, Vice Chair Eileen Resnik, Commissioner Robert Catalani, Commissioner Nancy Craig, Commissioner Chris DeFrancisco, Commissioner John Meleky, Commissioner Tom Souers

Passed

3. **PUBLIC HEARING** Case 1816-Z/Addison Senior Living. Public hearing, discussion, and take action on a recommendation regarding an ordinance changing the zoning on a 11.607-acre property located at the southwest corner of Dallas Parkway and Excel Parkway, from PD, Planned Development, to a new PD district in order to allow a senior living development and future office development.

#### Discussion:

Charles Goff, Director of Development Services, presented the Staff Report.

Commissioner Souers inquired as to how the Town would ensure that the fee in leu of an open space dedication would be used to purchase more park space throughout Addison. Charles Goff responded that the town has options as to how to dedicate the funds to park space and that this whichever option is used will be decided by City Council. Charles Goff also stated that the Town would use the Parks and Open Space Master Plan to guide the decision in purchasing new park space.

Commissioners Souers and Resnik requested more information on the green space that the applicant would be providing on the property and if it would be sufficient enough to not require a dedication of open space. Charles Goff responded that the applicant would be providing multiple different amenity spaces and private green space to their tenants, which will similar to green space provided by other multifamily developments of similar size. This amenity space includes a courtyard, an amenity space on top of the parking garage, and private landscaping throughout the development. Additionally Charles Goff stated that the applicant would be improving the surrounding streetscape to comply with the Master Transportation Plan, in turn widening the sidewalks and providing walking paths throughout the site.

Commissioner Resnik inquired as to how the Addison Senior Living would expand from 217 units to 248 units. Charles Goff responded that the developers have the opportunity to expand the portion of the building at the northeast corner of Addison Road and Excel Parkway to accommodate more units.

Commissioner DeFrancisco inquired as to whether or not the 0.48 acre

open space requirement would fit on the development rather than using a fee in leu of dedication. Charles Goff responded that it the required dedication space would fit at the corner of the development's proposed urban pedestrian commercial collector street and Dallas Parkway. By consulting the Parks and Open Space Master Plan, Staff found that larger park space in other area of Addison would be preferable to open space in this location.

Commissioner DeFrancisco also inquired if the required 6-story office building on the lower portion of the property was the highest and best land use for the site. Charles Goff responded that the site has been difficult to market to office developers as there is a lack of access to the Tollway from this site. Additionally, a 6-story building allows developers to keep construction costs low, in turn keeping rental rates on par with the other office buildings in the area. Due to this, Staff believes that the office building requirements creates the best use for the remainder of the site.

The applicants, Gordon Gilmore, Peter Phillips, and Joe Seitzer, answered questions from the commission regarding the green space and amenity space that the development would provide to tenants. Chair Wheeler also inquired about the senior living rental rates. Peter Phillips responded that the rates will be comparable or slightly below the competitors in the metro area. Peter Phillips also went on to describe the other properties that the applicants completed and how Addison Senior Living will compare to their existing senior living facilities.

The commission requested a timeline for development of the project. The applicants proposed a 9 month design process followed by a 22 month development process, for a total project timeline of roughly 3 years.

Chair Kathryn Wheeler opened the meeting as a public hearing.

Public Hearing: There were no speakers on this item.

Chair Kathryn Wheeler closed the public hearing.

Motion: Recommend approval of the request without conditions.

Moved by Commissioner Chris DeFrancisco, Seconded by Commissioner Tom Souers

AYE: Chair Kathryn Wheeler, Vice Chair Eileen Resnik, Commissioner Robert Catalani, Commissioner Nancy Craig, Commissioner Chris DeFrancisco, Commissioner John Meleky, Commissioner Tom Souers

#### Passed

NOTE: The Planning & Zoning Commission reserves the right to meet in Executive Session closed to the public at any time in the course of this meeting to discuss matters listed on the agenda, as authorized by the Texas Open Meetings Act, Texas Government Code, Chapter 551, including §551.071 (private consultation with the attorney for the City). Any decision held on such matters will be taken or conducted in Open Session following the conclusion of the Executive Session.

#### **Adjourn Meeting**

There being no further business before the Commission, the meeting was adjourned.

#### **Planning & Zoning Commission**

**Meeting Date:** 10/20/2020

#### **Agenda Caption:**

Case 1809-Z/Baumann Building. Discussion, and take action on a recommendation regarding an ordinance changing the zoning on a .57-acre property located at 4901 Arapaho Road, which property is currently zoned PD, Planned Development, through Ordinance O04-048, by approving a new PD district, to allow a 5-story mixed use building.


#### **Attachments**

1809-Z P&Z Packet 1809-Z Plans

# 1809-Z

**PUBLIC HEARING** Case 1809-Z/Baumann Building. Public hearing, discussion, and take action on a recommendation regarding an ordinance changing the zoning on a .57-acre property located at 4901 Arapaho Road, which property is currently zoned PD, Planned Development, through Ordinance O04-048, by approving a new PD district.

#### **LOCATION MAP**

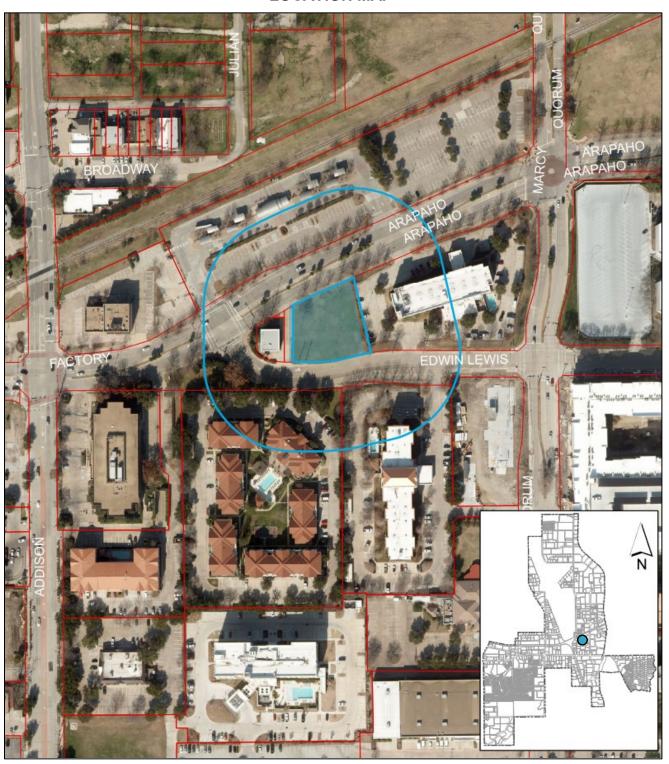



October 20, 2020

Case 1809-Z/Baumann Building

#### STAFF REPORT

RE:

LOCATION: 4901 Arapaho Road **REQUEST:** Approval of an ordinance changing the zoning from Planned Development (PD) district, through Ordinance O04-04, to a new PD district to allow development of a five-41,388 square-foot multitenant commercial building with one residential unit on the top floor. APPLICANT: Daniel Anderson. Trium Development Partners, LLC

#### DISCUSSION:

<u>Background</u>: This .57-acre vacant lot is zoned PD, Planned Development, through Ordinance O04-048. It was initially shown as a vacant lot on the approved site plan for what is currently the Raddison Hotel and was subsequently included as a parking lot expansion for the hotel through Special Use Permit Ordinance O07-029 in 2007. The parking lot expansion never came to fruition and the lot has remained vacant.

The new property owner, Bob Baumann, is proposing to develop a five-story commercial building containing Edward Baumann Clothiers on one floor, a luxury mattress showroom on another, and potential office space on one floor, with his residence on the top floor. Such action requires the property to be rezoned.

In other development projects in this area, including AMLI and Western International, Town staff has worked to extend the Addison Circle district standards south. Accordingly, Staff encouraged the applicant to follow the Urban Center (UC) zoning district standards. The applicant is requesting that the property be rezoned to a Planned Development (PD) based on the UC standards while allowing for certain alternative development standards.

<u>Proposed Plan</u>: The applicant is proposing to construct a five-story, 41,388 square foot building with ground floor parking garage, three floors of commercial uses, and one residential unit on the top floor. The commercial component of the building is proposed to be used as office, showroom, and retail space.



<u>Use</u>: The Urban Center district allows each of the proposed uses in this building. Section 2 E 4. *Airport noise restrictions*, however, states that no residential uses are permitted within the 65 decibel noise level contours of Addison Airport. The 65 decibel noise level contour is shown in the blue area on the chart below, with the subject property outlined in red.



Given the proximity of this property to the airport, the property falls entirely within the 65 decibel noise level contour. This standard comes from an FAA requirement that the Town is obligated to abide by. Therefore, residential uses should not be allowed. **The applicant is requesting that the residential unit be allowed despite the requirement.** 

<u>Building Height</u>: Urban Center standards state that all buildings must be at least 40 feet in height. The proposed building is 78 feet tall.

<u>Building Setback</u>: The Urban Center standards typically require that buildings be set back 10 feet from the edge of the sidewalk, which in Addison Circle is the property line. The plans show the setback would meet this 10-foot requirement along Arapaho Road and Edwin Lewis Drive.

<u>Building Elevations</u>: Urban Center standards require building facades to be a minimum of 90% brick or stone, however, provided the recent passing of House Bill 2439, Staff is unable to enforce the exterior materials requirement at this time. The plans show the south and east elevations at approximately 75% brick and cast stone, and north and west elevations at approximately 50% brick and cast stone, with the rest of the façade being constructed of painted metal, EIFs, exposed concrete, and ACM panel.

<u>Parking</u>: There are several issues regarding the calculation of parking on the property. First, the Town's zoning code requires that parking for buildings of less than 50,000 square feet be calculated based on gross square footage, not the useable square footage of the building. Second, typically clothing stores would be required to park at a retail ratio of 1 parking space per 250 square feet. However, given that the Edward Baumann Clothiers business model is by

appointment only, Staff believes that it is reasonable to park this use as office instead of retail. Urban Center standards require that one parking space be provided per 300 square feet of office use. The applicant would like the clothing store to be considered a showroom which would be required to provide one parking space per 1,000 square feet of warehouse/showroom. Urban Center standards require one parking space per bedroom for residential uses with a maximum of two spaces per dwelling unit.

Based on the Town's typical calculation of parking requirements, with the allowance that the clothing store being parked at an office ratio, the parking requirements would be as follows:

20,232 sq ft Office	68 parking spaces
10,116 sq ft Showroom	11 parking spaces
1 Dwelling Unit	2 parking spaces
Total	81 parking spaces

If the parking requirements were calculated based on the applicant's request to only count useable square footage and to use the showroom ratio for the clothing store, the parking requirements would be as follows:

8,854 sq ft Office	30 parking spaces
17,708 sq ft Showroom	18 parking spaces
1 Dwelling Unit	2 parking spaces
Total	50 parking spaces

The proposed plan only provides a total of 46 onsite parking spaces. This is 35 spaces short of the Town's typical requirements, and even 4 spaces short of the applicant's proposed calculation method. The applicant's request for only counting usable square footage excludes the balconies on each floor. If the balconies are counted as usable square footage the development would require 53 parking spaces and the plan would be 7 spaces short of meeting requirements. The applicant is requesting that the parking requirements be calculated based only on useable square footage of the building, that the clothing store be parked at a showroom ratio, and that the property be given relief on the additional 4 parking space based on the property being located near the future DART rail station.

<u>Open Space</u>: Staff and the applicant are proposing no open space dedication for this project. The Urban Center zoning standards require that open space be provided at a certain acreage per resident. The ratio would result in a tiny dedication, and there is currently a surplus of Open Space provided in Addison Circle. The proposed residential unit would use a small portion of this surplus, leaving a remaining surplus of just over 7 acres. See calculation on the following page:

Addison Circle Open Space Required (Existing): 7.518 acres
Additional Open Space Required for One Unit: 0.003 acres



Total Open Space Required with Townhomes: 7.521 acres
Addison Circle Open Space Provided: 14.74 acres
Surplus Open Space Remaining in Addison Circle: 7.219 acres

<u>Streetscapes</u>: The Master Transportation Plan provides streetscape standards for various street types. Arapaho Road is defined as a Minor Arterial. The existing sidewalk along Arapaho Road has already been constructed with a specific look that runs the length of the corridor and no changes are being proposed or required by Staff.

The Master Transportation Plan defines Edwin Lewis Drive as a Commercial Collector street and provides three options for such streets to be applied based on the context of the surrounding development. Given the desire to integrate future development in this area with the existing character of Addison Circle, the Urban Pedestrian standard is most appropriate for this property. As shown in the image below, this would require an 8 foot on-street parallel parking area, a 6 foot parkway buffer with street trees, and an 8 foot sidewalk.

# 8' 6' 8' 11' Sidewalk Parkway Parallel Buffer Parking

#### URBAN PEDESTRIAN

This is the standard that was applied to both AMLI and Western International. The applicant's plans for the redevelopment of the streetscape along Edwin Lewis Drive meet the urban pedestrian standards laid out in the Master Transportation Plan.

<u>Landscaping</u>: The landscape plans have been reviewed by the Parks Department to ensure compliance with the Town's Landscape Ordinance. The plans show that the applicant is proposing to comply with the landscape requirements as provided by the Urban Center district and the Town's Landscape Regulations.

RECOMMENDATION: DENIAL



Staff believes that while the proposed commercial building fits in generally with intent to extend the Addison Circle district as well as the future transit oriented development, there are important concerns with the proposal that are the basis for Staff's recommendation on this request.

First, the proposal does not comply with parking requirements. As mentioned previously, Staff is willing to make reasonable interpretations of the uses proposed for the building, however there is no factual basis for the interpretations requested by the applicant and would result in the inconsistent application of the Town's parking requirements. Furthermore, even with the applicant's suggested calculation methodology, the property still falls 4 spaces short. While Staff does believe that consideration could be given to relaxing parking requirements adjacent to transit, a 10% reduction would be a reasonable accommodation.

Furthermore, while Staff hopes that the proposed users of the building are successful and in place for a long time, the building will be around longer. It is not in the Town's best interest to deviate from typical standards to allow the construction of what is effectively an office/retail building, while restricting all future uses to only warehouses and showrooms due to parking limitations.

Second, Addison Airport is an important part of Addison. The Town has committed to the FAA that the Town will abide by FAA requirements when making local land-use decisions. While it is true that the applicant is relocating their business and residence from a location that is also within the noise contours, that property was zoned and developed prior to the prohibition on residential uses within the noise contours of Addison Airport. Future land use decisions should consider the FAA's current requirements.

While the applicant has revised plans to comply with the Urban Pedestrian streetscape standards laid out in the Master Transportation Plan, the parking requirements and the uses proposed in the development are inconsistent with Town goals and standards. Therefore, Staff recommends denial.









# BAUMANN BUILDING

ZONING RESPONSE - 10/09/2020

	Zoning Sh	eet List					
Sheet Number							
General							
G001	Zoning Index and Cover Sheet	12/13/19	Comments 6	10/09/20			
G101	Conceptual Site Plan	12/13/19	Comments 5	09/24/20			
G102	Site Plan	03/30/20	Comments 6	10/09/20			
G110	Facade Plans	12/13/19	Comments 4	08/12/20			
G111	Facade Plans	12/13/19	Comments 6	10/09/20			
G121	Ground Floor	12/13/19	Comments 6	10/09/20			
G122	Floor 2	12/13/19	Comments 6	10/09/20			
G123	Floors 3-4	03/04/20	Comments 6	10/09/20			
G125	Floor 5	12/13/19	Comments 6	10/09/20			

Sheet Number	Sheet Name	Sheet Issue Date	Current Revision Description	Current Revision Date
Civil				
C1.1	Drainage Plan	12/13/19	Comments 6	10/09/20
C1.2	Site Utility Plan	12/13/19	Comments 6	10/09/20
Existing				
12	Existing Drainage Area Map	12/1983		
Landscape				
L1.01	Tree Preservation plan	01/24/20	Comments 6	10/09/20
L2.01	Landscape plan	01/24/20	Comments 6	10/09/20
L2.02	Landscape Specifications and Details	01/24/20	Comments 6	10/09/20
L3.01	Irrigation Plan	01/24/20	Comments 6	10/09/20
L3.02	Irrigation Specifications and Details	01/24/20	Comments 6	10/09/20

Zoning Sheet List

# PROJECT DESCRIPTION

50,240 GROSS SQUARE FOOT, 5-STORY FULLY SPRINKLERED GARAGE, OFFICE AND SHOWROOM BUILDING. 41,388 SF EXCLUDING GARAGE. REFER TO SITE PLAN FOR ZONING INFORMATION.

# APPLICABLE CODES

- 2012 INTERNATIONAL BUILDING CODE
- 2012 NTERNATIONAL ENERGY CONSERVATION CODE 2012 MECHANICAL CODE
- 2012 PLUMBING CODE
- 2012 INTERNATIONAL PROERTY MAINTENANCE CODE 2016 NATIONAL ELECTRICAL CODE

CITY OF ADDISON, TEXAS LOCAL AMENDMENTS

2012 TEXAS ACCESIBILITY STANDARDS


Owner:

JR Baumann Holdings LLC
4801 Arapaho Road
Suite 100
Addison, Texas 75001

Architect/Applicant:
Greenlight Studio LLC
100 N. Cottonwood Drive
Suite 104
Richardson, Texas 75080
v: 214.810.4535
Civil Engineer:
Pacheco Koch
7557 Rambler Road
Suite 1400
Dallas, Texas 75231
v: 972.235.3031

07/06/2020 PROJECT NO:

Zoning Index and Cover Sheet

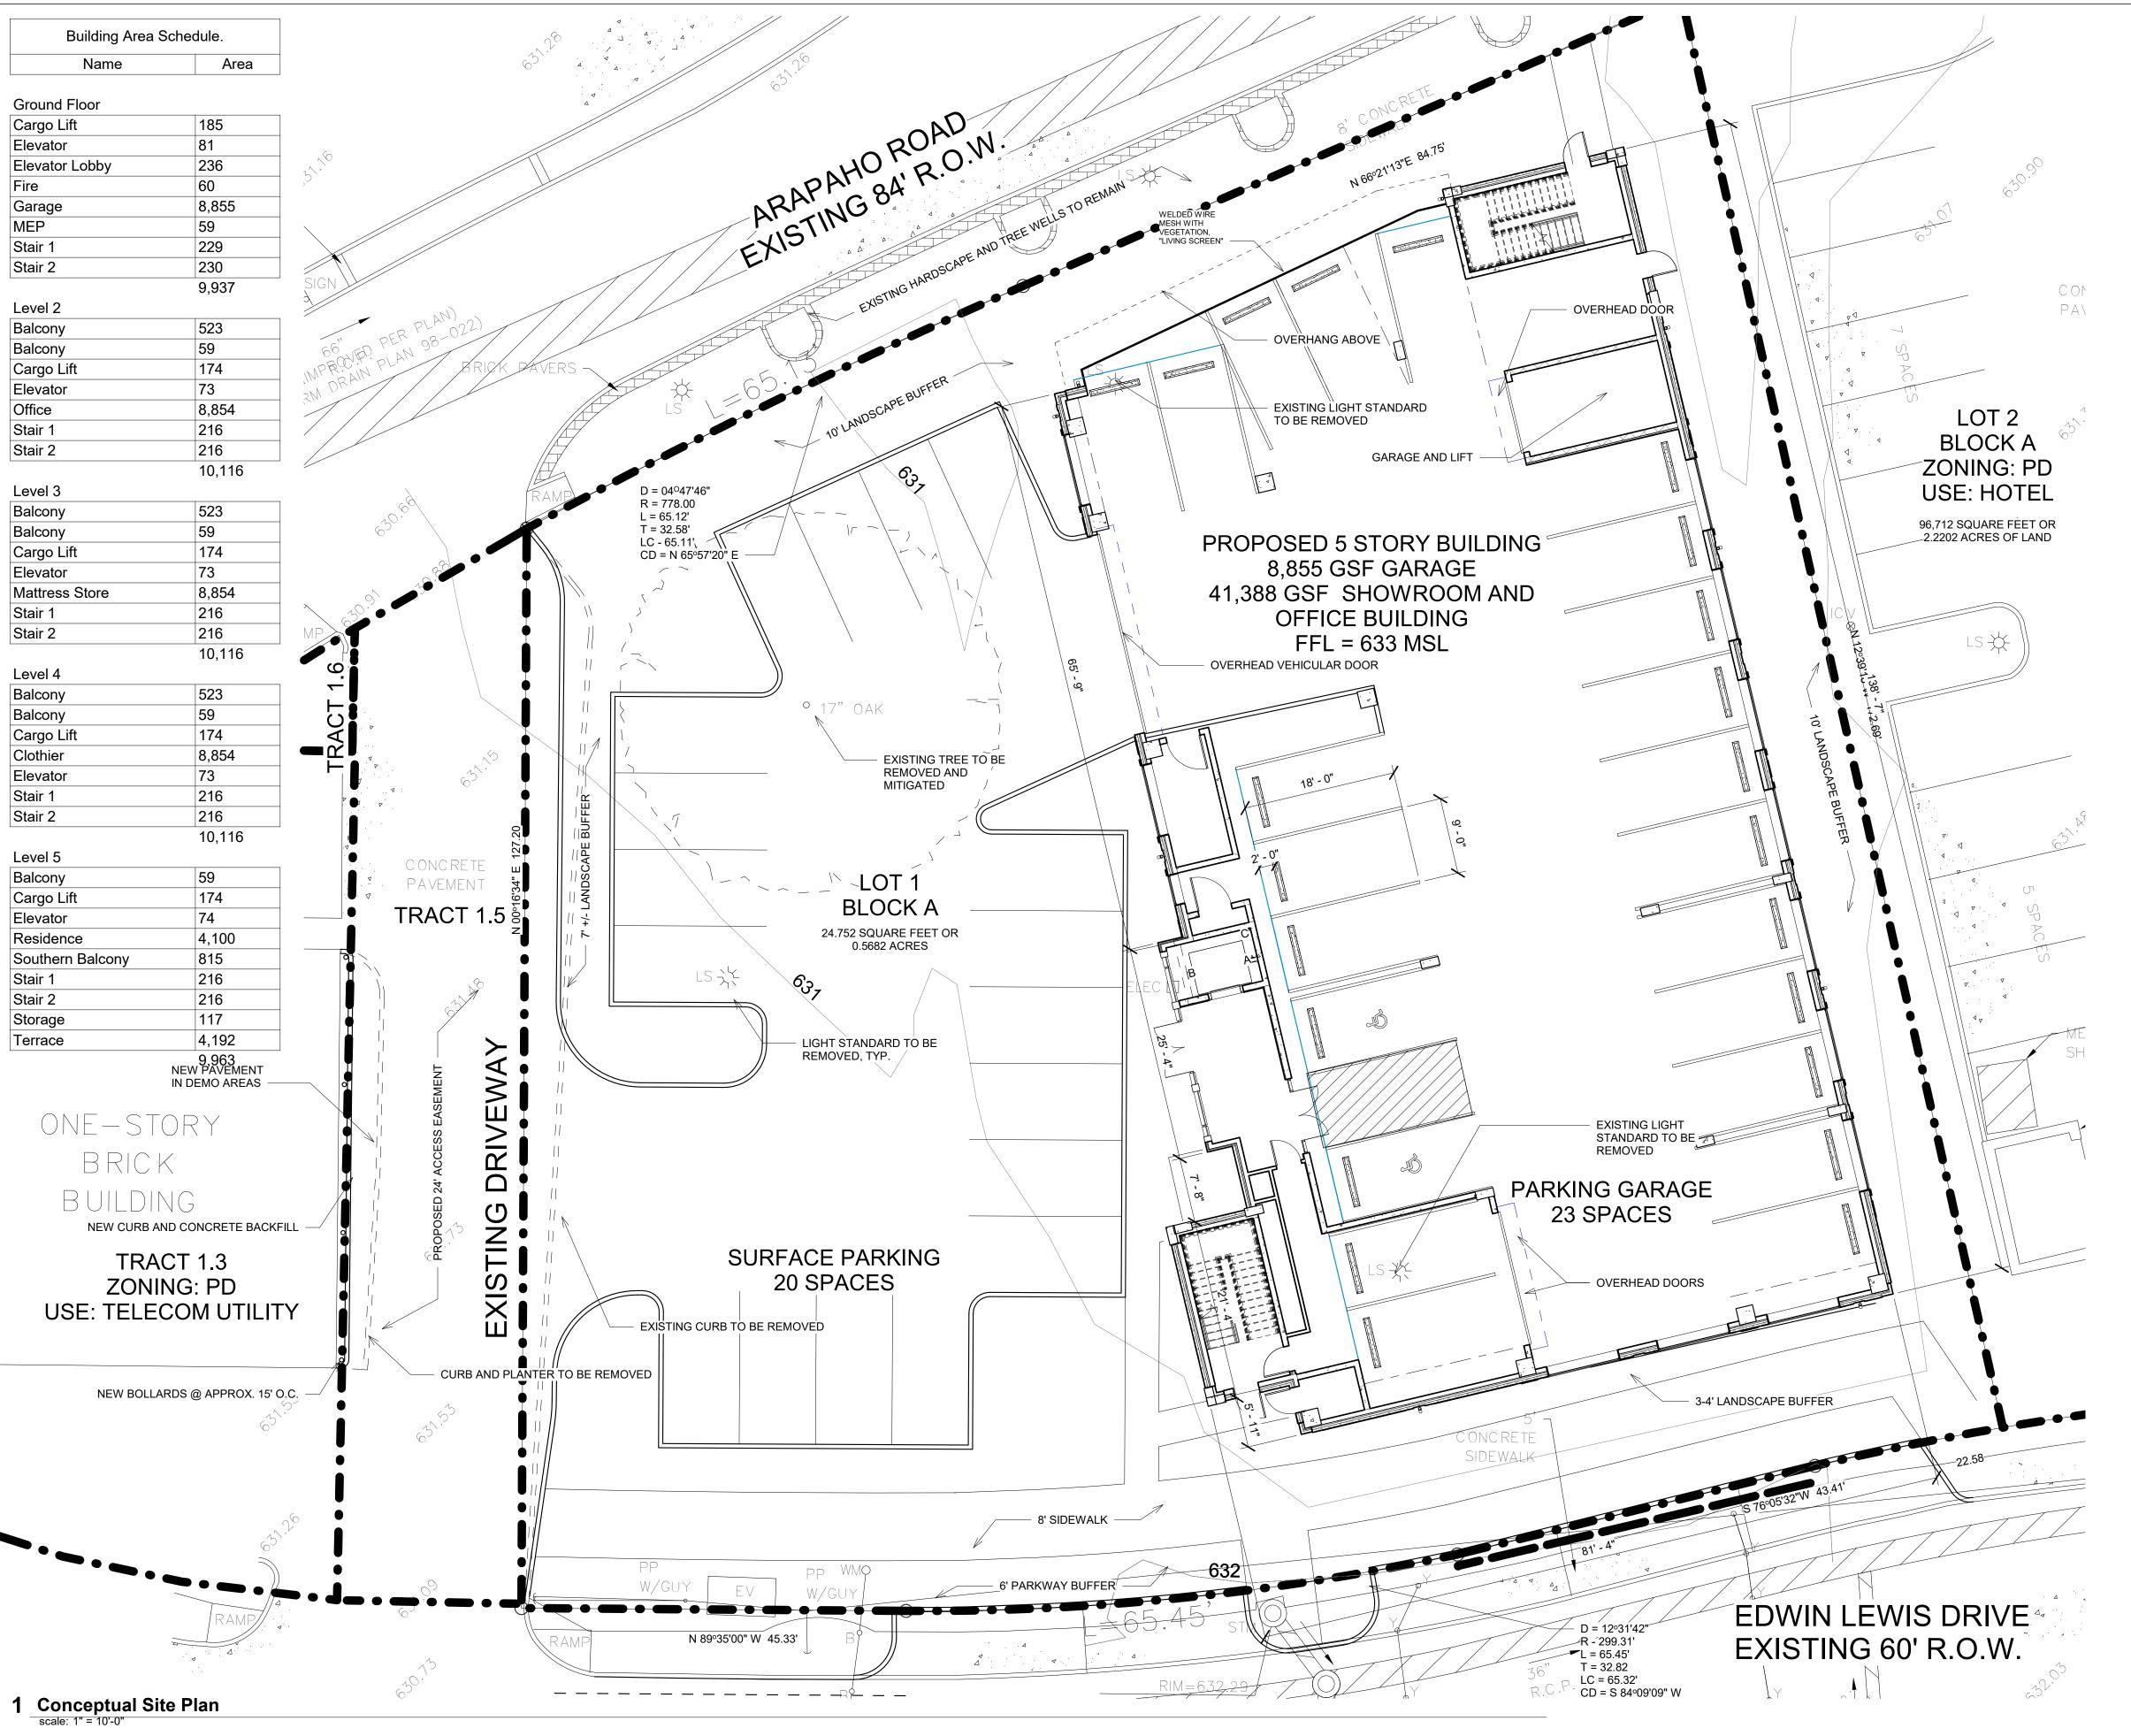

# SITE DATA SUMMARY TABLE

LOT 1 BLOCK A WINGATE INN OF ADDISON ADDITION

PLANNED DEVELOPMENT EXISTING ZONING: PROPOSED ZONING: PLANNED DEVELOPMENT PROPOSED USE: OFFICE SHOWROOM LOT SIZE: 24,752 SF/ .57 ACRES

41,388 GSF BUILDING **BUILDING AREA:** 8,855 SF GARAGE BUILDING HEIGHT: 78 FEET (TO MECH SCREENING)/5 STORIES

PARKING DATA SPACES REQUIRED

LOT COVERAGE:

OFFICE SPACE (1:300 SF): 8,854 SF 30 SPACES WAREHOUSE SHOWROOM SPACE (1:1000 SF):17,708 SF 18 SPACES RESIDENCE: 2 SPACES 10% TOD CREDIT -4 SPACES PARKING REQUIRED: **44 SPACES** 

GARAGE PARKING: 23 SPACES SURFACE PARKING: 19 SPACES STREET PARKING: 5 SPACES TOTAL PARKING PROVIDED: **46 SPACES** 

**FULL OFFICE SCENARIO** 

\*SECOND FLOOR CONVERTED TO PARKING FOR AN ADDITIONAL 23 SPACES, TOTALING 70 SPACES. FLOORS 3-5: 17,708 SF FLOOR 5: 4,100 SF

TOTAL: 21,808 SF

SPACES REQUIRED OFFICE SPACE (1:300 SF): 10% TOD CREDIT PARKING REQUIRED:

21,808 SF 73 SPACES -7 SPACES 66 SPACES

TOTAL PARKING PROVIDED:

69 SPACES NOTE: ACCESSIBLE PARKING IS PROVIDED IN ACCORDANCE WITH ADA

REQUIRED LANDSCAPE: PROVIDED LANDSCAPE:

AND TAS STANDARDS.


4,946 SF (20%) 6,761 SF (27%)


IMPERVIOUS SURFACE AREA:

17,991 SF

# SITE PLAN NOTES

- ANY REVISION TO THIS SITE PLAN WILL REQUIRE TOWN APPROVAL AND WILL REQUIRE REVISIONS TO ANY CORRESPONDING PLANS TO AVOID CONFLICTS BETWEEN PLANS.
- OPEN STORAGE, WHERE PERMITTED, SHALL BE SCREENED IN ACCORDANCE WITH THE ZONING ORDINANCE.
- GREATER ON A LOT SHALL HAVE AUTOMATIC FIRE SPRINKLERS INSTALLED THROUGHOUT ALL STRUCTURES. ALTYERNATIVE FIRE PROTECTION MEASURES MAY BE APPROVED BYTHE FIRE
- ALL FENCES AND RETAINING WALLS SHALL BE SHOWN ON THE SITE PLAN AND ARE SUBJECT TO BUILDING INSPECTION DIVISION
- APPROVAL.
  OWNER SHALL PROVIDE TRASH SERVICE FOR BUILDING.
  ENCLOSED DUMPSTER IS NOT PROVIDED.

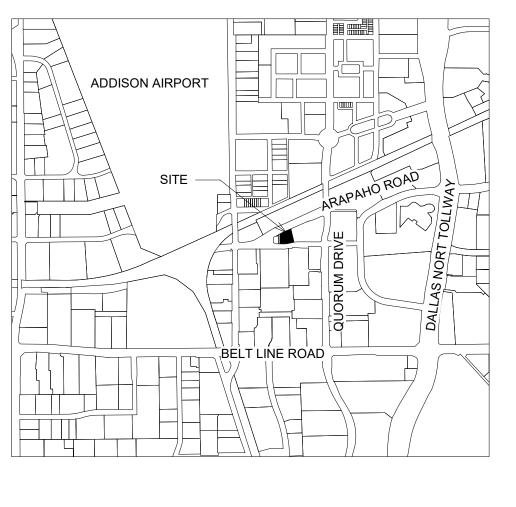

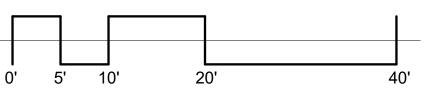

TRUE NORTH

Owner: JR Baumann Holdings LLC 4801 Arapaho Road


Architect/Applicant: Suite 104 Richardson, Texas 75080 Civil Engineer:

Pacheco Koch 7557 Rambler Road Suite 1400 Dallas, Texas 75231

07/06/2020 PROJECT NO: 19006 LAST REVISION: 09/24/20

Conceptual Site Plan

SHEET NUMBER:

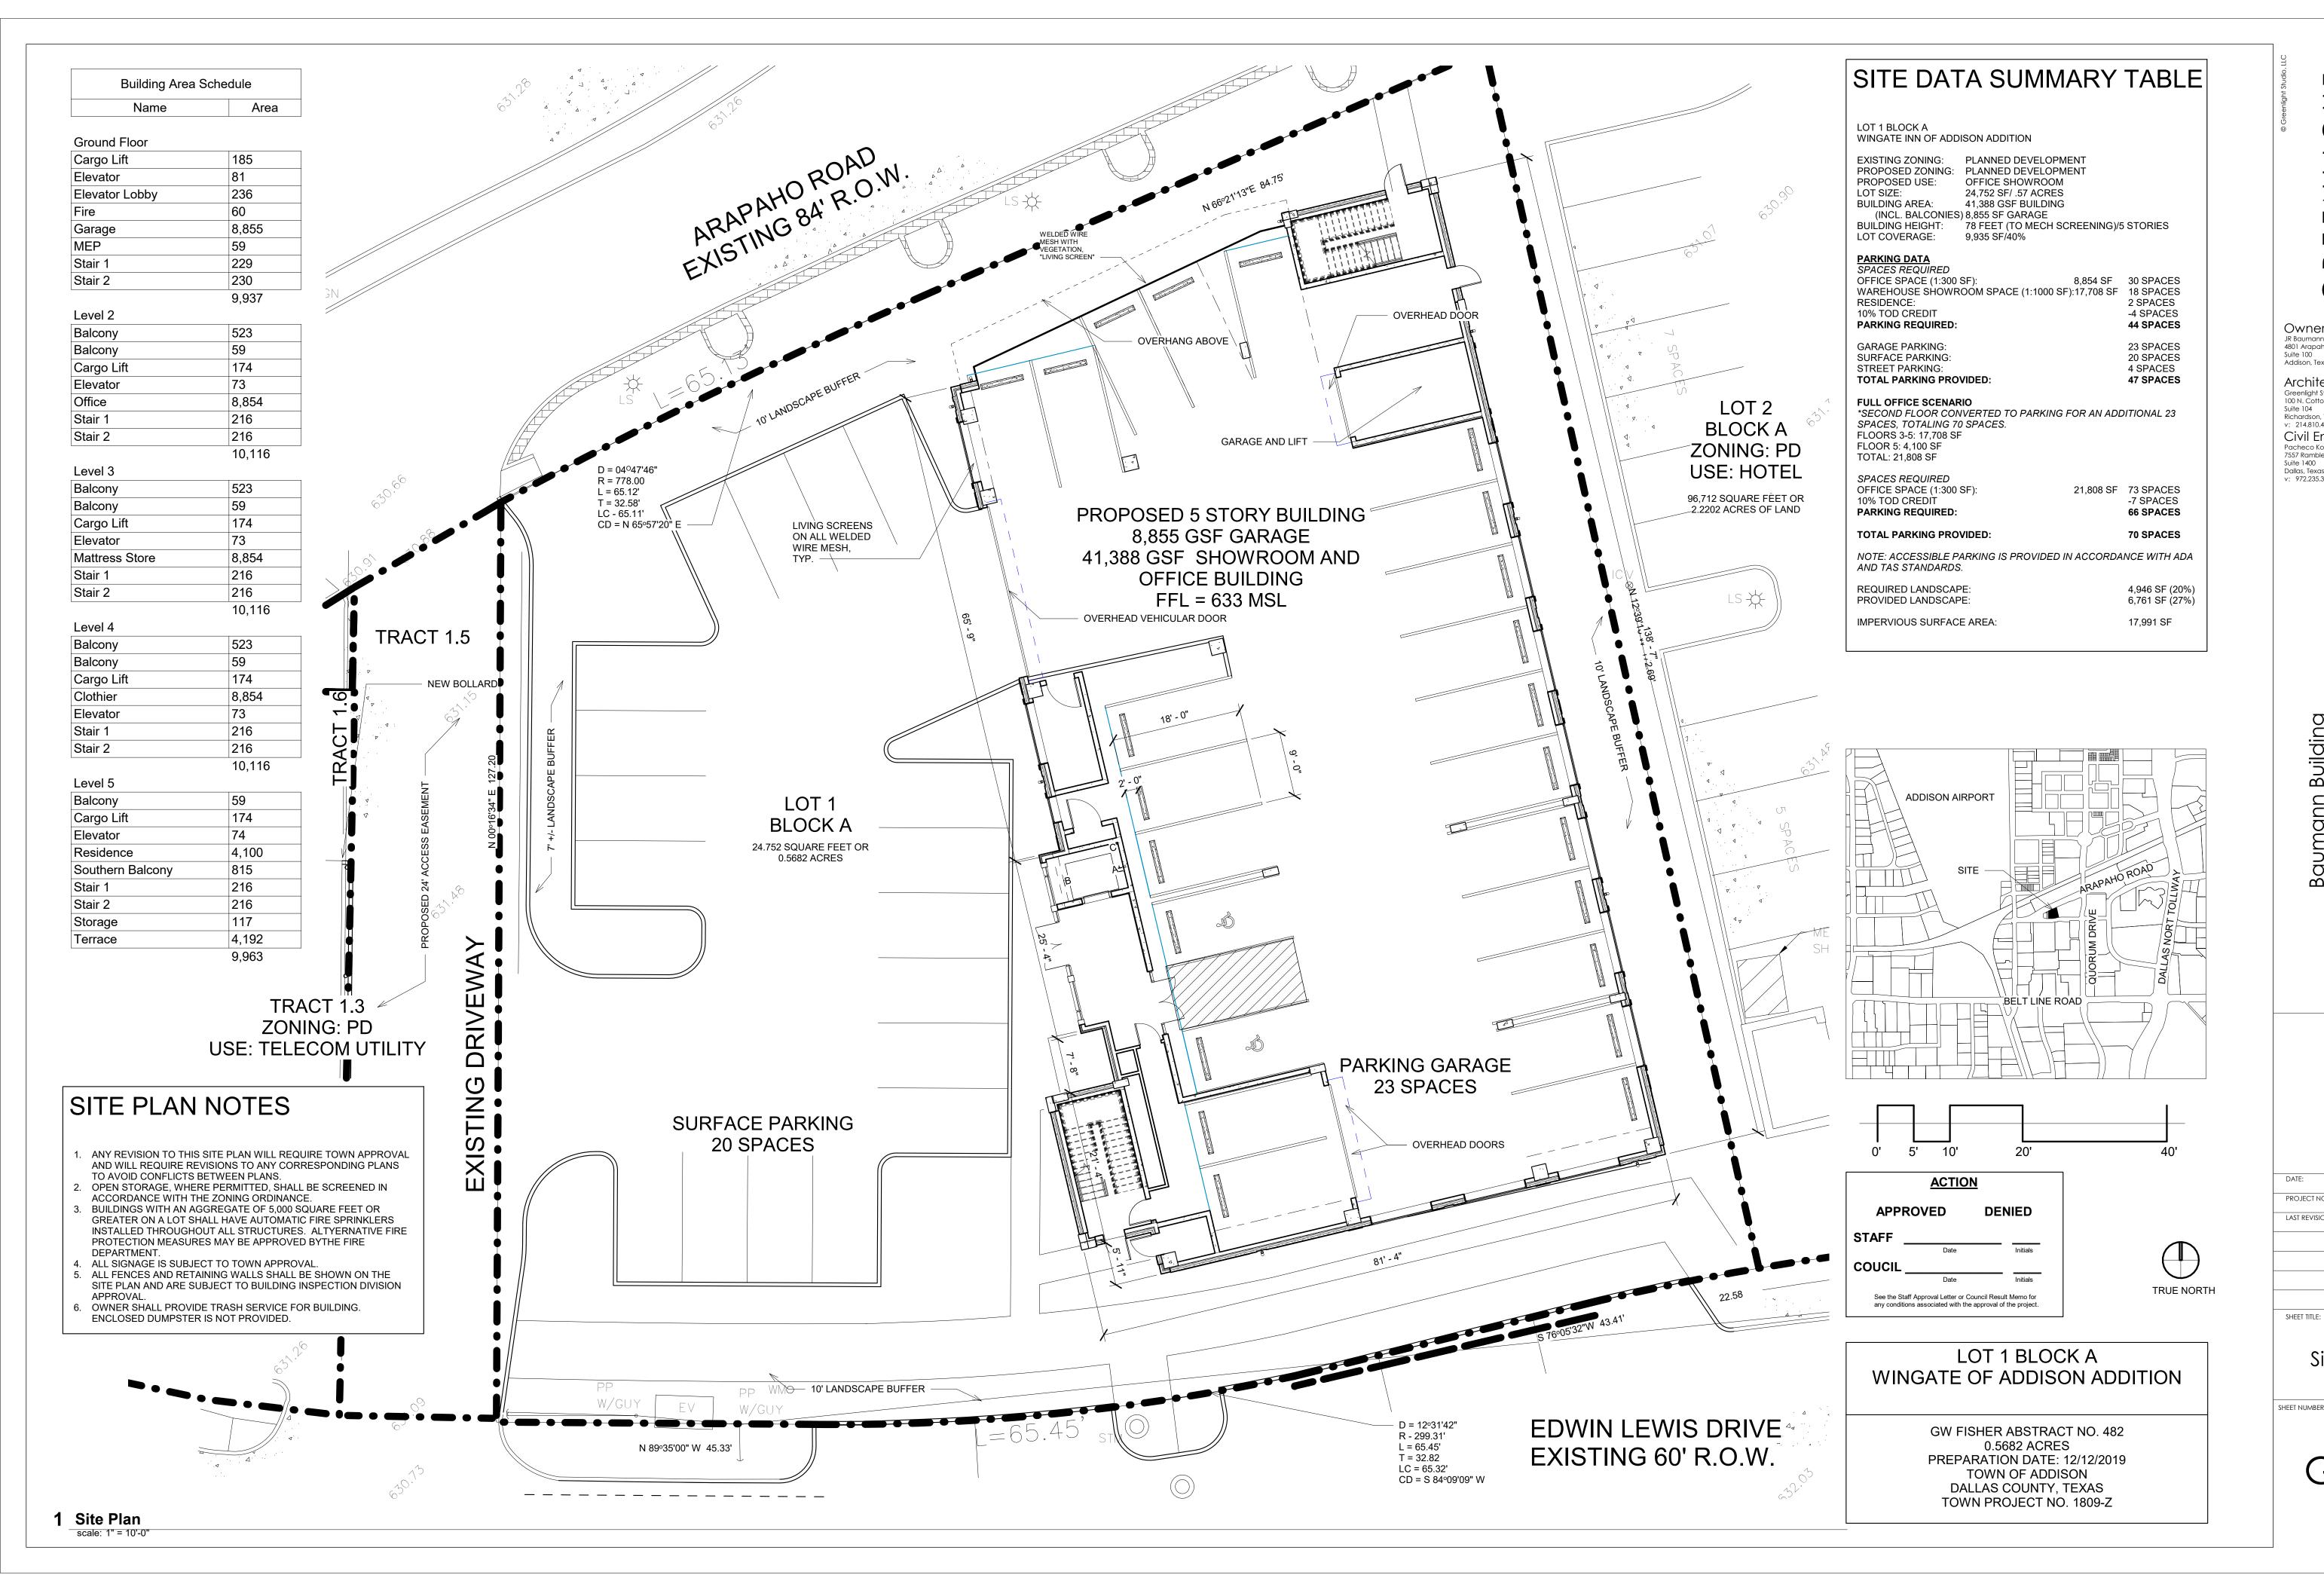

Owner: JR Baumann Holdings LLC 4801 Arapaho Road Suite 100 Addison, Texas 75001


Architect/Applicant: Suite 104 Richardson, Texas 75080

v: 214.810.4535 Civil Engineer: Pacheco Koch 7557 Rambler Road Suite 1400 Dallas, Texas 75231 v: 972.235.3031

07/06/2020 PROJECT NO: 19006 LAST REVISION: 10/09/20

Site Plan

SHEET NUMBER:

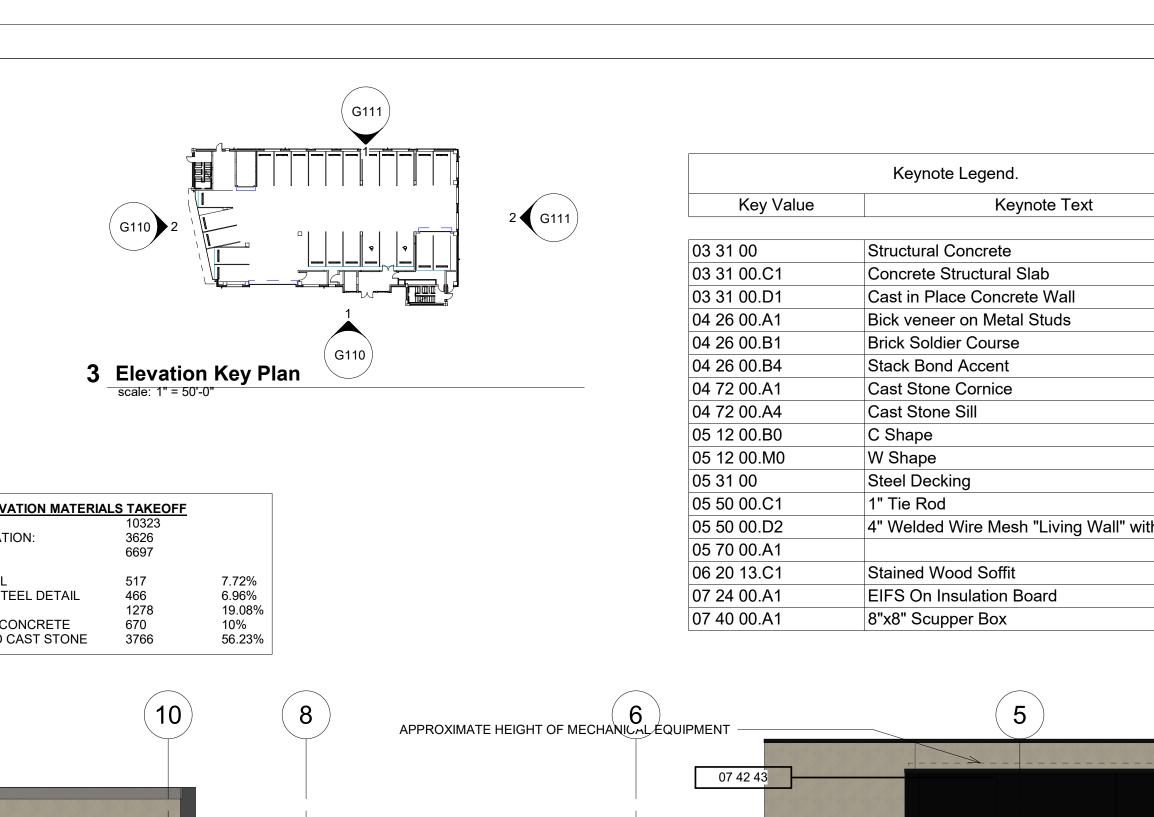




08/12/20

Keynote Legend.

Keynote Text

Key Value

WELDED WIRE MESH BLACK PAINTED PLANT VINES AS A LIVING SCREEN

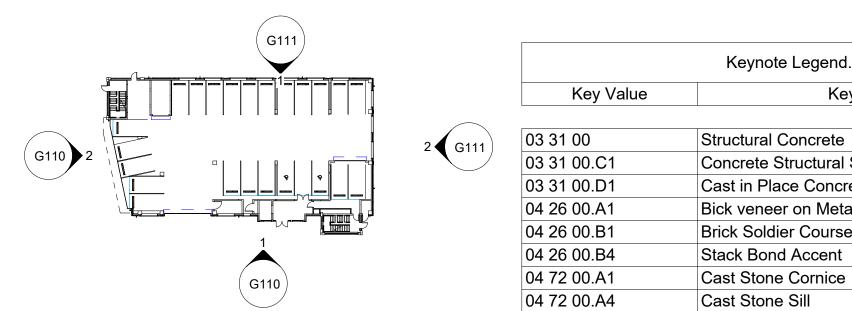

3	Elevation Key Plan.
	scale: 1" = 50'-0"

ΓΟΤΑL:	10281 SF	
FENESTRATION:	2083 SF	
RESULT:	8198 SF	
ACM PANEL	190	2.32%
PAINTED STEEL DETAIL	229	2.79%
EIFS	1036	12.64%
EXPOSED CONCRETE	534	6.51%
BRICK AND CAST STONE	621	75.74%

SOUTH ELEVATION MATERIALS TAKEOFF

1462 SF

4831 SF

229

303 3669

2.23%

4.75%

10.81%

6.27%

75.94%

FENESTRATION:

PAINTED STEEL DETAIL

EXPOSED CONCRETE

BRICK AND CAST STONE

RESULT:

ACM PANEL

Key Value	Keynote Text			
03 31 00	Structural Concrete			
03 31 00.C1	Concrete Structural Slab			
03 31 00.D1	Cast in Place Concrete Wall			
04 26 00.A1	Bick veneer on Metal Studs			
04 26 00.B1	Brick Soldier Course			
04 26 00.B4	Stack Bond Accent			
04 72 00.A1	Cast Stone Cornice			
04 72 00.A4	Cast Stone Sill			
05 12 00.B0	C Shape			
05 12 00.M0	W Shape			
05 31 00	Steel Decking			
05 50 00.C1	1" Tie Rod			
05 50 00.D2	4" Welded Wire Mesh "Living Wall" with vines			
05 70 00.A1				
06 20 13.C1	Stained Wood Soffit			
07 24 00.A1	EIFS On Insulation Board			
07 40 00.A1	8"x8" Scupper Box			

Key Value	Keynote Text
07 40 00.A2	4" Round Downspout
07 40 00.B2	6"x6" Square Gutter
07 42 43	Aluminum Faced Wall Panels
07 54 23.B1	TPO Roofing, Roof Board, 4" Rigid Insulation over Metal Deck
07 62 00.B1	4" Roof Edge
08 11 00.A2	Aluminum Steel Profile Door
08 11 13.A1	Hollow Metal Door and Frame
08 33 00.C1	Overhead Coiling Door With Motor
08 43 00.C1	Storefront/Steel Window System
08 51 13.A1	Steel Profile Aluminum Window
08 51 23	Steel Windows
09 00 00.A1	Gypsum Wall Assembly, Refer to Wall Types
09 24 00.A2	7/8" Cement Plaster
14 21 23.16	Machine Room-Less Traction Passenger Elevator
32 17 13	Wheel Stop

03 31 00

Keynote Legend.

(11)5 8 6 (10) (12) \_07 62 00.B1 APPROXIMATE HEIGHT OF APPROXIMATE HEIGHT OF MECHANICAL EQUIPMENT MECHANICAL EQUIPMENT 05 12 00.M0 Roof 70' - 0" 07 24 00.A1 05 12 00.M0 07 24 00.A1 04 72 00.A1 Level 5 56' - 0" 04 26 00.A1 04 72 00.A1 05 70 00.A1 04 26 00.B4 And the second s 04 26 00.B4 07 40 00.A2 08 51 13.A1 03 31 00 08 51 13.A1 Level 3 28' - 0" 08 51 13.A1 04 26 00.B4 07 40 00.A2 08 51 13.A1 04 26 00.B1 Level 2 14' - 0" 05 50 00.D2 Ground Floor 0' - 0" 05 50 00.D2 COLOR 1 CONGAREE VISTA, HANSEN BRICK MODULAR BRICK SHEET TITLE: COLOR 2 AUGUST, CHEROKEE BRICK MODULAR BRICK FACADE PLAN NOTES **EXTERIOR** BASF 3908 CRESCENT 1 Facade Plan - East 2 Facade Plan - South INSULATION AND scale: 1/8" = 1'-0" FINISH SYSTEM This Facade Plan is for conceptual purposes only. All building plans require review and approval by SHEET NUMBER: Development Services. EXPOSED CONCRETE BUFFED AND SEALED 2. All mechanical units shall be screened from public view as required by the Zoning Ordinance. When permitted, exposed utility boxes and conduits shall be painted to match the building. **BLACK PAINTED** 

4. All signage areas and locations are subject to approval

CAST STONE

**BUFF COLOR** 

WELDED WIRE MESH BLACK PAINTED PLANT VINES AS A LIVING SCREEN

. Roof access shall be provided internally,unless

otherwise permitted by the Chief Building Official

by Development Services.

07/06/2020 PROJECT NO: 19006 LAST REVISION: 10/09/20

Z

 $\mathcal{C}$ 

Owner:

JR Baumann Holdings LLC 4801 Arapaho Road

Suite 104 Richardson, Texas 75080

Civil Engineer:
Pacheco Koch
7557 Rambler Road


v: 214.810.4535

Suite 1400 Dallas, Texas 75231 v: 972.235.3031

Architect/Applicant:
Greenlight Studio LLC
100 N. Cottonwood Drive


Suite 100 Addison, Texas 75001

Facade Plans

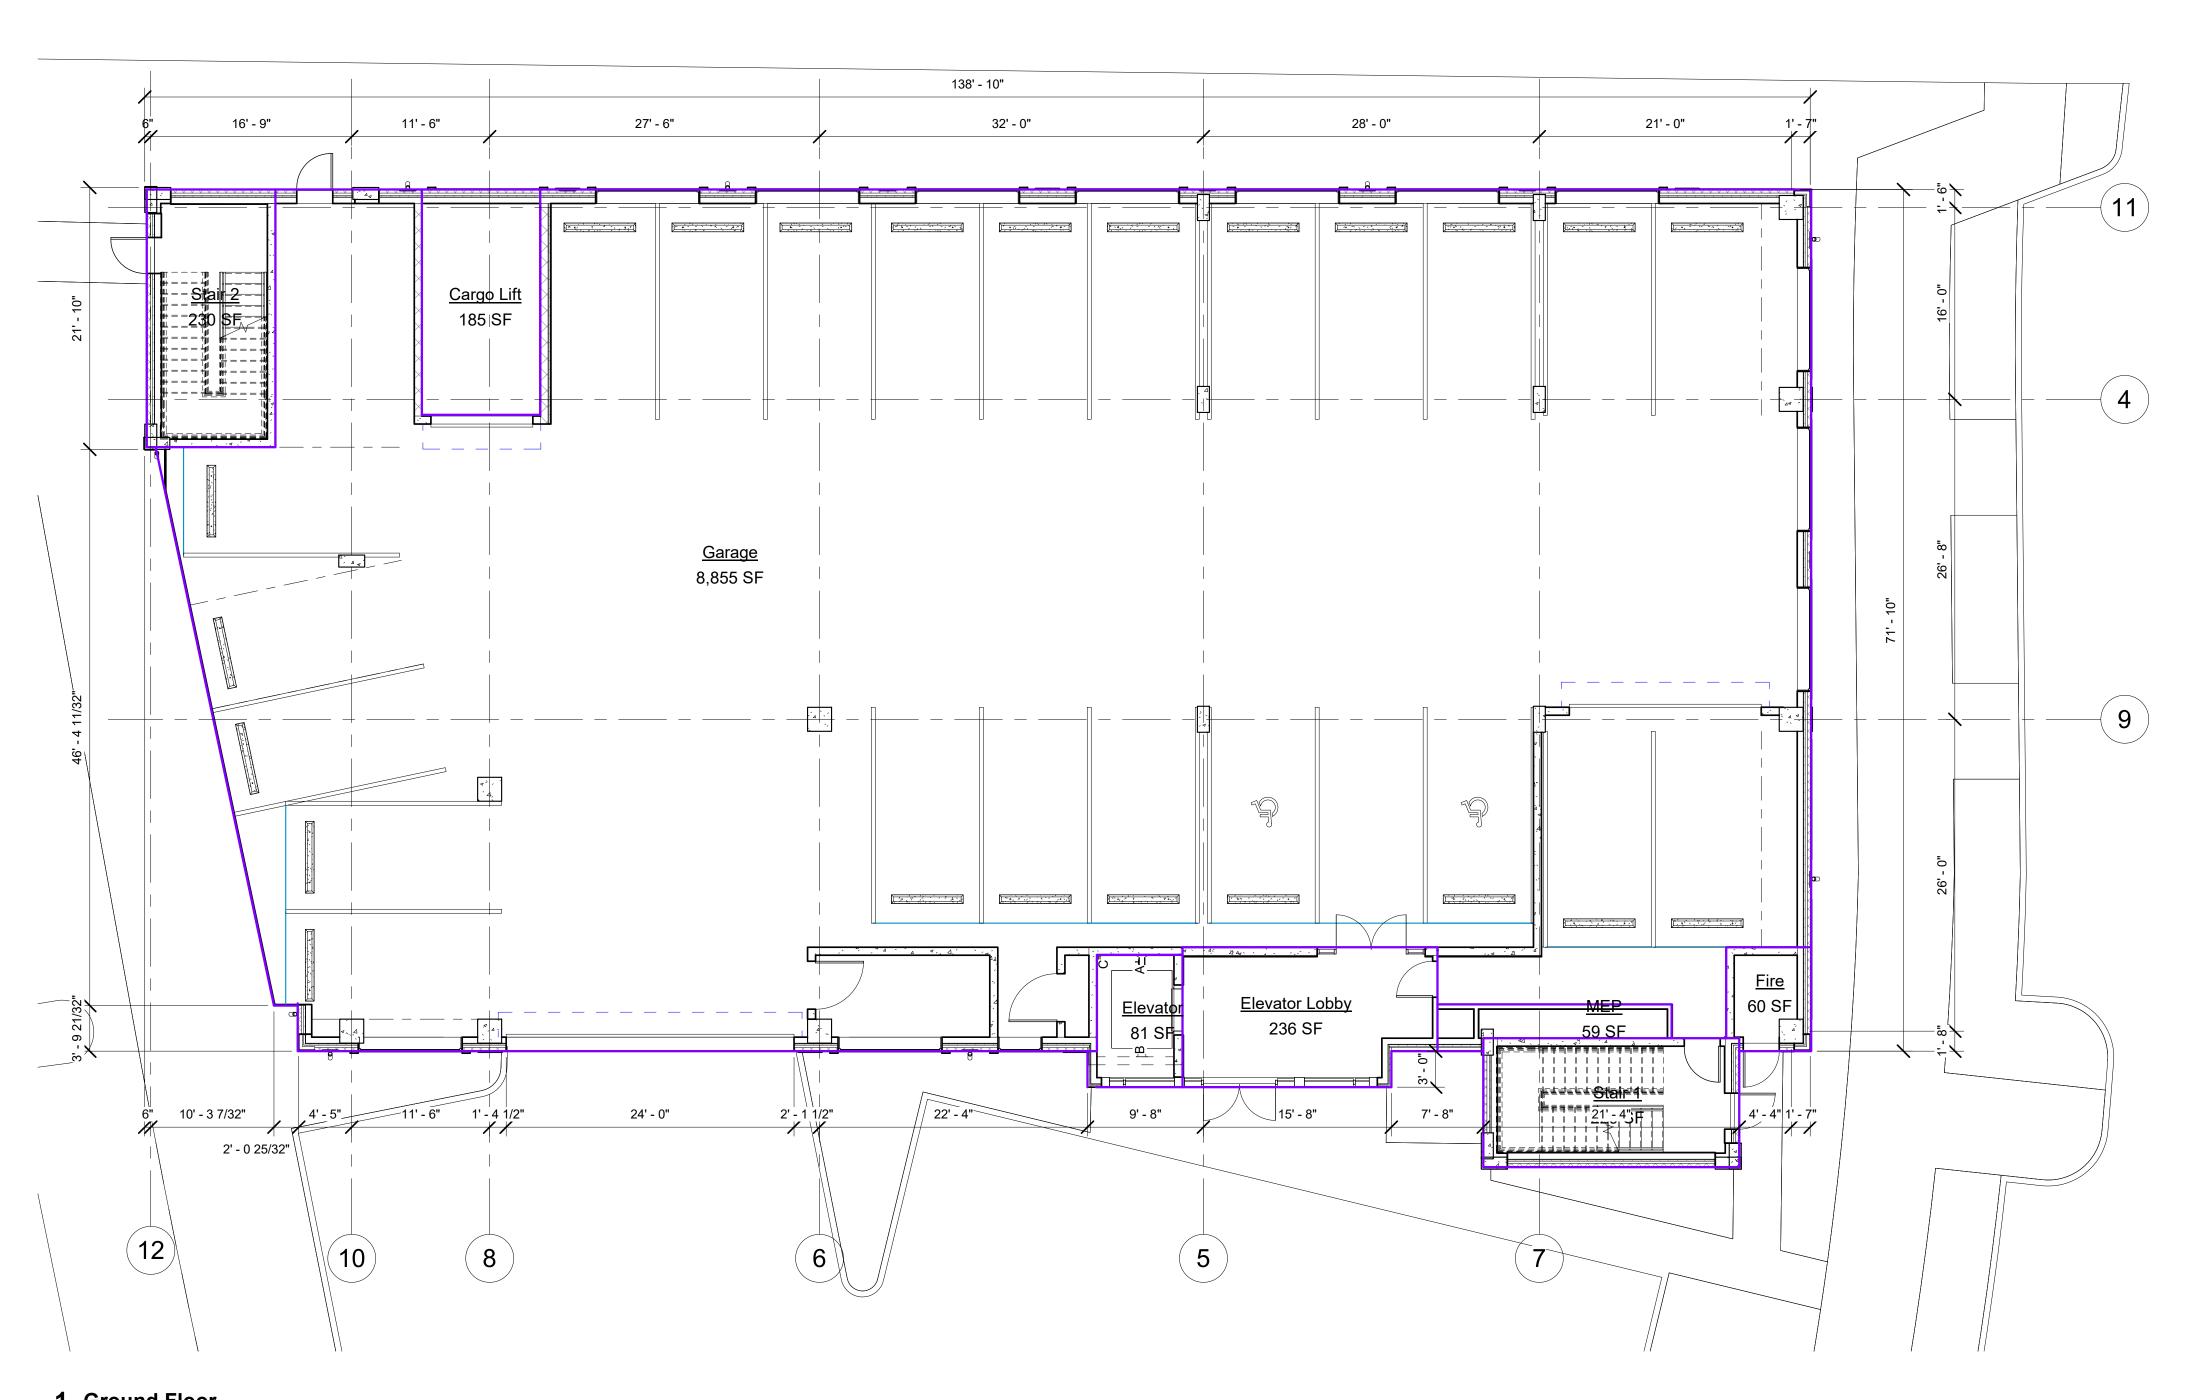

1 Ground Floor scale: 1/8" = 1'-0"

- 1. ALL PARTITIONS ARE TO BE TYPE A UNLESS
- OTHERWISE NOTED. 2. DO NOT SCALE DRAWINGS. IF DIMENSIONS ARE IN QUESTION, THE CONTRACTOR SHALL BE RESPONSIBLE FOR OBTAINING CLARIFICATIONS FROM THE ARCHITECT.
- 3. CONTRACTOR TO VERIFY ALL MEP AND STRUCTURAL ENCLOSURES.
- 4. DIMENSIONS SHOWN ON THE FLOOR PLANS ARE FROM CENTERLINE OF COLUMNS TO FACE OF FINISH OF INTERIOR WALLS AND TO FACE OF FINISH OF EXTERIOR WALLS UNLESS OTHERWISE INDICATED OR DETAILED.
- 5. FOR FURTHER DIMENSIONING, SEE LARGE SCALE
- PLANS, SECTIONS, ELEVATIONS, AND DETAILS. 6. SEE SHEET A8.01 FOR TYPICAL MOUNTING HEIGHTS OF PLUMBING FIXTURES AND TOILET ACCESSORIES.
- 7. CAULK AT JUNCTURE OF INTERIOR FACES OF DOOR FRAMES, VIEW WINDOW FRAMES, EXT. WINDOW FRAMES, CABINET WORK, AND CASEWORK W/ ADJACENT MATERIALS EVEN THOUGH JOINT MAY NOT BE VISIBLE.
- 8. PROVIDE 5/8" TYPE "X" GYP. BOARD ON ALL UNFINISHED WALLS.
- 9. PROVIDE INSULATION ON ALL EXTERIOR WALLS AS INDICATED IN THE COMCHECK INCLUDED IN THE DOCUMENTS.
- 10. ADD SUFFICIENT BLOCKING IN STUD WALLS TO SUPPORT ALL ITEMS OR EQUIPMENT SHOWN OR SPECIFIED TO BE ATTACHED TO THE WALLS. PROVIDE ADDITIONAL STRUCTURAL SUPPORT (ANGLES, CHANNELS, ETC.) WITHIN WALLS WHERE WEIGHT OF ATTACHED ITEMS IS TOO GREAT TO BE SUPPORTED BY METAL STUDS.
- 11. ADD METAL STRAPS TO AREAS WITH LIGHTWEIGHT WALL MOUNTED EQUIPMENT OR FINISHES WHICH CANNOT MOUNT TO STUD SPACING. 12. ALL DOOR FRAMES TO BE LOCATED 4" FROM
- ADJACENT WALL TO INSIDE OF DOOR FRAME UNLESS NOTED OTHERWISE. 13. THERE SHALL BE NO WALL ACCESS PANELS IN THE PUBLIC SPACES. ALL ACCESS PANEL LOCATIONS
- SHALL BE APPROVED BY THE ARCHITECT. 14. PROVIDE WATER RESISTANT GYP BOARD AT ALL PLUMBING FIXTURES, WITH THE EXCEPTION OF TILE BACKER AT TILED SHOWERS. DO NOT INSTALL
- WATER RESISTANT GYP BOARD IN CEILINGS. 15. DO NOT BOLT, SHOT FASTEN, OR PENETRATE BOTTOM SURFACE OF JOISTS AND BEAMS. DO NOT BOLT HEAVY LOADS INTO FLAT SECTIONS OF SLABS. REVIEW PROPOSED CORE PENETRATIONS IN STRUCTURAL FLOORS, ROOFS, AND WALLS WITH ARCHITECT.

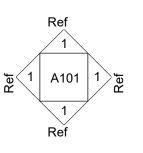

EXTERIOR ELEVATION



WALL SECTION

DOOR TAG

101

WINDOW TAG

WALL TYPE

TRUE NORTH

SPOT ELEVATION

07/06/2020 PROJECT NO: LAST REVISION: 10/09/20

 $\mathcal{L}$ 

Owner:

JR Baumann Holdings LLC 4801 Arapaho Road

Greenlight Studio LLC 100 N. Cottonwood Drive

Suite 104 Richardson, Texas 75080 v: 214.810.4535

Civil Engineer:

Pacheco Koch

v: 972.235.3031


7557 Rambler Road Suite 1400 Dallas, Texas 75231

Architect/Applicant:

Suite 100 Addison, Texas 75001

Ground Floor

SHEET NUMBER:

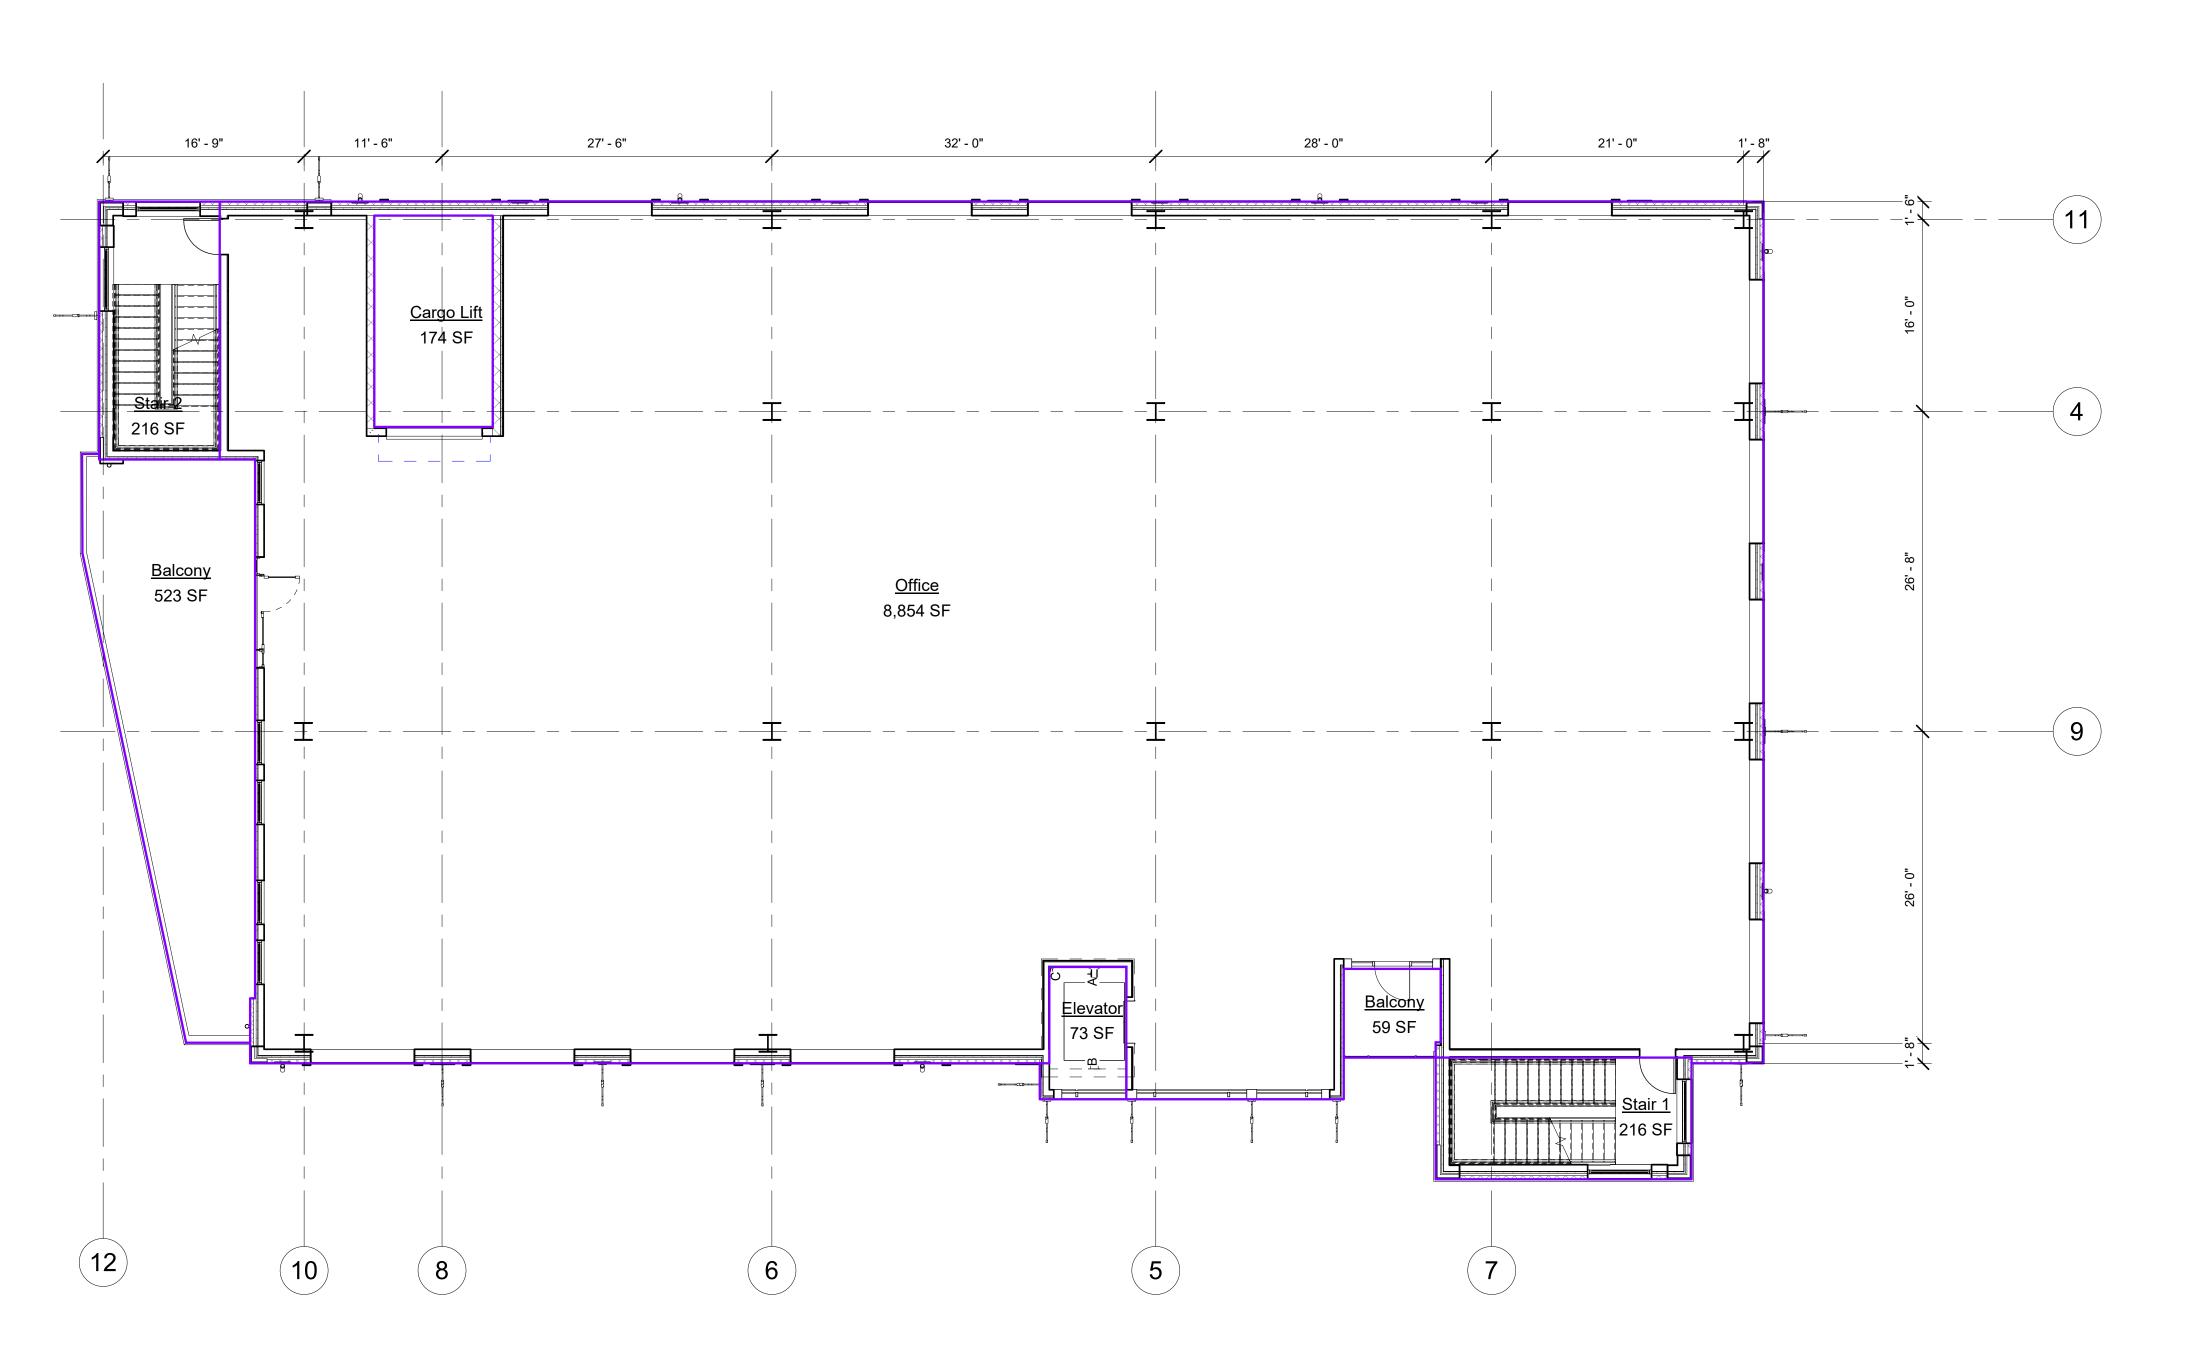

1 Level 2 scale: 1/8" = 1'-0"

ALL PARTITIONS ARE TO BE TYPE A UNLESS
 OTHERWISE NOTED.

OTHERWISE NOTED.

2. DO NOT SCALE DRAWINGS. IF DIMENSIONS ARE IN QUESTION, THE CONTRACTOR SHALL BE RESPONSIBLE FOR OBTAINING CLARIFICATIONS FROM THE APCHITECT

THE ARCHITECT.
3. CONTRACTOR TO VERIFY ALL MEP AND STRUCTURAL

ENCLOSURES.

4. DIMENSIONS SHOWN ON THE FLOOR PLANS ARE FROM CENTERLINE OF COLUMNS TO FACE OF FINISH OF INTERIOR WALLS AND TO FACE OF FINISH OF EXTERIOR WALLS UNLESS OTHERWISE INDICATED OR

5. FOR FURTHER DIMENSIONING, SEE LARGE SCALE PLANS, SECTIONS, ELEVATIONS, AND DETAILS.

PLANS, SECTIONS, ELEVATIONS, AND DETAILS.
6. SEE SHEET A8.01 FOR TYPICAL MOUNTING HEIGHTS OF PLUMBING FIXTURES AND TOILET ACCESSORIES.

7. CAULK AT JUNCTURE OF INTERIOR FACES OF DOOR FRAMES, VIEW WINDOW FRAMES, EXT. WINDOW FRAMES, CABINET WORK, AND CASEWORK W/ ADJACENT MATERIALS EVEN THOUGH JOINT MAY NOT BE VISIBLE.

8. PROVIDE 5/8" TYPE "X" GYP. BOARD ON ALL UNFINISHED WALLS.

9. PROVIDE INSULATION ON ALL EXTERIOR WALLS AS INDICATED IN THE COMCHECK INCLUDED IN THE DOCUMENTS.

10. ADD SUFFICIENT BLOCKING IN STUD WALLS TO SUPPORT ALL ITEMS OR EQUIPMENT SHOWN OR SPECIFIED TO BE ATTACHED TO THE WALLS. PROVIDE ADDITIONAL STRUCTURAL SUPPORT (ANGLES, CHANNELS, ETC.) WITHIN WALLS WHERE WEIGHT OF ATTACHED ITEMS IS TOO GREAT TO BE SUPPORTED BY METAL STUDS.

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ADJACENT WALL TO INSIDE OF DOOR FRAME UNLESS NOTED OTHERWISE.

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PUBLIC SPACES. ALL ACCESS PANEL LOCATIONS
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BACKER AT TILED SHOWERS. DO NOT INSTALL WATER RESISTANT GYP BOARD IN CEILINGS.


15. DO NOT BOLT, SHOT FASTEN, OR PENETRATE BOTTOM SURFACE OF JOISTS AND BEAMS. DO NOT BOLT HEAVY LOADS INTO FLAT SECTIONS OF SLABS. REVIEW PROPOSED CORE PENETRATIONS

IN STRUCTURAL FLOORS, ROOFS, AND WALLS WITH

Ref 1 A101 1 to

ARCHITECT.

EXTERIOR ELEVATION

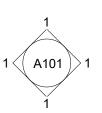

INTERIOR ELEVATION

WALL SECTION

101

WINDOW TAG

DOOR TAG



WALL TYPE



SPOT ELEVATION



PROJECT NO: 19006

LAST REVISION: 10/09/20

SHEET TITLE:

Floor 2

 $\mathcal{L}$ 

Owner:

JR Baumann Holdings LLC 4801 Arapaho Road

Greenlight Studio LLC 100 N. Cottonwood Drive

Suite 104 Richardson, Texas 75080 v: 214.810.4535

Civil Engineer:


Pacheco Koch 7557 Rambler Road


Suite 1400 Dallas, Texas 75231 v: 972.235.3031

Architect/Applicant:

Suite 100 Addison, Texas 75001

SHEET NUMBER:

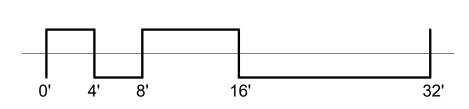

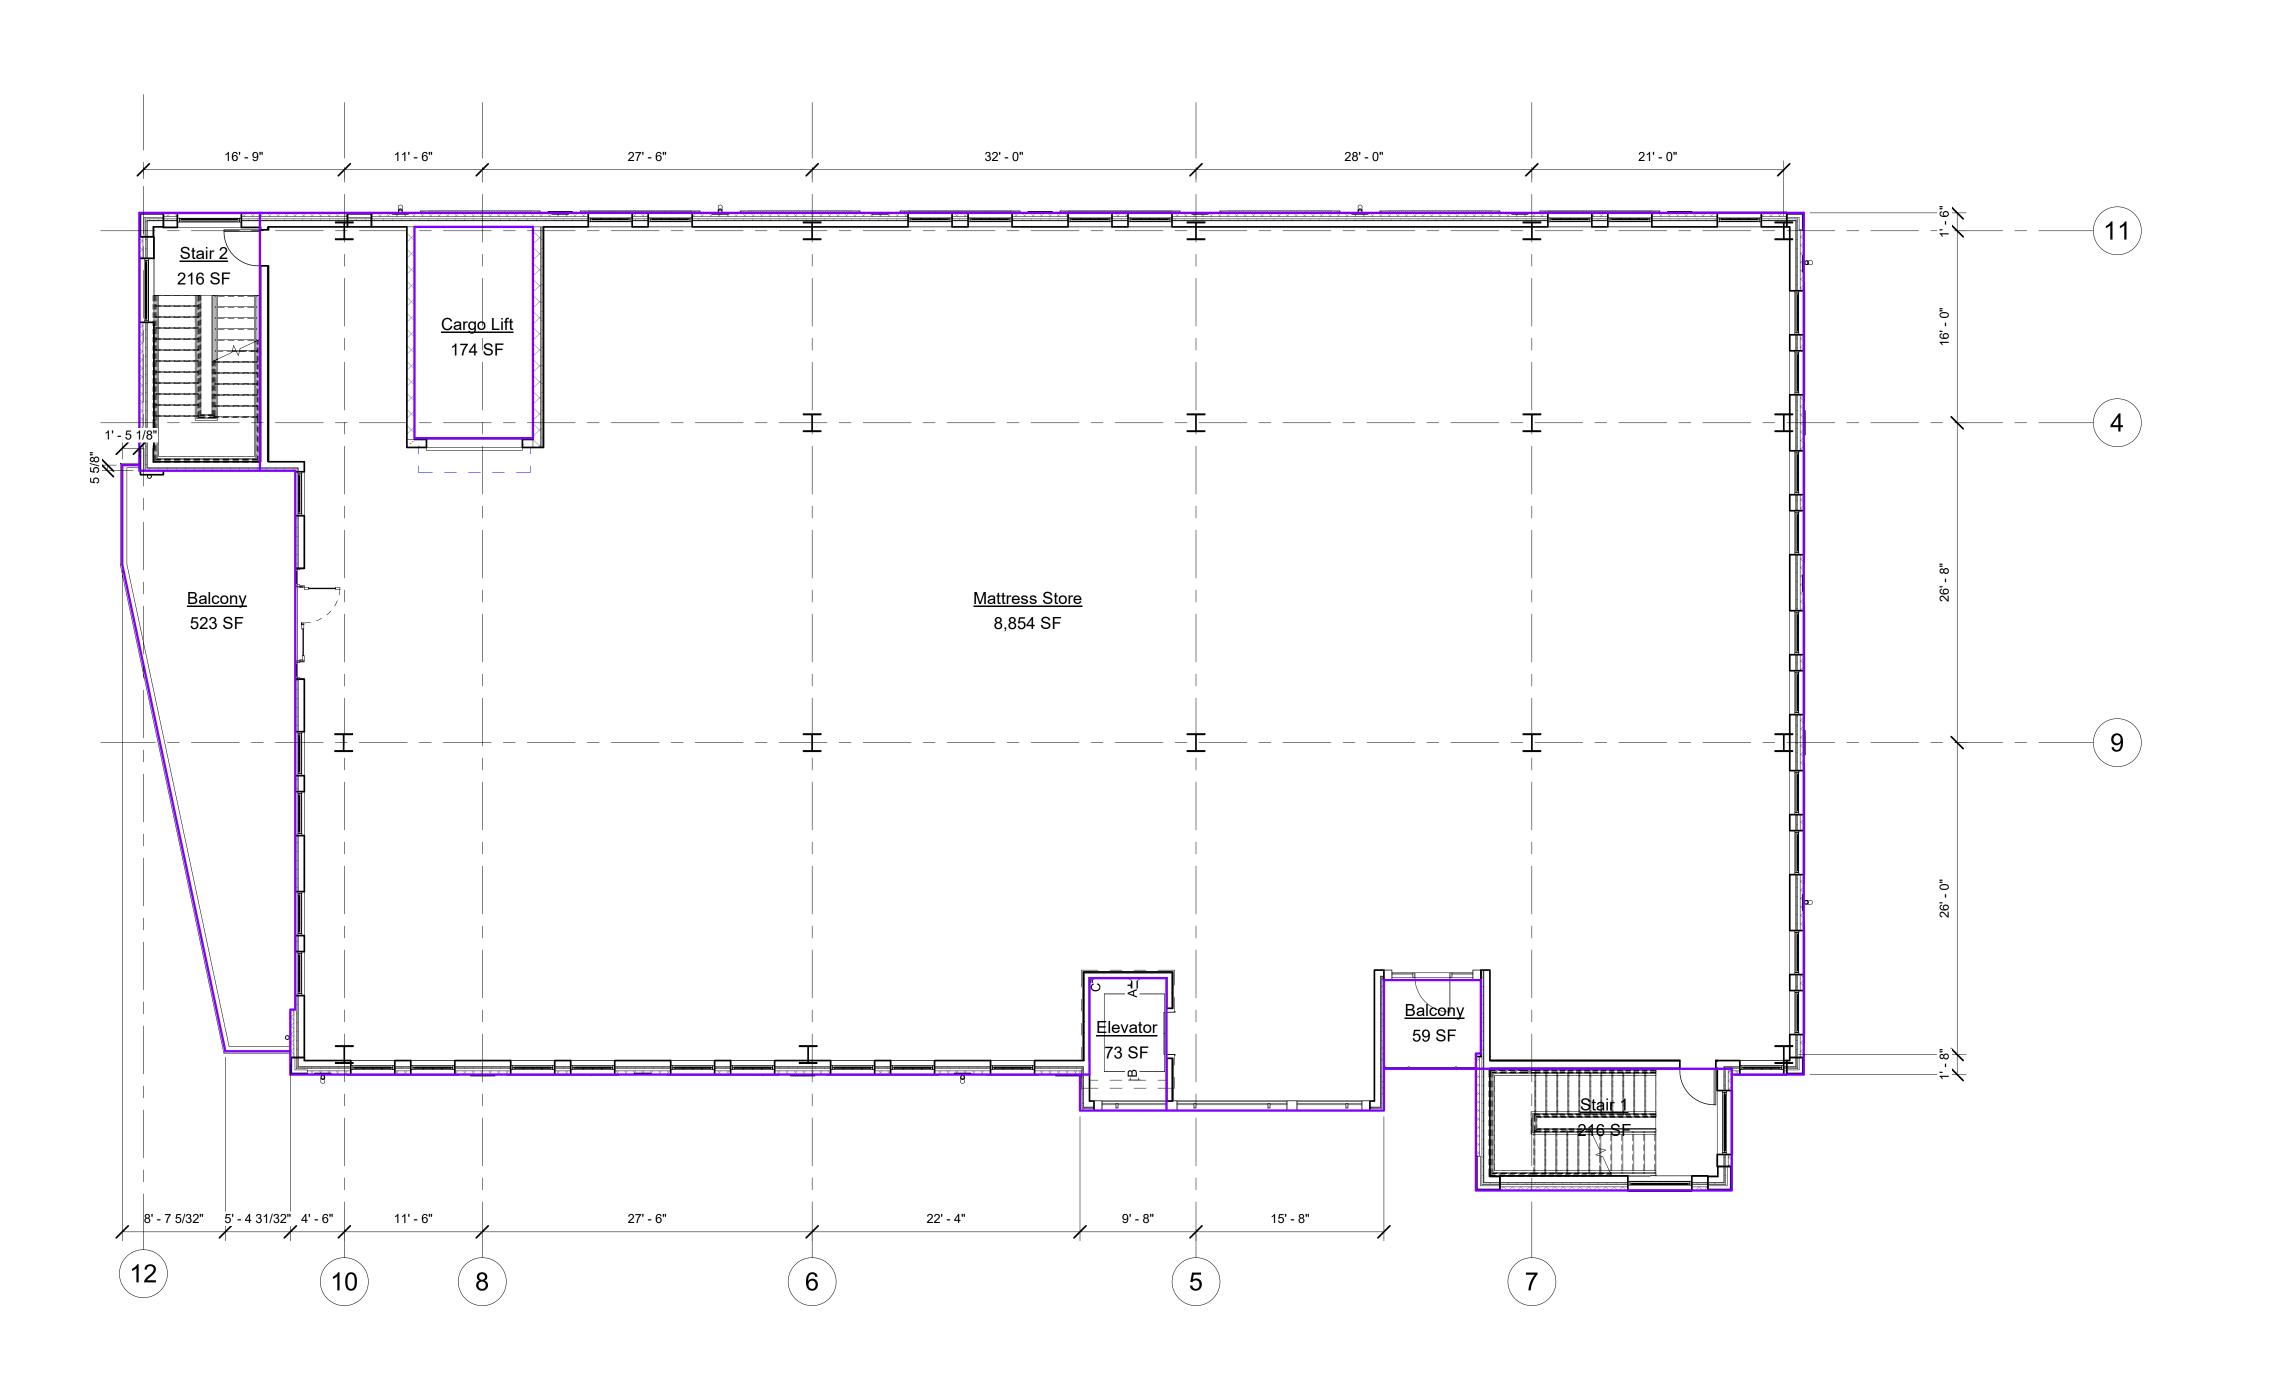

1 Level 3 (LEVEL 4 - IDENTICAL - 9,381 SF USE - CLOTHIER) scale: 1/8" = 1'-0"

1. ALL PARTITIONS ARE TO BE TYPE A UNLESS

OTHERWISE NOTED. 2. DO NOT SCALE DRAWINGS. IF DIMENSIONS ARE IN QUESTION, THE CONTRACTOR SHALL BE RESPONSIBLE FOR OBTAINING CLARIFICATIONS FROM THE ARCHITECT.

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PLANS, SECTIONS, ELEVATIONS, AND DETAILS. 6. SEE SHEET A8.01 FOR TYPICAL MOUNTING HEIGHTS OF PLUMBING FIXTURES AND TOILET ACCESSORIES.

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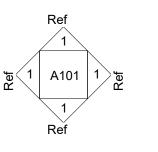
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EXTERIOR ELEVATION



WALL SECTION

DOOR TAG

WINDOW TAG



WALL TYPE

SPOT ELEVATION 07/06/2020 PROJECT NO: LAST REVISION: 10/09/20

Floors 3-4

 $\mathcal{L}$ 

Owner:

JR Baumann Holdings LLC 4801 Arapaho Road

Greenlight Studio LLC 100 N. Cottonwood Drive

Suite 104 Richardson, Texas 75080

Civil Engineer:

v: 214.810.4535


7557 Rambler Road Suite 1400 Dallas, Texas 75231 v: 972.235.3031

Pacheco Koch

Architect/Applicant:

Suite 100 Addison, Texas 75001

SHEET NUMBER:

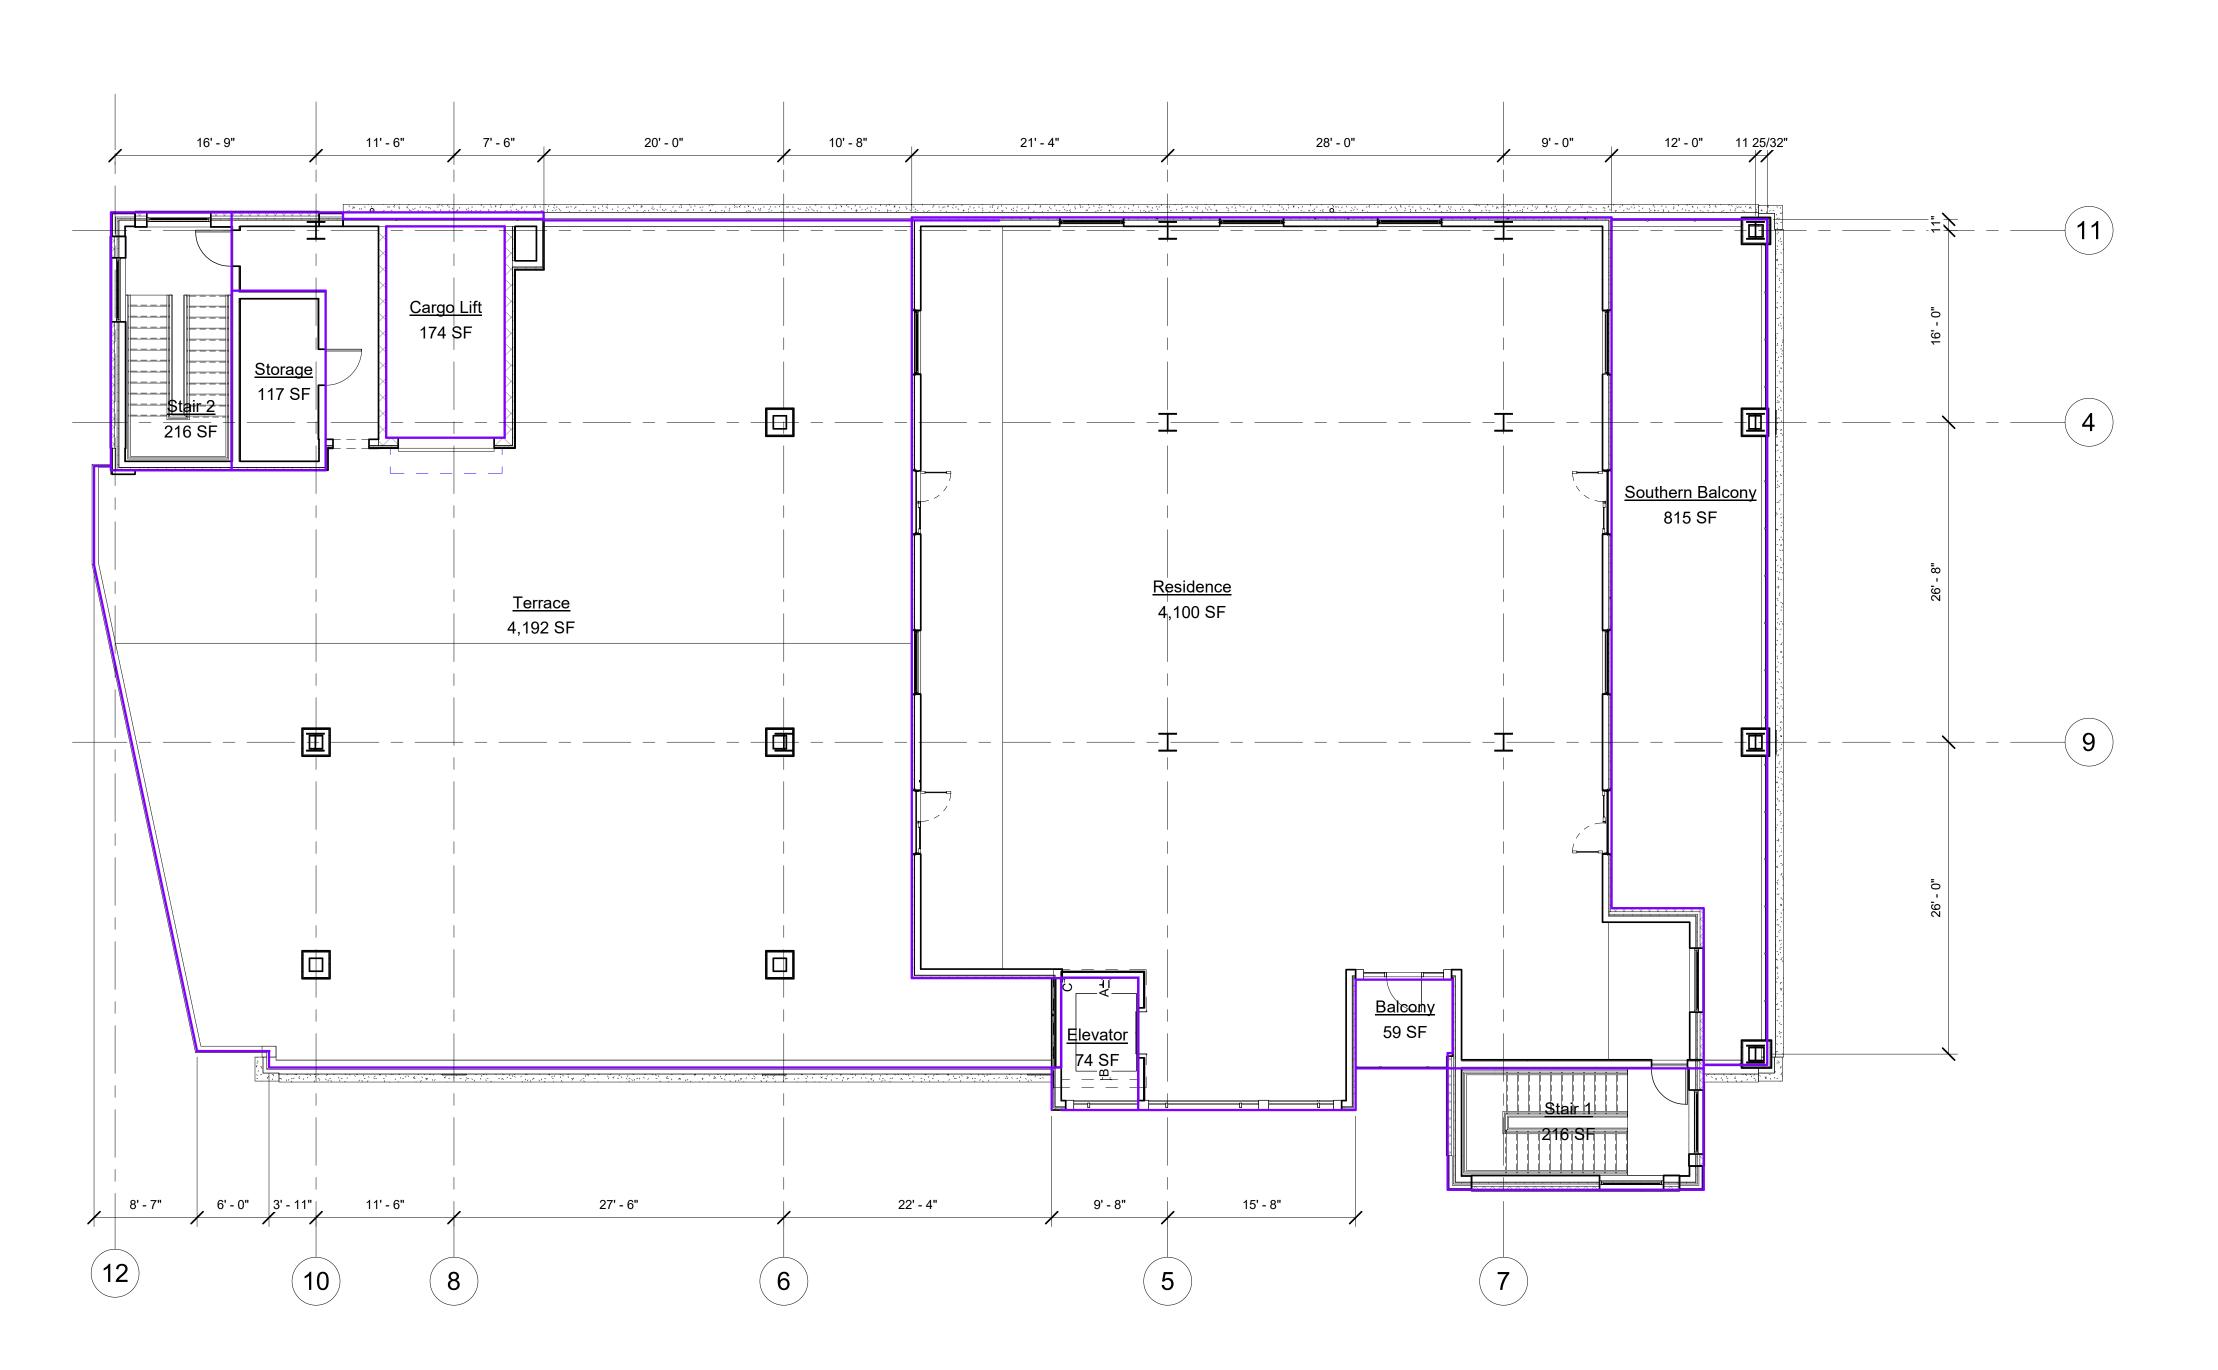

1 Level 5 scale: 1/8" = 1'-0"

1. ALL PARTITIONS ARE TO BE TYPE A UNLESS

OTHERWISE NOTED. 2. DO NOT SCALE DRAWINGS. IF DIMENSIONS ARE IN QUESTION, THE CONTRACTOR SHALL BE RESPONSIBLE FOR OBTAINING CLARIFICATIONS FROM

THE ARCHITECT. 3. CONTRACTOR TO VERIFY ALL MEP AND STRUCTURAL ENCLOSURES.

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EXTERIOR ELEVATION

INTERIOR ELEVATION

WALL SECTION

DOOR TAG 101

WINDOW TAG

WALL TYPE

SPOT ELEVATION

TRUE NORTH

07/06/2020 PROJECT NO: LAST REVISION: 10/09/20


Floor 5

 $\mathcal{L}$ JR Baumann Holdings LLC 4801 Arapaho Road Suite 100 Addison, Texas 75001 Architect/Applicant: Greenlight Studio LLC 100 N. Cottonwood Drive Suite 104 Richardson, Texas 75080 v: 214.810.4535 Civil Engineer:


Owner:

Pacheco Koch 7557 Rambler Road

Suite 1400 Dallas, Texas 75231 v: 972.235.3031

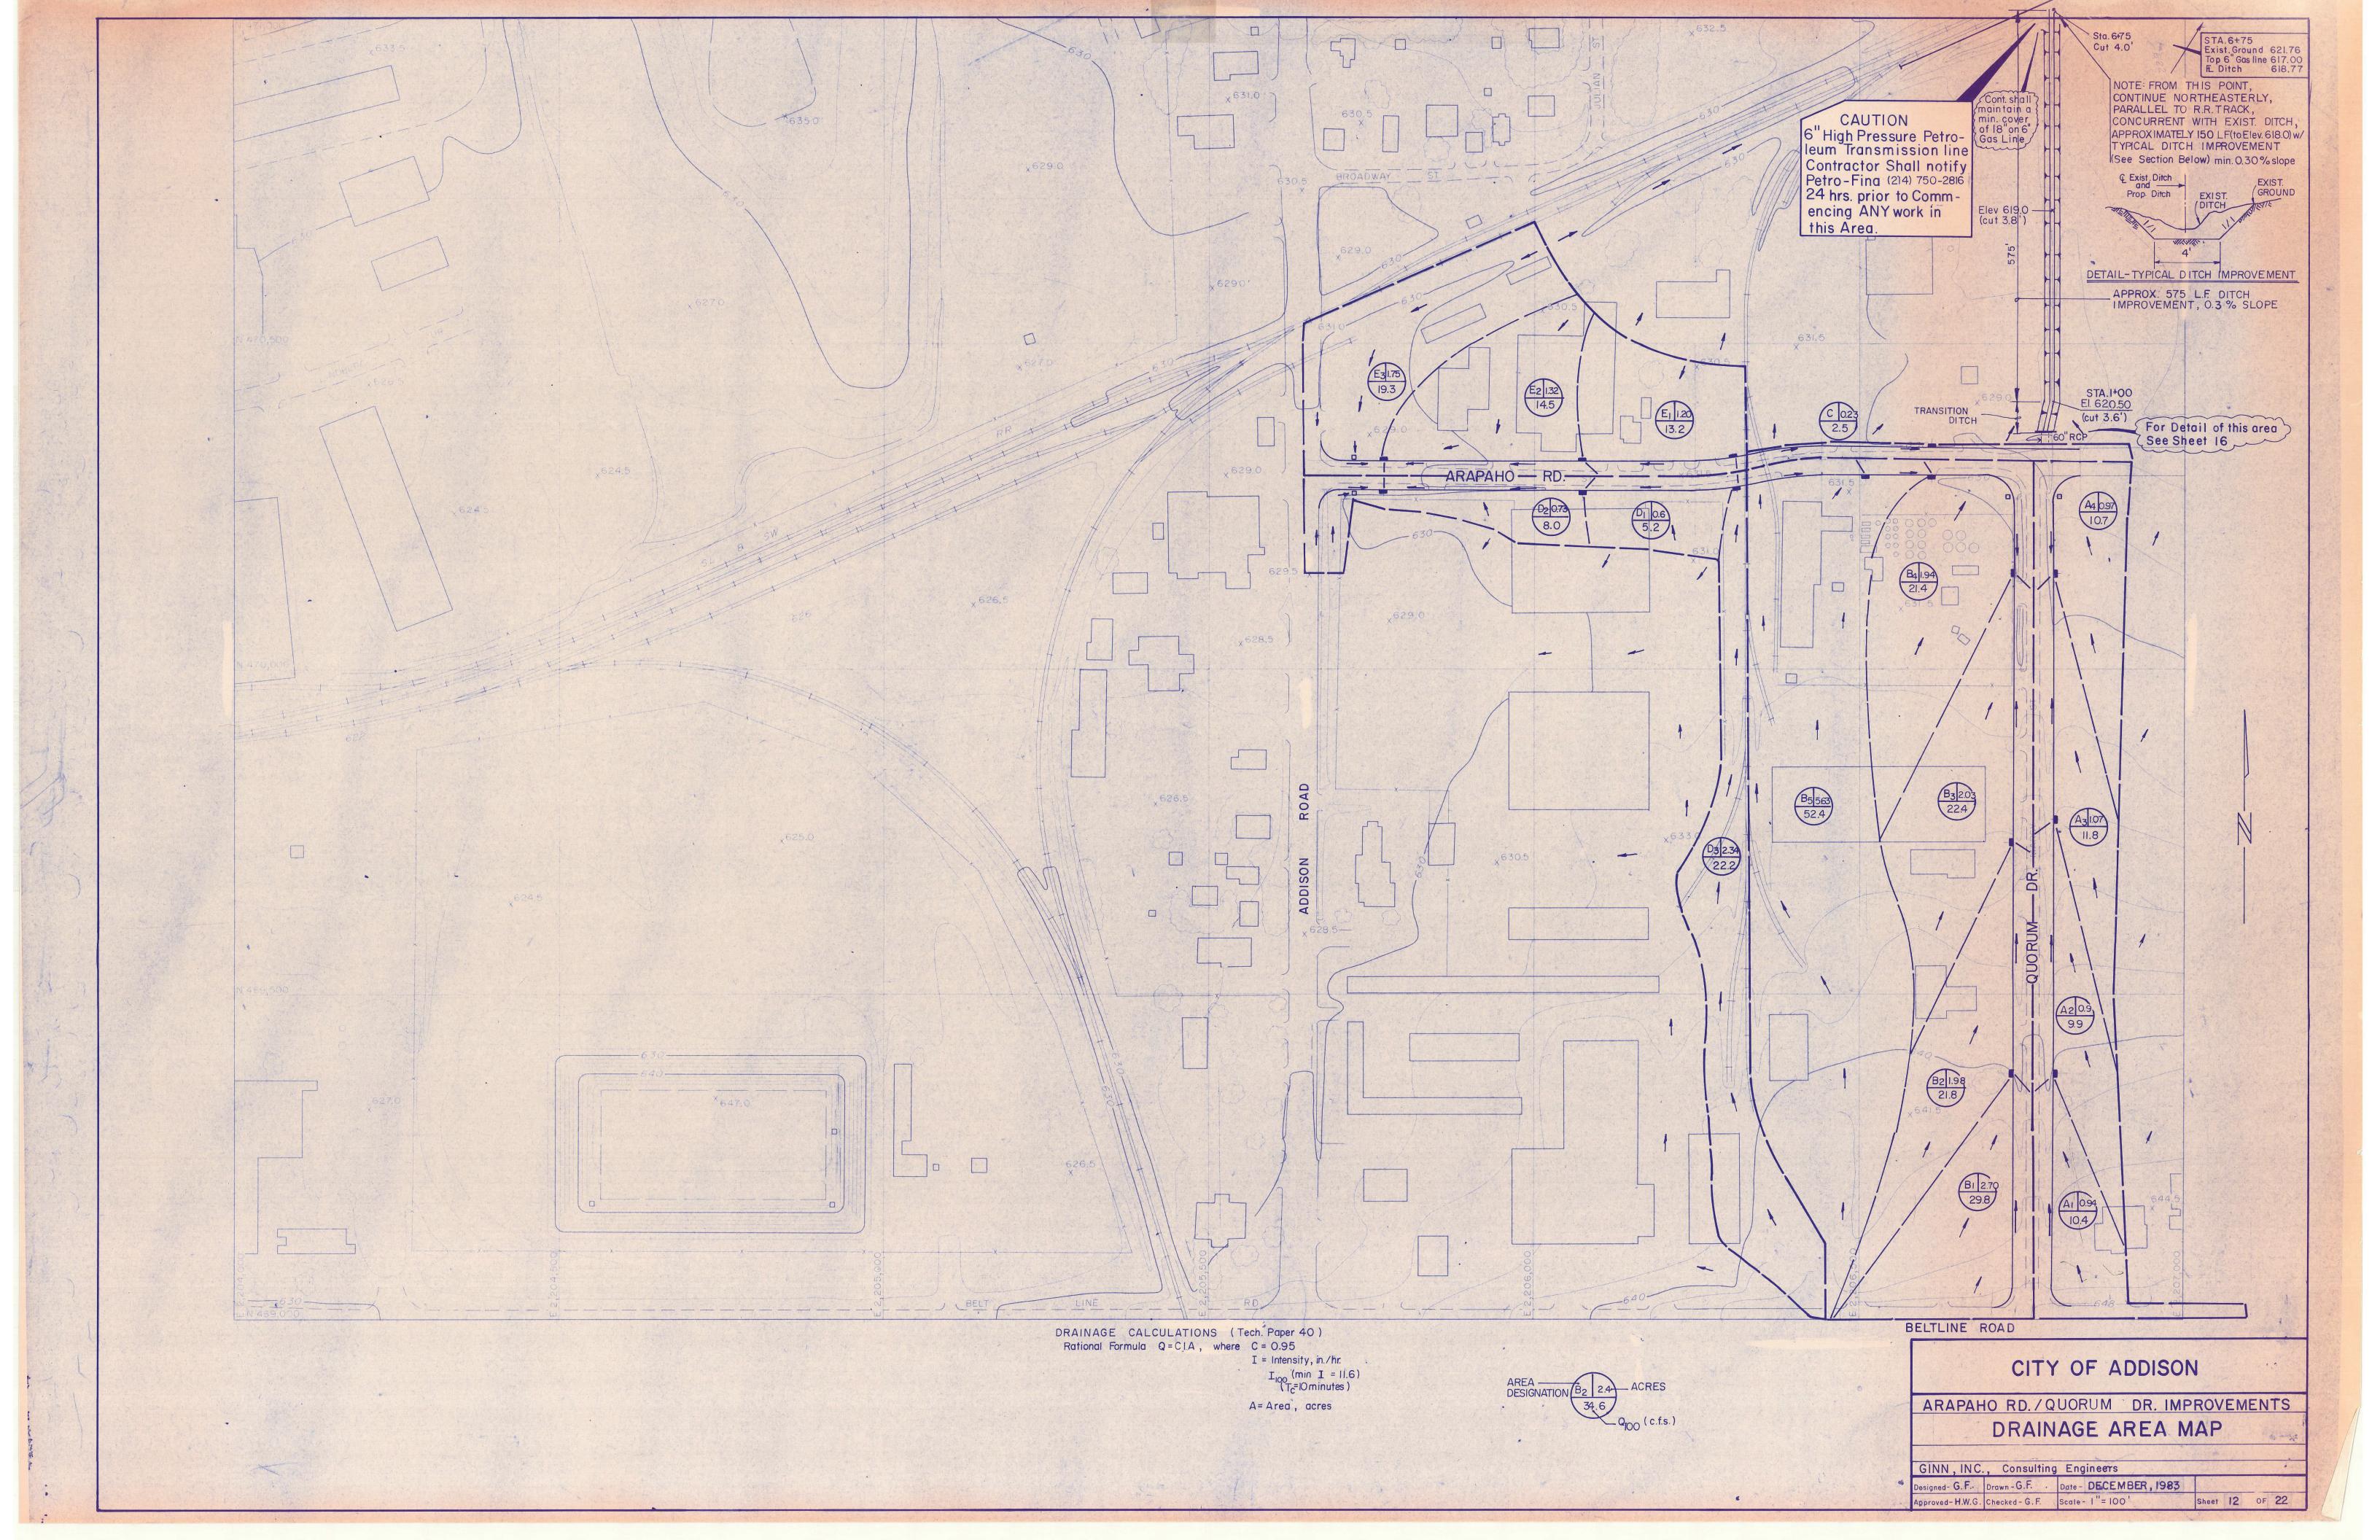



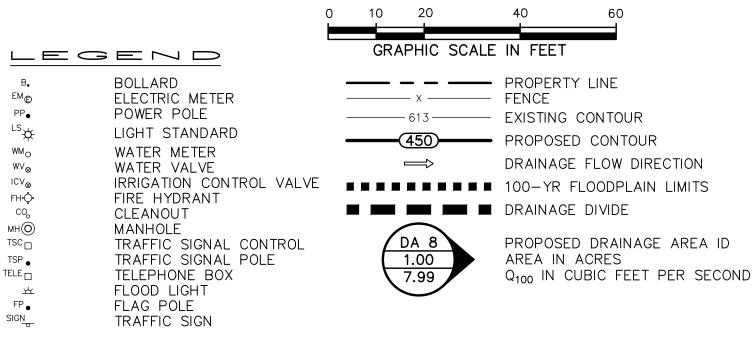

THE EXISTING DRAINAGE AREA MAP FOR THIS SITE WAS COMPLETED BY GINN, INC. CONSULTING ENGINEERS AS PART OF THE TOWN OF ADDISON-

EXISTING DRAINAGE AREA TABLE								
DRAINAGE AREA ID	AREA (acres)	O	Tc (min)	l <sub>100</sub> (in/hr)	Q <sub>100</sub> (cfs)	COMMENTS		
DA 1	0.57	0.95	10	11.6	6.28	DRAINS TO EXISTING STORM SYSTEM IN EDWIN LEWIS DRIVE		

PROPOSED DRAINAGE AREA TABLE								
DRAINAGE AREA ID	AREA (acres)	С	Tc (min)	I <sub>100</sub> (in/hr)	Q <sub>100</sub> (cfs)	COMMENTS		

#### **GRADING & DRAINAGE GENERAL NOTES**

- 1. REFER TO GEOTECHNICAL REPORT FOR REQUIREMENTS REGARDING FILL COMPACTION AND MOISTURE CONTENT.
- 2. UNLESS NOTED, ALL FILL IS TO BE COMPACTED TO A MINIMUM OF 95% STANDARD PROCTOR DENSITY WITHIN 3% OF OPTIMUM MOISTURE CONTENT. FILL TO BE PLACED IN MAXIMUM LIFTS OF 6 INCHES.
- 3. SIDEWALKS AND ACCESSIBLE ROUTES SHALL HAVE A RUNNING SLOPE NO GREATER THAN 5% (UNLESS OTHERWISE NOTED) AND A CROSS SLOPE NO
- GREATER THAN 2%. 4. GRADING OF ALL HANDICAPPED SPACES AND ROUTES TO CONFORM TO FEDERAL, STATE, AND LOCAL GUIDELINES.
- 5. ALL PROPOSED AND EXISTING GRADES IN NON-PAVED AREAS ARE "FINISHED GRADE" (i.e. IN LANDSCAPE BEDS, TOP OF MULCH/BEDDING MATERIAL).
- 6. UNLESS NOTED, STORM DRAIN LINES SHALL BE OF THE FOLLOWING MATERIALS AND INSTALLED IN ACCORDANCE WITH MANUFACTURER'S SPECIFICATIONS:
  - 6.A. RCP C-76, CLASS III 6.B. ADS N-12

ARAPAHO ROAD/QUORUM DRIVE IMPROVEMENTS PACKAGE DATED

DECEMBER 1983

- 6.C. HANCOR HI-Q
- 6.D. CONTECH ALUMINIZED ULTRA FLOW
- 7. UNLESS NOTED, GRATE INLETS TO BE "FORTERRA PIPE AND PRECAST" CATCH BASIN SIZED AS SHOWN, OR APPROVED EQUAL. 8. FINAL PAVING, CURB, AND SIDEWALK ELEVATIONS WILL BE PLACED AT PLUS OR MINUS 0.03 FOOT.
- 9. REFER TO LANDSCAPE SPECIFICATIONS FOR SEEDING AND SODDING REQUIREMENTS.
- 10. ANY CONCRETE, ROCK, OR MATERIAL DEEMED BY THE ENGINEER TO BE UNSUITABLE FOR SUBGRADE SHALL BE DISPOSED OF OFFSITE AT CONTRACTOR'S
- EXPENSE. 11. TRENCH BACKFILL MATERIAL SHALL CONFORM TO THE REQUIREMENTS OF NCTCOG ITEM 504.2 AND SHALL BE MECHANICALLY COMPACTED IN 6-INCH LIFTS TO THE TOP OF SUBGRADE TO A MINIMUM OF 95% STANDARD PROCTOR DENSITY IN ACCORDANCE WITH NCTCOG ITEM 504.5 UNLESS OTHERWISE SHOWN
- ON THESE PLANS OR STATED IN THE STANDARD TOWN SPECIFICATIONS. 12. EMBEDMENT SHALL CONFORM TO THE REQUIREMENTS OF NCTCOG ITEM 504.5 UNLESS OTHERWISE SHOWN ON THESE PLANS OR STATED IN THE STANDARD CITY SPECIFICATIONS.
- 13. A ROUND MANHOLE COVER MEETING CITY SPECIFICATIONS SHALL BE PLACED IN ALL INLET TOPS NEAR THE OUTLET PIPE.

**PRELIMINARY** 

NOT FOR CONSTRUCTION THIS DOCUMENT IS ISSUED FOR THE

PURPOSE OF SCHEMATIC REVIEW ONLY

AND IS NOT INTENDED FOR PERMITTING,

BIDDING, OR CONSTRUCTION PURPOSES.


PLANS PREPARED UNDER THE DIRECT

SUPERVISION OF EMILY M. ZOELLNER, P.E TEXAS REGISTRATION NO. 123461

DATE: 10/06/2020

- 14. ALL CONCRETE FOR INLETS AND DRAINAGE STRUCTURES SHALL CONFORM TO NCTCOG ITEM 702.2.4, CLASS "A" (3000 PSI) UNLESS OTHERWISE SHOWN ON THESE PLANS OR STATED IN STANDARD TOWN SPECIFICATIONS.
- 15. CRUSHED STONE BEDDING OR APPROVED EQUAL SHALL BE PROVIDED BY THE CONTRACTOR WHEN ROCK IS ENCOUNTERED IN TRENCHES. THERE SHALL BE NO ADDITIONAL PAY ITEM FOR CRUSHED STONE BEDDING.
- 16. IF REQUIRED DUE TO CONSTRUCTION, POWER POLES TO BE BRACED OR RELOCATED AT CONTRACTOR'S EXPENSE.

ISSUED FOR PRELIMINARY PRICING PURPOSES ONLY (SUBJECT TO REVISION PRIOR TO CONSTRUCTION) THESE DOCUMENTS HAVE BEEN PREPARED BY THE ENGINEER WITH THE INTENT OF COMPLYING WITH ALL CITY STANDARD REQUIREMENTS. THESE DOCUMENTS HAVE NOT BEEN APPROVED AND RELEASED FOR CONSTRUCTION BY THE CITY AS OF THIS DATE AND, THEREFORE, REVISIONS MAY BE REQUIRED PRIOR TO CONSTRUCTION.

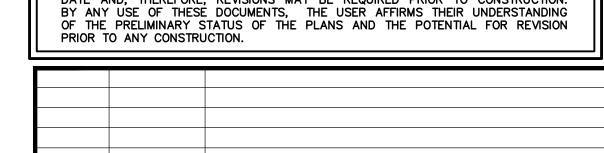


DATE REVISION

7557 RAMBLER ROAD SUITE 1400 Pacheco Koch DALLAS, TX 75231 972.235.3031 TX REG. ENGINEERING FIRM F-469 TX REG. SURVEYING FIRM LS-10008000

# PRELIMINARY DRAINAGE PLAN

**BAUMANN BUILDING LOT 1, BLOCK A** 4901 ARAPAHO RD.


TOWN OF ADDISON, DALLAS COUNTY, TEXAS SCALE NOTES DATE FILE NO. DESIGN DRAWN OCT 2020 C1.1 **EMZ** GAC

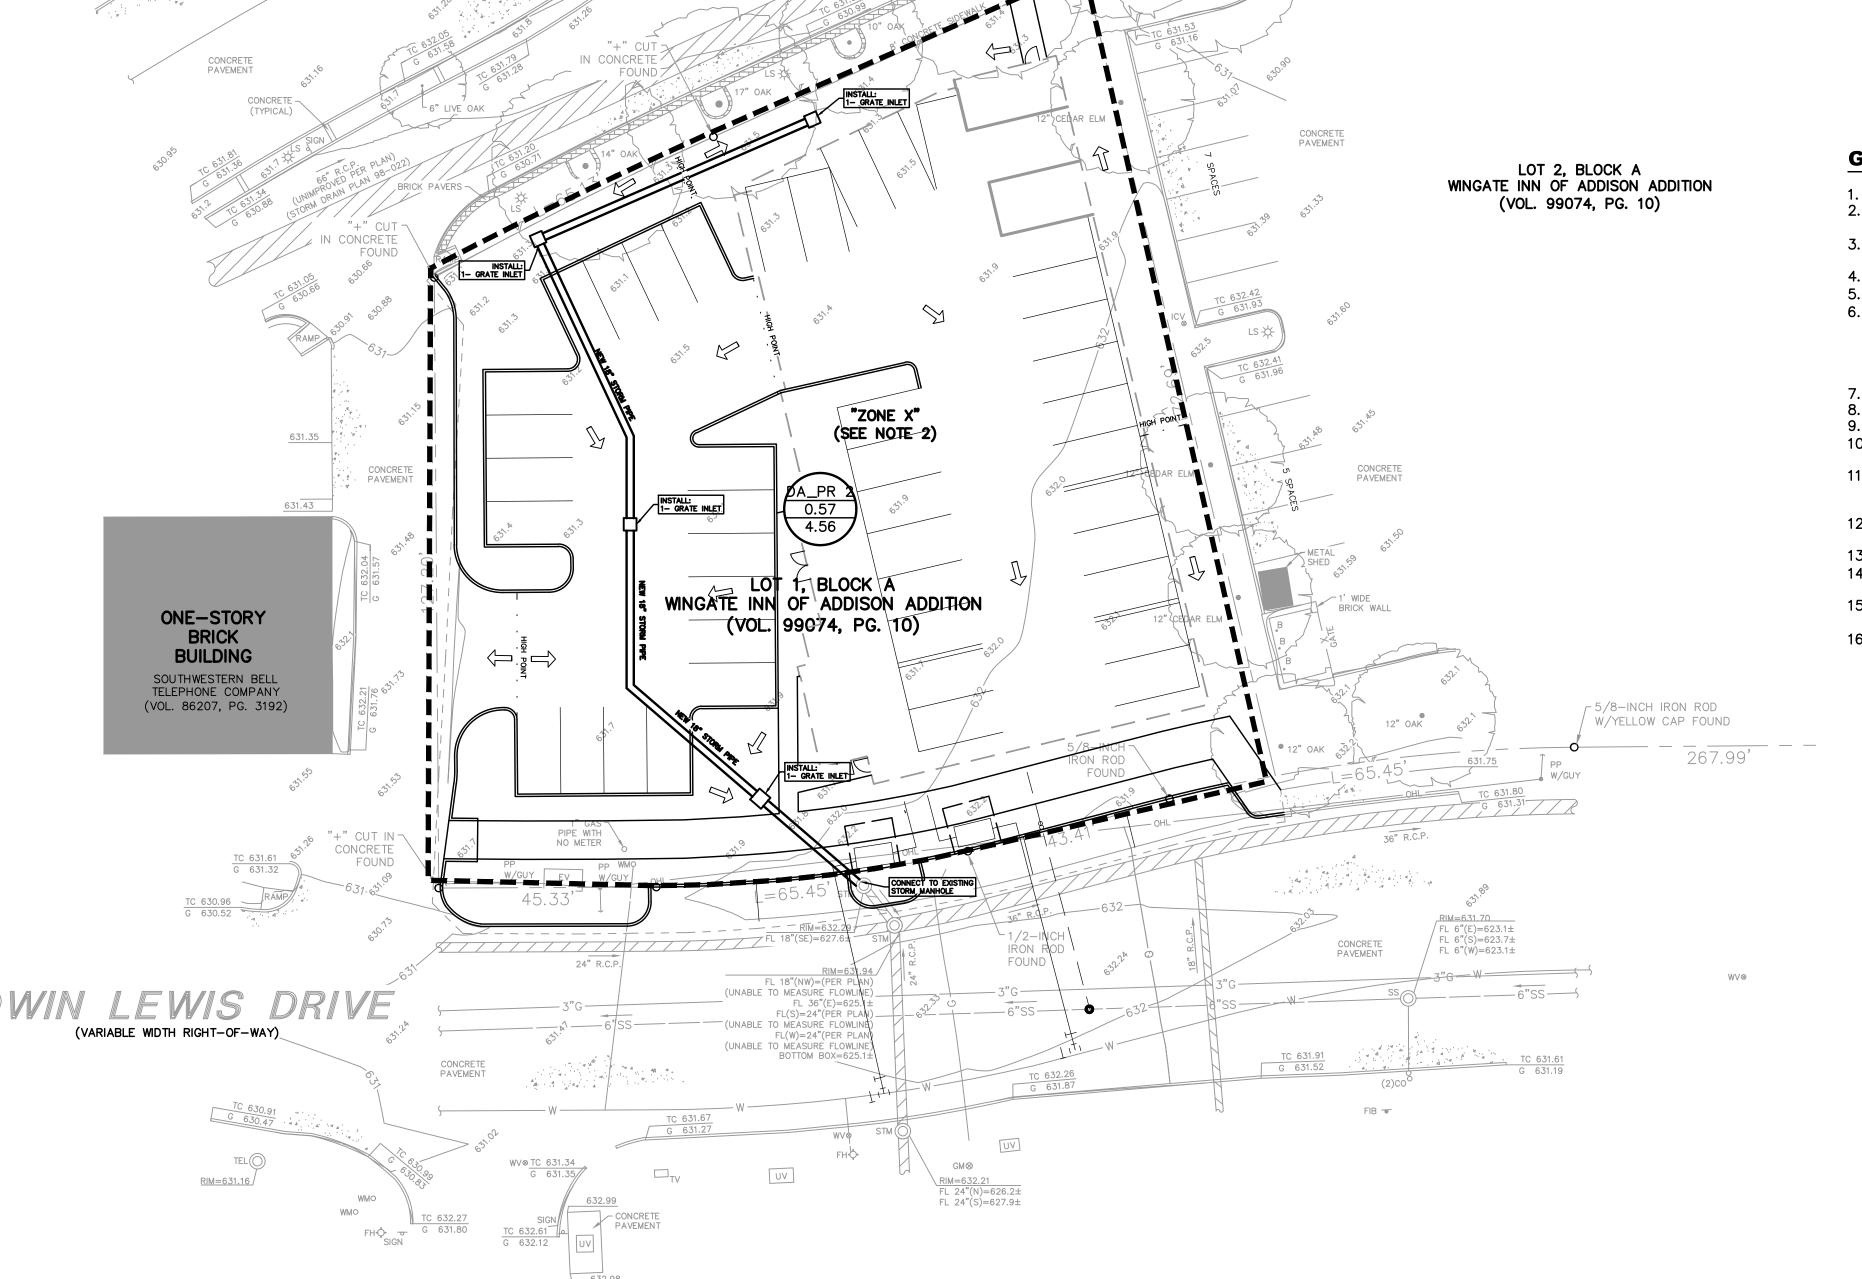

RIM=631.95

FIB TEL



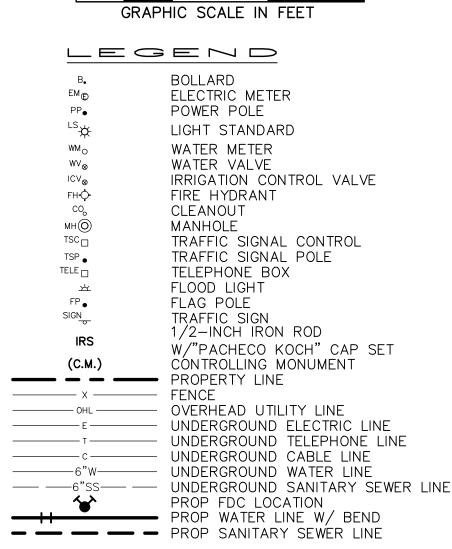

FIRE HYDRANT CIRCLE

150' RADIUS

#### **WATER & SANITARY SEWER GENERAL NOTES**

- ALL CONCRETE SHALL BE CLASS "A" (3000 PSI), UNLESS OTHERWISE NOTED. 2. ALL WATER MAINS SHALL BE PVC C900, DR 18, CLASS 235. FIRE PROTECTION SERVICES SHALL BE PVC C900, DR 14, CLASS 305 AND INSTALLED IN ACCORDANCE WITH THE DESIGN AND SPECIFICATIONS OF THE FIRE PROTECTION PLANS TO BE PREPARED BY A LICENSED FIRE PROTECTION CONTRACTOR.
- WATER AND SANITARY SEWER SERVICES SHALL MEET PLUMBING CODE REQUIREMENTS
- 4. ALL WATER MAINS SHALL HAVE A MINIMUM COVER OF 48 INCHES BELOW IMPROVED FINISHED GRADE, UNLESS OTHERWISE NOTED.
- SANITARY SEWER PIPE SHALL BE PVC SDR-35.

FINISHED GRADE.

CONTRACTOR'S EXPENSE.

- WHEN WATER AND SANITARY SEWER MAINS, SERVICES, AND LATERALS ARE INSTALLED, THEY SHALL BE INSTALLED NO CLOSER TO EACH OTHER THAN NINE FEET IN ALL DIRECTIONS AND PARALLEL LINES MUST BE INSTALLED IN SEPARATE TRENCHES. WHERE THE NINE FOOT SEPARATION DISTANCE CANNOT BE ACHIEVED, THE FOLLOWING TCEQ CHAPTERS SHALL APPLY:
- 6.A. TCEQ CHAPTER 217.53 PIPE DESIGN, SECTION (d) SEPARATION DISTANCES. TCEQ CHAPTER 290.44 WATER DISTRIBUTION, SECTION (e) LOCATION OF WATERLINES.
- CONTRACTOR TO VERIFY ALL EXISTING SEWER FLOW LINES BEFORE BEGINNING CONSTRUCTION.
- CONTRACTOR SHALL TIE A ONE INCH WIDE PIECE OF RED PLASTIC FLAGGING TO THE END OF SEWER SERVICE AND SHALL LEAVE A MINIMUM OF 36 INCHES OF FLAGGING EXPOSED AFTER BACKFILL. AFTER CURB AND PAVING IS COMPLETED, CONTRACTOR SHALL MARK THE LOCATION OF THE SEWER SERVICE ON THE CURB OR ALLEY IN ACCORDANCE WITH THE STANDARD TOWN SPECIFICATIONS.
- ALL SANITARY SEWER LINES SHALL BE TESTED IN ACCORDANCE WITH THE STANDARD TOWN SPECIFICATIONS.
- 10. THE UTILITY CONTRACTOR SHALL INSTALL THE WATER SERVICES TO A POINT TWO FEET BACK OF THE CURB LINE AT A DEPTH OF 12 INCHES. THE METER BOX SHALL BE FURNISHED AND INSTALLED BY THE CONTRACTOR AFTER THE PAVING CONTRACTOR HAS COMPLETED THE FINE GRADING BEHIND THE BACK OF THE CURB. EACH SERVICE LOCATION SHALL BE MARKED ON THE CURB WITH A BLUE LETTER "W" BY THE UTILITY
- CONTRACTOR AND TIED TO PROPERTY CORNERS ON THE "RECORD DRAWINGS." 11. ALL METER BOXES SHALL BE LOCATED IN NON-TRAFFIC AREAS.
- 12. TRENCH BACKFILL MATERIAL SHALL CONFORM TO THE REQUIREMENTS OF NCTCOG ITEM 504.2 AND SHALL BE MECHANICALLY COMPACTED IN 6-INCH LIFTS TO THE TOP OF SUBGRADE TO A MINIMUM OF 95% STANDARD PROCTOR DENSITY IN ACCORDANCE WITH NCTCOG ITEM 504.5 UNLESS OTHERWISE SHOWN ON THESE PLANS OR STATED IN THE
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- 14. VALVE BOXES SHALL BE FURNISHED AND SET ON EACH GATE VALVE. AFTER THE FINAL CLEAN-UP AND ALIGNMENT HAS BEEN COMPLETED, THE UTILITY CONTRACTOR SHALL POUR A 24"X24"X6" CONCRETE BLOCK AROUND ALL VALVE BOX TOPS LEVEL WITH THE
- 15. CONTRACTOR SHALL RECONNECT ALL EXISTING SERVICES AND MAINTAIN EXISTING SERVICES THROUGHOUT CONSTRUCTION.
- 16. IF REQUIRED DUE TO CONSTRUCTION, POWER POLES TO BE BRACED OR RELOCATED AT

THIS PLAN CONFORMS WITH DESIGN STANDARDS INCLUDED IN THE TOWN OF ADDISON TRANSPORTATION PLAN, WATER SYSTEMS REQUIREMENTS, WASTE WATER SYSTEM REQUIREMENTS, AND DRAINAGE CRITERIA MANUAL

#### **TOWN PROJECT NO. 1809-Z**


#### **PRELIMINARY**

**NOT FOR CONSTRUCTION** THIS DOCUMENT IS ISSUED FOR THE PURPOSE OF SCHEMATIC REVIEW ONLY AND IS NOT INTENDED FOR PERMITTING, BIDDING, OR CONSTRUCTION PURPOSES.

PLANS PREPARED UNDER THE DIRECT SUPERVISION OF EMILY M. ZOELLNER, P.E. TEXAS REGISTRATION NO. 123461 DATE: 10/06/2020

ISSUED FOR PRELIMINARY PRICING PURPOSES ONLY (SUBJECT TO REVISION PRIOR TO CONSTRUCTION)

THESE DOCUMENTS HAVE BEEN PREPARED BY THE ENGINEER WITH THE INTENT OF COMPLYING WITH ALL CITY STANDARD REQUIREMENTS. THESE DOCUMENTS HAVE NOT BEEN APPROVED AND RELEASED FOR CONSTRUCTION BY THE CITY AS OF THIS DATE AND, THEREFORE, REVISIONS MAY BE REQUIRED PRIOR TO CONSTRUCTION. BY ANY USE OF THESE DOCUMENTS, THE USER AFFIRMS THEIR UNDERSTANDING OF THE PRELIMINARY STATUS OF THE PLANS AND THE POTENTIAL FOR REVISION PRIOR TO ANY CONSTRUCTION.

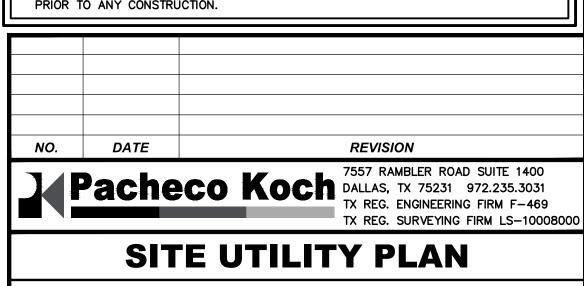

**BAUMANN BUILDING LOT 1, BLOCK A** 4901 ARAPAHO RD.

TOWN OF ADDISON, DALLAS COUNTY, TEXAS								
DESIGN	DRAWN	DATE	SCALE	NOTES	FILE	NO.		
EMZ	GAC	OCT 2020	1"=20'			C1.2		

PK FILE: 2960-19.596 PK-2960-19.596\_UTIL.DWG

FIB TEL

"+" CUT 7 IN CONCRETE FOUND

CONCRETE PAVEMENT

**ONE-STORY** 

BRICK

BUILDING

SOUTHWESTERN BELL

TELEPHONE COMPANY

(VOL. 86207, PG. 3192)/

WIN LEWIS DRIVE

TEL(()

EXISTING FIRE

HYDRANT

(VARIABLE WIDTH RIGHT-OF-WAY)

(TYPICAL)

IN CONCRETE

CONCRETE PAVEMENT

"+" CUT IN \
CONCRETE
FOUND

NEW IRRIGATION METER TO BE INSTALLED

AT EXISTING WATER SERVICE ON

CONCRETE PAVEMENT

(TYPICAL)

"ZQNE X"

(SEE NOTE 2)

WINGATE INN OF ADDISON ADDITION

(VOL. 99074, PG. 10)

=65.45

FL 18"(NW)=(PER (UNABLE TO MEASURE FLO

(UNABLE TO MEASURE FLOWL) BOTTOM BOX=625

NEW FIRE

UV

EXISTING FIRE

**HYDRANT** 

SERVICE

FL(S)=24"(PFR(UNABLE TO MEASURE FLOWL

END & CAP WATER SERVICE 5'

FROM BUILDING FACE. REFER

COORDINATION

PIPE WITH NO METER

45.33

**PROPERTY** 

W∨⊗

TO MEP FOR CONTINUATION &

EXISTING FIRE

LOT 2, BLOCK A

WINGATE INN OF ADDISON ADDITION

(VOL. 99074, PG. 10)

\_5/8-INCH IRON ROD

W/YELLOW CAP FOUND

267.99

WV⊗

HYDRANT

END & CAP WASTEWATER LATERAL

-1-DOUBLE CLEANOUT AT PROPERTY LINE

5' FROM BUILDING FACE. REFER

TO MEP FOR CONTINUATION &

5 LF WASTEWATER LATERAL

NEW 6" WASTERWATER LATERAL

1-WASTEWATER MANHOLE

CONNECT TO

EXISTING 8" WATER

COORDINATION

5/8<del>-INCH</del> TRON ROD


FOUND

NEW DOM. SERVICE-

CONNECT TO

FL 24"(S)=627.9±

(EXISTING 8" WATER

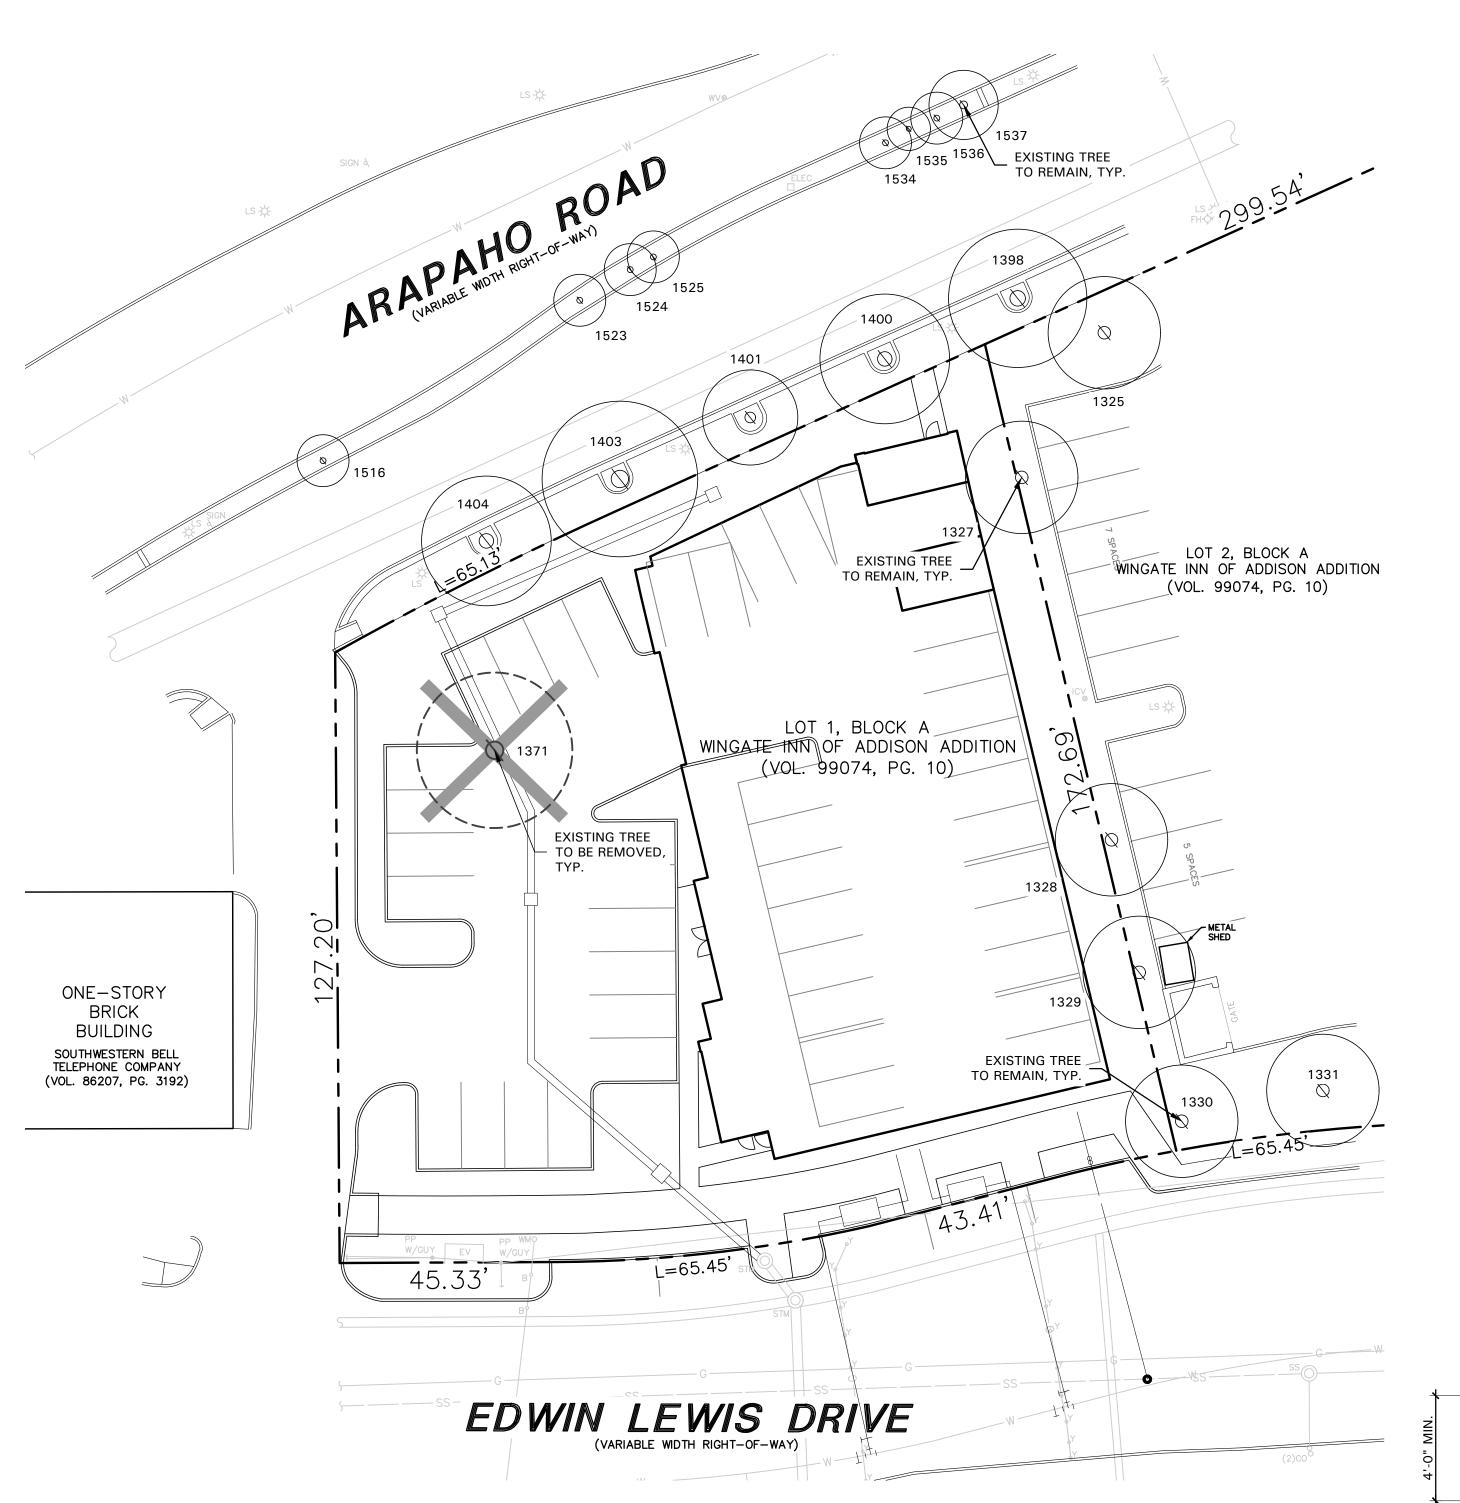

TREE SURVEY FIELD DATA				
No.	Dia.	Species	Status	Remarks
	(inches)	(common name)		
1325	12	OAK	TO REMAIN	OUTSIDE OF PROPERTY
1327	12	CEDAR ELM	TO REMAIN	OUTSIDE OF PROPERTY
1328	12	CEDAR ELM	TO REMAIN	OUTSIDE OF PROPERTY
1329	12	CEDAR ELM	TO REMAIN	OUTSIDE OF PROPERTY
1330	12	OAK	TO REMAIN	OUTSIDE OF PROPERTY
1331	12	OAK	TO REMAIN	OUTSIDE OF PROPERTY
1371	17	OAK	TO BE REMOVED	
1398	15	OAK	TO REMAIN	OUTSIDE OF PROPERTY
1400	14	OAK	TO REMAIN	OUTSIDE OF PROPERTY
1401	10	OAK	TO REMAIN	OUTSIDE OF PROPERTY
1403	17	OAK	TO REMAIN	OUTSIDE OF PROPERTY
1404	14	OAK	TO REMAIN	OUTSIDE OF PROPERTY
1516	6	LIVE OAK	TO REMAIN	OUTSIDE OF PROPERTY
1523	6	LIVE OAK	TO REMAIN	OUTSIDE OF PROPERTY
1524	6	LIVE OAK	TO REMAIN	OUTSIDE OF PROPERTY
1525	6	LIVE OAK	TO REMAIN	OUTSIDE OF PROPERTY
1534	6	LIVE OAK	TO REMAIN	OUTSIDE OF PROPERTY
1535	5	LIVE OAK	TO REMAIN	OUTSIDE OF PROPERTY
1536	6	LIVE OAK	TO REMAIN	OUTSIDE OF PROPERTY
1537	8	LIVE OAK	TO REMAIN	OUTSIDE OF PROPERTY

Total Caliper Inches on Site
Total Caliper Inches Removed
Total Mitigation Inches Required

#### TREE PRESERVATION NOTES

- 1. EXISTING TREES TO REMAIN SHALL BE PROTECTED DURING CONSTRUCTION FROM TREE STRUCTURE DAMAGE AND COMPACTION OF SOIL UNDER AND AROUND DRIP LINE (CANOPY) OF TREE.
- 2. IF ANY ROOT STRUCTURE IS DAMAGED DURING ADJACENT EXCAVATION / CONSTRUCTION, NOTIFY OWNER'S AUTHORIZED REPRESENTATIVE IMMEDIATELY. IT IS RECOMMENDED THAT A LICENSED ARBORIST BE SECURED FOR THE TREATMENT OF ANY POSSIBLE TREE WOUNDS.
- 3. NO DISTURBANCE OF THE SOIL GREATER THAN 4" SHALL BE LOCATED CLOSER TO THE TREE TRUNK THAN 1/2 THE DISTANCE OF THE DRIP LINE TO THE TREE TRUNK. A MINIMUM OF 75% OF THE DRIP LINE AND ROOT ZONE SHALL BE PRESERVED AT NATURAL GRADE.
- 4. ANY FINE GRADING DONE WITHIN THE CRITICAL ROOT ZONES OF THE PROTECTED TREES MUST BE DONE WITH LIGHT MACHINERY SUCH AS A BOBCAT OR LIGHT TRACTOR. NO EARTH MOVING EQUIPMENT WITH TRACKS IS ALLOWED WITHIN THE CRITICAL ROOT ZONE OF THE TREES.
- 5. NO MATERIALS INTENDED FOR USE IN CONSTRUCTION OR WASTE MATERIALS ACCUMULATED DUE TO EXCAVATION OR DEMOLITION SHALL BE PLACED WITHIN THE LIMITS OF THE DRIP LINE OF ANY TREE.
- 6. NO EQUIPMENT MAY BE CLEANED OR TOXIC SOLUTIONS, OR OTHER LIQUID CHEMICALS, SHALL BE DEPOSITED WITHIN THE LIMITS OF THE DRIP LINE OF A TREE, INCLUDING BUT NOT LIMITED TO: PAINT, OIL, SOLVENTS, ASPHALT, CONCRETE, MORTAR, PRIMERS, ETC.
- NO SIGNS, WIRES OR OTHER ATTACHMENTS, OTHER THAN THOSE OF A PROTECTIVE NATURE, SHALL BE ATTACHED TO ANY TREE.
- 8. NO VEHICULAR / CONSTRUCTION EQUIPMENT TRAFFIC OR PARKING IS ALLOWED WITHIN THE LIMITS OF THE DRIP LINE OF TREES.
- 9. BORING OF UTILITIES MAY BE PERMITTED UNDER PROTECTED TREES IN CERTAIN CIRCUMSTANCES. THE MINIMUM LENGTH OF THE BORE SHALL BE THE WIDTH OF THE TREE'S CANOPY AND SHALL BE A MINIMUM DEPTH OF FORTY-EIGHT (48") INCHES.
- 10. IRRIGATION TRENCHING WHICH MUST BE DONE WITHIN THE CRITICAL ROOT ZONE OF A TREE SHALL BE DUG BY HAND AND ENTER THE AREA IN A RADIAL MANNER.
- 11. ALL TREES TO BE REMOVED FROM THE SITE SHALL BE FLAGGED BY THE CONTRACTOR WITH BRIGHT RED VINYL TAPE (3" WIDTH) WRAPPED AROUND THE MAIN TRUNK AT A HEIGHT OF FOUR (4') FEET ABOVE GRADE. FLAGGING SHALL BE APPROVED BY OWNER'S AUTHORIZED REPRESENTATIVE PRIOR TO ANY TREE REMOVAL. CONTRACTOR SHALL CONTACT OWNER'S AUTHORIZED REPRESENTATIVE WITH 72 HOURS NOTICE TO SCHEDULE ON-SITE MEETING.
- 12. ALL TREES TO REMAIN, AS NOTED ON DRAWINGS, SHALL HAVE PROTECTIVE FENCING LOCATED AT THE TREE'S DRIP LINE. THE PROTECTIVE FENCING MAY BE COMPRISED OF SNOW FENCING, ORANGE VINYL CONSTRUCTION FENCING, CHAIN LINK FENCE OR OTHER SIMILAR FENCING WITH A FOUR (4') FOOT APPROXIMATE HEIGHT. THE PROTECTIVE FENCING SHALL BE LOCATED AS INDICATED ON THE TREE PROTECTION DETAIL.
- 13. WHEN A LOW HANGING LIMB IS BROKEN DURING THE COURSE OF CONSTRUCTION, THE CONTRACTOR SHALL NOTIFY THE OWNER'S AUTHORIZED REPRESENTATIVE IMMEDIATELY. UNDER NO CIRCUMSTANCE SHALL THE CONTRACTOR PRUNE ANY PORTION OF THE DAMAGED TREE WITHOUT THE PRIOR APPROVAL BY THE OWNER'S AUTHORIZED REPRESENTATIVE.

REFER TO PLAN FOR EXISTING TREE TO REMAIN

SNOW FENCE, ORANGE VINYL

- CONSTRUCTION FENCE, OR
CHAINLINK FENCE

METAL T-POST PLACED NO FURTHER THAN 8' APART

EXISTING GRADE TO REMAIN UNDISTURBED

1 TREE PROTECTIVE FENCING NOT TO SCALE

LIMITS OF DRIPLINE

Owner:
JR Baumann Holdings LLC
4801 Arapaho Road

4801 Arapaho Road Suite 100 Addison, Texas 75001 Architect/Applicant:
Greenlight Studio LLC
100 N. Cottonwood Drive
Suite 104
Richardson, Texas 75080

214.810.4535

Civil Engineer:
Pacheco Koch
7557 Rambler Road
Suite 1400
Dallas, Texas 75231

972.235.3031





4245 North Central Expy Suite 501

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Dallas, Texas 75205 214.865.7192 office



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# Baumann Building 4901 Arapaho Road

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Lot 1, Block A
Wingate Inn of Addison Addition
Addison, Texas
Town Project No. 1809-Z

Project Number:

19147
Issue Date:
01.24.2020
Drawn By:
NAY
Checked By:

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Revisions

03.27.20 Town Comments

19.20 Town Comments

Sheet Title:


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TREE PRESERVATION PLAN

Sheet Number:

L1.01



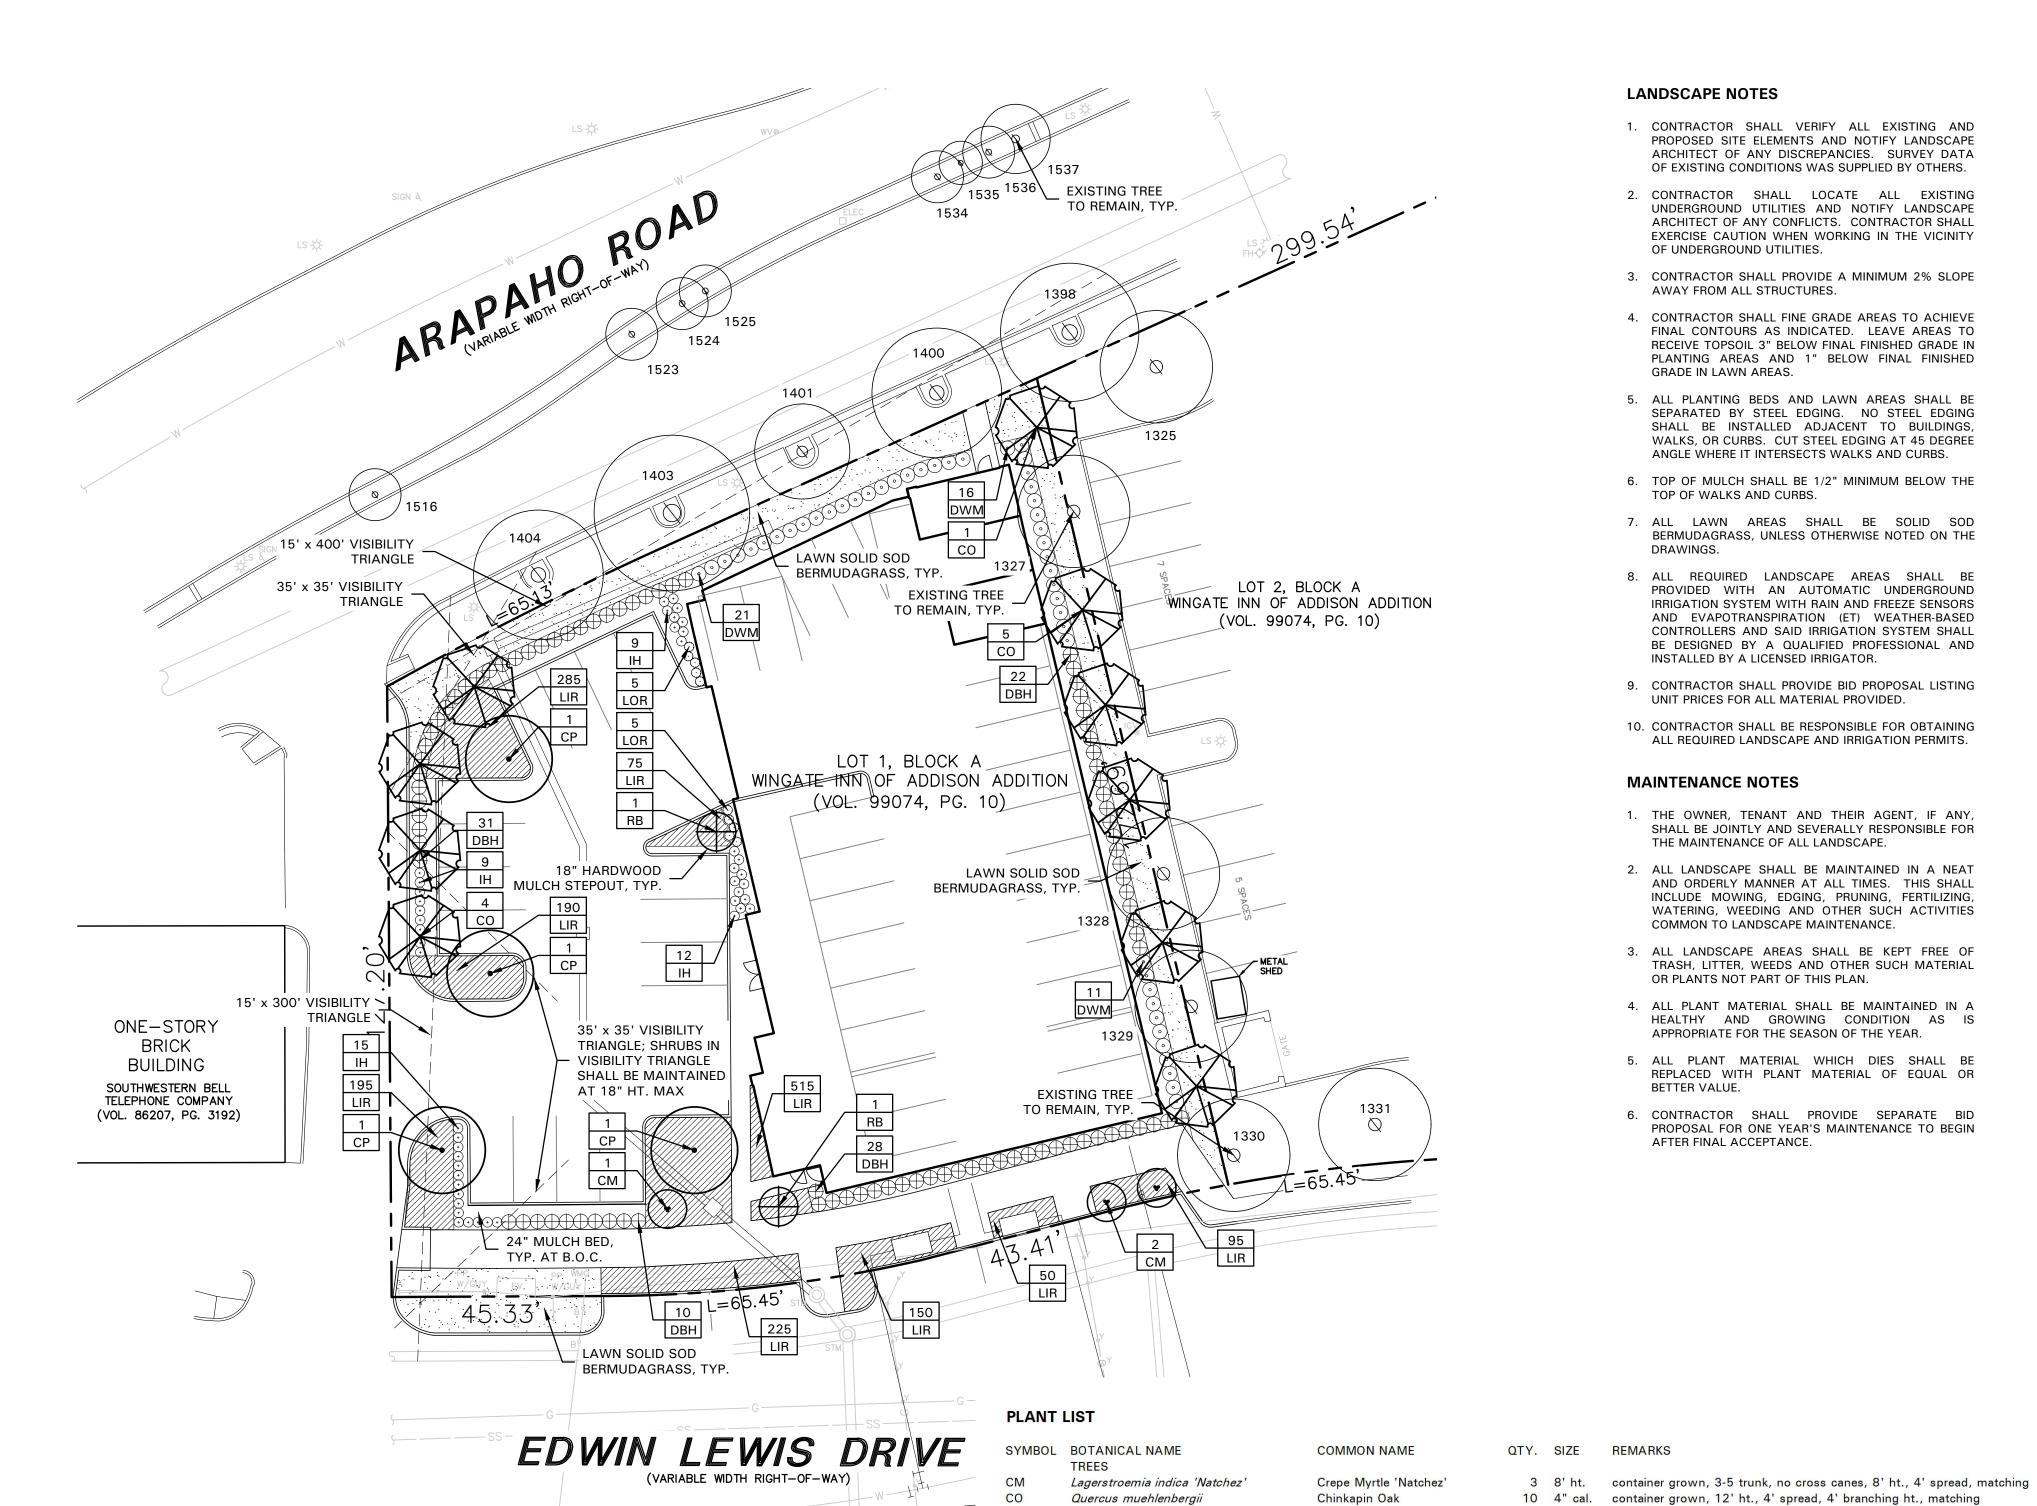

#### LANDSCAPE NOTES

- 1. CONTRACTOR SHALL VERIFY ALL EXISTING AND PROPOSED SITE ELEMENTS AND NOTIFY LANDSCAPE ARCHITECT OF ANY DISCREPANCIES. SURVEY DATA OF EXISTING CONDITIONS WAS SUPPLIED BY OTHERS.
- 2. CONTRACTOR SHALL LOCATE ALL EXISTING UNDERGROUND UTILITIES AND NOTIFY LANDSCAPE ARCHITECT OF ANY CONFLICTS. CONTRACTOR SHALL EXERCISE CAUTION WHEN WORKING IN THE VICINITY OF UNDERGROUND UTILITIES.
- 3. CONTRACTOR SHALL PROVIDE A MINIMUM 2% SLOPE AWAY FROM ALL STRUCTURES.
- 4. CONTRACTOR SHALL FINE GRADE AREAS TO ACHIEVE FINAL CONTOURS AS INDICATED. LEAVE AREAS TO RECEIVE TOPSOIL 3" BELOW FINAL FINISHED GRADE IN PLANTING AREAS AND 1" BELOW FINAL FINISHED GRADE IN LAWN AREAS.
- 5. ALL PLANTING BEDS AND LAWN AREAS SHALL BE SEPARATED BY STEEL EDGING. NO STEEL EDGING SHALL BE INSTALLED ADJACENT TO BUILDINGS, WALKS, OR CURBS. CUT STEEL EDGING AT 45 DEGREE ANGLE WHERE IT INTERSECTS WALKS AND CURBS.
- 6. TOP OF MULCH SHALL BE 1/2" MINIMUM BELOW THE TOP OF WALKS AND CURBS.
- 7. ALL LAWN AREAS SHALL BE SOLID SOD BERMUDAGRASS, UNLESS OTHERWISE NOTED ON THE DRAWINGS.
- 8. ALL REQUIRED LANDSCAPE AREAS SHALL BE PROVIDED WITH AN AUTOMATIC UNDERGROUND IRRIGATION SYSTEM WITH RAIN AND FREEZE SENSORS AND EVAPOTRANSPIRATION (ET) WEATHER-BASED CONTROLLERS AND SAID IRRIGATION SYSTEM SHALL BE DESIGNED BY A QUALIFIED PROFESSIONAL AND INSTALLED BY A LICENSED IRRIGATOR.
- 9. CONTRACTOR SHALL PROVIDE BID PROPOSAL LISTING UNIT PRICES FOR ALL MATERIAL PROVIDED.
- 10. CONTRACTOR SHALL BE RESPONSIBLE FOR OBTAINING ALL REQUIRED LANDSCAPE AND IRRIGATION PERMITS.

#### MAINTENANCE NOTES

- 1. THE OWNER, TENANT AND THEIR AGENT, IF ANY, SHALL BE JOINTLY AND SEVERALLY RESPONSIBLE FOR THE MAINTENANCE OF ALL LANDSCAPE.
- 2. ALL LANDSCAPE SHALL BE MAINTAINED IN A NEAT AND ORDERLY MANNER AT ALL TIMES. THIS SHALL INCLUDE MOWING, EDGING, PRUNING, FERTILIZING, WATERING, WEEDING AND OTHER SUCH ACTIVITIES COMMON TO LANDSCAPE MAINTENANCE.
- 3. ALL LANDSCAPE AREAS SHALL BE KEPT FREE OF TRASH, LITTER, WEEDS AND OTHER SUCH MATERIAL OR PLANTS NOT PART OF THIS PLAN.
- 4. ALL PLANT MATERIAL SHALL BE MAINTAINED IN A HEALTHY AND GROWING CONDITION AS IS APPROPRIATE FOR THE SEASON OF THE YEAR.
- 5. ALL PLANT MATERIAL WHICH DIES SHALL BE REPLACED WITH PLANT MATERIAL OF EQUAL OR BETTER VALUE.
- 6. CONTRACTOR SHALL PROVIDE SEPARATE BID PROPOSAL FOR ONE YEAR'S MAINTENANCE TO BEGIN AFTER FINAL ACCEPTANCE.

4 4" cal. container grown, 12' ht., 4' spread, 4' branching ht., matching

2 3" cal. container grown, 8' ht., 4' spread min.

91 5 gal. container full, 20" spread, 36" o.c.

48 5 gal. container full, 20" spread, 36" o.c.

45 5 gal. container full, 20" spread, 24" o.c.

10 3 gal. container full, 18" spread, 24" o.c.

1780 4" pots container full top of container, 12" o.c.

solid sod, refer to Solid Sod Notes

#### **GENERAL LAWN NOTES**

- 1. CONTRACTOR SHALL COORDINATE OPERATIONS AND AVAILABILITY OF EXISTING TOPSOIL WITH ON-SITE CONSTRUCTION MANAGER.
- 2. CONTRACTOR SHALL LEAVE LAWN AREAS 1" BELOW FINAL FINISHED GRADE PRIOR TO TOPSOIL INSTALLATION.
- 3. CONTRACTOR SHALL FINE GRADE AREAS TO ACHIEVE FINAL CONTOURS AS INDICATED ON CIVIL PLANS. ADJUST CONTOURS TO ACHIEVE POSITIVE DRAINAGE AWAY FROM BUILDINGS. PROVIDE UNIFORM ROUNDING AT TOP AND BOTTOM OF SLOPES AND OTHER BREAKS IN GRADE. CORRECT IRREGULARITIES AND AREAS WHERE WATER MAY STAND.
- 4. ALL LAWN AREAS SHALL BE FINE GRADED, IRRIGATION TRENCHES COMPLETELY SETTLED AND FINISH GRADE APPROVED BY THE OWNER'S CONSTRUCTION MANAGER OR LANDSCAPE ARCHITECT PRIOR TO LAWN INSTALLATION.
- 5. CONTRACTOR SHALL REMOVE ALL ROCKS 3/4" DIAMETER AND LARGER, DIRT CLODS, STICKS, CONCRETE SPOILS, ETC. PRIOR TO PLACING TOPSOIL AND LAWN INSTALLATION.
- 6. CONTRACTOR SHALL MAINTAIN ALL LAWN AREAS UNTIL FINAL ACCEPTANCE. THIS SHALL INCLUDE, BUT NOT BE LIMITED TO: MOWING, WATERING, WEEDING, CULTIVATING, CLEANING AND REPLACING DEAD OR BARE AREAS TO KEEP PLANTS IN A VIGOROUS, HEALTHY CONDITION.
- 7. CONTRACTOR SHALL GUARANTEE ESTABLISHMENT OF ACCEPTABLE TURF AREA AND SHALL PROVIDE REPLACEMENT FROM LOCAL SUPPLY IF NECESSARY.

#### SOLID SOD NOTES

- 1. PLANT SOD BY HAND TO COVER INDICATED AREAS COMPLETELY. ENSURE EDGES OF SOD ARE TOUCHING. TOP DRESS JOINTS BY HAND WITH TOPSOIL TO FILL
- 2. ROLL GRASS AREAS TO ACHIEVE A SMOOTH, EVEN SURFACE, FREE FROM UNNATURAL UNDULATIONS.
- 3. WATER SOD THOROUGHLY AS SOD OPERATION PROGRESSES.
- 4. IF INSTALLATION OCCURS BETWEEN SEPTEMBER 1 AND MARCH 1, OVER-SEED BERMUDAGRASS SOD WITH WINTER RYEGRASS, AT A RATE OF FOUR (4) POUNDS PER ONE THOUSAND (1000) SQUARE FEET.

#### LANDSCAPE TABULATIONS

THE CITY OF ADDISON, TEXAS

SITE LANDSCAPE 1. 20% of the site to be landscape area.

Provided Required 4,946 s.f. (20%) 6,005 s.f. (24%)

Total Site Area: 24,730 s.f. (0.57 acre)

STREET LANDSCAPE BUFFER

- 1. 20' landscape buffer. 2. One (1) shade tree, 4" cal., per 30 l.f. of street
- 3. Evergreen shrubs planted 3' to 3.5' on center.

Arapaho Road: 150 l.f.

Required Provided 20' landscape buffer provided (5) trees, 4" cal. (4) existing trees

(1) tree, 4" cal. evergreen shrubs 3' o.c. evergreen shrubs 3' o.c. Edwin Lewis Drive: 177 I.f

Required Provided 20' landscape buffer provided (1) tree, 4" cal. (6) trees, 4" cal. (4) trees, 3" cal.

evergreen shrubs 3' o.c.

PARKING LOT PERIMETER

evergreen shrubs 3' o.c.

1. One (1) tree, 4" cal., per 35 l.f. of perimeter. 2. Evergreen shrubs planted 3' to 3.5' on center.

Parking Lot Perimeter: 185 l.f.

(5) shade tree, 4" cal. (5) shade tree, 4" cal. evergreen shrubs, 3' o.c evergreen shrubs, 3' o.c

PARKING LOT SCREENING

1. Evergreen shrubs, 3' ht., planted 3' on center in a single row in a bed at least 42" wide.

2. Evergreen shrubs, 3' ht., must be at least 3.5' higher

than the finished elevation of the adjacent parking lot.

evergreen shrubs, 3' ht. evergreen shrubs, 3' ht.

PARKING LOT LANDSCAPE

1. 5% of the total parking area to be landscaped. 2. One (1) large shade tree per 10 parking spaces.

Total Parking Area: 5,659 s.f. Total Parking spaces: 18

284 s.f. (5%) 1,308 s.f. (23%) (2) shade trees, 4" cal. (2) shade trees, 4" cal.

### Owner: JR Baumann Holdings LLC 4801 Arapaho Road Suite 100 Addison, Texas 75001

Chinese Pistache

Oklahoma Redbud

Dwarf Burford Holly

Dwarf Wax Myrtle

Liriope 'Big Blue'

NOTE: ALL TREES SHALL HAVE STRAIGHT TRUNKS AND BE MATCHING WITHIN VARIETIES.

Indian Hawthorne 'Clara'

Loropetalum 'Plum Delight'

PLANT LIST IS AN AID TO BIDDERS ONLY. CONTRACTOR SHALL VERIFY ALL QUANTITIES ON PLAN.

ALL HEIGHTS AND SPREADS ARE MINIMUMS. ALL PLANT MATERIAL SHALL MEET OR EXCEED REMARKS AS INDICATED.

Common Bermudagrass

Pistacia chinensis

Myrica pusilla

Cynodon dactylon

DWM

Cercis canadensis 'Oklahoma'

SHRUBS/GROUNDCOVER

Ilex cornuta 'Dwarf Burford'

Raphiolepsis indica 'Clara'

Liriope muscari 'Big Blue'

Loropetalum chinensis 'Plum Delight'


## **Architect/Applicant:** Greenlight Studio LLC 100 N. Cottonwood Drive Suite 104 Richardson, Texas 75080

214.810.4535

# **Civil Engineer:** Pacheco Koch 7557 Rambler Road Suite 1400 Dallas, Texas 75231

972.235.3031



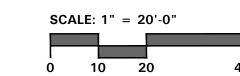



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4245 North Central Expy Suite 501 Dallas, Texas 75205

214,865,7192 office



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# Baumann Building

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4901 Arapaho Road Lot 1, Block A Wingate Inn of Addison Addition Addison, Texas Town Project No. 1809-Z

Project Number: 19147 Issue Date: 01.24.2020 Drawn By:

NAY

Checked By:

Town Comments Town Comments

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Detail:

Sheet Title:

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LANDSCAPE **PLAN** 

Sheet Number:



#### **SECTION 32 9300 - LANDSCAPE**

#### **PART 1 - GENERAL**

#### 1.1 REFERENCED DOCUMENTS

A. Refer to Landscape Plans, notes, details, bidding requirements special provisions, and schedules for additional requirements.

#### 1.2 DESCRIPTION OF WORK

- A. Work included: Furnish all supervision, labor, materials, services equipment and appliances required to complete the work covered in conjunction with the landscaping covered in these specifications and landscaping plans, including:
- 1. Planting (trees, shrubs and grasses)
- 2. Bed preparation and fertilization
- 3. Notification of sources
- 4. Water and maintenance until final acceptance

#### Guarantee

#### 1.3 REFERENCE STANDARDS

- A. American Standard for Nursery Stock published by American Association of Nurserymen: April 14, 2014 Edition; by American National Standards Institute, Inc. (Z60.1) – plant material
- B. American Joint Committee on Horticultural Nomenclature: 1942 Edition of Standardized Plant Names.

C. Texas Association of Nurserymen, Grades and Standards

D. Hortis Third, 1976 - Cornell University

#### 1.4 NOTIFICATION OF SOURCES AND SUBMITTALS

A. Samples: Provide representative quantities of sandy loam soil mulch, bed mix material, gravel, crushed stone, steel edging and tree stakes. Samples shall be approved by Owner's Authorized Representative before use on the project.

#### 1.5 JOB CONDITIONS

- A. General Contractor to complete the following punch list: Prior to Landscape Contractor initiating any portion of landscape 1.7 QUALITY ASSURANCE installation. General Contractor shall leave planting bed areas three (3") inches below final finish grade of sidewalks, drives and curbs as shown on the drawings. All lawn areas to receive solid sod shall be left one (1") inch below the final finish grade of sidewalks, drives and curbs. All construction debris shall be removed prior to Landscape Contractor beginning any work.
- B. Storage of materials and equipment at the job site will be at the risk of the Landscape Contractor. The Owner cannot be held responsible for theft or damage.

#### 1.6 MAINTENANCE AND GUARANTEE

#### A. Maintenance:

- 1. The Landscape Contractor shall be held responsible for the maintenance of all work from the time of planting until final acceptance by the Owner. No trees, shrubs, groundcover or grass will be accepted unless they show healthy growth and satisfactory foliage conditions.
- 2. Maintenance shall include watering of trees and plants, cultivation, weeding spraying, edging, pruning of trees, mowing of grass, cleaning up and all other work necessary of maintenance.
- 3. A written notice requesting final inspection and acceptance should be submitted to the Owner at least seven (7) days prior to completion. An on-site inspection by the Owner's Authorized Representative will be completed prior to written acceptance.
- B. Guarantee:

- 1. Trees, shrubs and groundcover shall be guaranteed for a twelve (12) month period after final acceptance. The Contractor shall replace all dead materials as soon as weather permits and upon notification of the Owner. Plants, including trees, which have partially died so that shape, size, or symmetry have been damaged, shall be considered subject to replacement. In such cases, the opinion of the Owner shall be final.
- a. Plants used for replacement shall be of the same size and kind as those originally planted and shall be planted as originally specified. All work, including materials. labor and equipment used in replacements, shall carry a twelve (12) month guarantee. Any damage, including ruts in lawn or bed areas, incurred as a result of making replacements shall be immediately repaired.
- b. At the direction of the Owner, plants may be replaced at the start of the next year's planting season. In such cases, dead plants shall be removed from the premises 1.8 PRODUCT DELIVERY, STORAGE AND HANDLING
- c. When plant replacements are made, plants, soil mix, fertilizer and mulch are to be utilized as originally specified and re-inspected for full compliance with the contract requirements. All replacements are to be included under "Work" of this section.
- 2. The Owner agrees that for the guarantee to be effective, he will water plants at least twice a week during dry periods and cultivate beds once a month after final acceptance.
- 3. The above guarantee shall not apply where plants die after acceptance because of injury from storms, hail, freeze,

insects, diseases, injury by humans, machines or theft.

- 4. Acceptance for all landscape work shall be given after final inspection by the Owner provided the job is in a complete, undamaged condition and there is a stand of grass in all lawn areas. At that time, the Owner will assume maintenance on the accepted work.
- Repairs: Any necessary repairs under the Guarantee must be made within ten (10) days after receiving notice, weather permitting. In the event the Landscape Contractor does not make repairs accordingly, the Owner, without further notice to Contractor, may provide materials and men to make such repairs at the expense to the Landscape Contractor.

- General: Comply with applicable federal, state, county and local regulations governing landscape materials and work.
- Personnel: Employ only experienced personnel who are familiar with the required work. Provide full time supervision by a qualified foreman acceptable to Landscape Architect.

#### Selection of Plant Material:

- Make contact with suppliers immediately upon obtaining notice of contract acceptance to select and book materials. Develop a program of maintenance (pruning and fertilization) which will ensure the purchased materials will meet and / or exceed project specifications.
- 2. Substitutions: Do not make plant material substitutions. If the specified landscape material is not obtainable, submit proof of non-availability to Landscape Architect, together with proposal for use of equivalent material. At the time bids are submitted, the Contractor is assumed to have located the materials necessary to complete the job as specified.
- 3. Landscape Architect will provide a key identifying each tree location on site. Written verification will be required to document material selection, source and delivery schedules
- 4. Measurements: Measure trees with branches and trunks or canes in their normal position. Do not prune to obtain required sizes. Take caliner measurements six inches above ground for trees up to and including 4" caliper size, and twelve inches above ground for larger sizes. Measure main body of all plant material of height and spread dimensions,

#### do not measure from branch or root tip-to-tip.

- 5. Owner's Authorized Representative shall inspect all plant material with requirements for genus, species, cultivar / variety size and quality.
- 6. Owner's Authorized Representative retains the right to further inspect all plant material upon arrival to the site and during installation for size and condition of root balls and root systems, limbs, branching habit, insects, injuries and latent defects.
- 7. Owner's Authorized Representative may reject unsatisfactory or defective material at any time during the process work. Remove rejected materials immediately from the site and replace with acceptable material at no additional cost to the Owner. Plants damaged in transit or at job site shall be rejected.

#### A. Preparation:

- 1. Balled and Burlapped (B&B) Plants: Dig and prepare shipment in a manner that will not damage roots, branches, shape and future development.
- 2. Container Grown Plants: Deliver plants in rigid container to hold ball shape and protect root mass.

- 1. Deliver packaged materials in sealed containers showing weight, analysis and name of manufacturer. Protect materials from deterioration during delivery and while stored
- 2. Deliver only plant materials that can be planted in one day unless adequate storage and watering facilities are available
- 3 Protect root halls by heeling in with sawdust or other approved moisture retaining material if not planted within 24
- hours of delivery. 4. Protect plants during delivery to prevent damage to root
- balls or desiccation of leaves. Keep plants moist at all times. Cover all materials during transport. 5. Notify Owner's Authorized Representative of delivery schedule 72 hours in advance job site.
- 6. Remove rejected plant material immediately from job site.
- 7. To avoid damage or stress, do not lift, move, adjust to plumb, or otherwise manipulate plants by trunk or stems.

#### PART 2 - PRODUCTS

#### 2.1 PLANTS

TREE PLANTING DETAIL LEGEND

AND ANY OTHER FOREIGN OBJECT;

CONTAINER GROWN STOCK TO BE

FLARE IS EXPOSED, FREE FROM MULCH,

AND AT LEAST TWO INCHES ABOVE

GRADE. TREES SHALL BE REJECTED

RING ON BASE OF ROOTBALL, TRUNK

SHOULD BE IN THE CENTER OF THE

F. ROOT ANCHOR BY TREE STAKE

INSPECTED FOR GIRDLING ROOTS.

D. ROOT FLARE: ENSURE THAT ROOT

- A. General: Well-formed No. 1 grade or better nursery grown stock. Listed plant heights are from tops of root balls to nominal tops of plants. Plant spread refers to nominal outer width of the plant. not to the outer leaf tips. Plants will be individually approved by the Owner's Authorized Representative and his decision as to their acceptability shall be final.
- B. Quantities: The drawings and specifications are complimentary. 2.3 MISCELLANEOUS MATERIALS Anything called for on one and not the other is as binding as if shown and called for on both. The plant schedule is an aid to bidders only. Confirm all quantities on plan.
- C. Quality and size: Plant materials shall conform to the size given on the plan, and shall be healthy, symmetrical, well-shaped, full branched and well rooted. The plants shall be free from injurious insects, diseases, injuries to the bark or roots, broken branches, objectionable disfigurements, insect eggs and larvae, and are to be of specimen quality.
- Approval: All plants which are found unsuitable in growth, or are in any unhealthy, badly shaped or undersized condition will be rejected by the Owner's Authorized Representative either before or after planting and shall be removed at the expense of the Landscape Contractor and replaced with acceptable plant as

#### specified at no additional cost to the Owner

- E. Trees shall be healthy, full-branched, well-shaped, and shall meet the minimum trunk and diameter requirements of the plant schedule. Balls shall be firm, neat, slightly tapered and well wrapped in burlap. Any tree loose in the ball or with a broken PART 3 - EXECUTION root ball at time of planting will be rejected. Balls shall be ten (10") inches in diameter for each one (1") inch of trunk diameter, 3.1 measured six (6") inches above ball. (Nomenclature confirms to the customary nursery usage. For clarification, the term "multi-trunk" defines a plant having three (3) or more trunks of nearly equal diameter.)
- Pruning: All pruning of trees and shrubs, as directed by the Landscape Architect prior to final acceptance, shall be executed by the Landscape Contractor at no additional cost to the Owner.

#### 2.2 SOIL PREPARATION MATERIALS

#### A. Sandy Loam:

- 1. Friable, fertile, dark, loamy soil, free of clay lumps, subsoil, stones and other extraneous material and reasonably free of weeds and foreign grasses. Loam containing Dallasgrass or Nutgrass shall be rejected.
- 2. Physical properties as follows:
- a. Clay between 7-27 percent Silt - between 15-25 percent c. Sand – less than 52 percent
- 3. Organic matter shall be 3%-10% of total dry weight.
- 4. If requested, Landscape Contractor shall provide a certified soil analysis conducted by an approved soil testing laboratory verifying that sandy loam meets the above requirements.
- B. Organic Material: Compost with a mixture of 80% vegetative matter and 20% animal waste. Ingredients should be a mix of 3.2 INSTALLATION course and fine textured material.
- Premixed Bedding Soil as supplied by Vital Earth Resources, Gladewater, Texas; Professional Bedding Soil as supplied by Living Earth Technology, Dallas, Texas or Acid Gro Municipal Mix as supplied by Soil Building Systems, Dallas, Texas or approved
- D. Sharp Sand: Sharp sand must be free of seeds, soil particles and
- E. Mulch: Double Shredded Hardwood Mulch, partially decomposed, dark brown. Living Earth Technologies or approved equal.
- F. Organic Fertilizer: Fertilaid, Sustane, or Green Sense or equal as recommended for required applications. Fertilizer shall be delivered to the site in original unopened containers, each bearing the manufacturer's guaranteed statement of analysis.
- G. Commercial Fertilizer: 10-20-10 or similar analysis. Nitrogen source to be a minimum 50% slow release organic Nitrogen (SCU or UF) with a minimum 8% sulfur and 4% iron, plus
- Peat: Commercial sphagnum peat moss or partially decomposed shredded pine bark or other approved organic material.

- Steel Edging: All steel edging shall be 3/16" thick x 4" deep x 16' long with 6 stakes per section, painted black at the factory as manufactured by The J.D. Russell Company and under its trade name DURAEDGE Heavy Duty Steel
- B. Staking Material for Shade Trees: refer to details.
- D. Filter Fabric: 'Mirafi Mirascape' by Mirafi Construction Products available at Lone Star Products, Inc., (469) 523-0444 or approved equal.

O2 SHRUB / GROUNDCOVER DETAIL NOT TO SCALE

C. Gravel: Washed native pea gravel, graded 1 inch to 1-1/2 inch.

E. River Rock: 'Colorado' or native river rock, 2" - 4" dia.

#### F. Decomposed Granite: Base material shall consist of a natural material mix of granite aggregate not to exceed 1/8" diameter in size and shall be composed of various stages of decomposed

BED PREPARATION & FERTILIZATION

- Landscape Contractor to inspect all existing conditions and report any deficiencies to the Owner
- B. All planting areas shall be conditioned as follows:

thousand (1.000) square feet.

- Prepare new planting beds by scraping away existing grass and weeds as necessary. Till existing soil to a depth of six (6") inches prior to placing compost and fertilizer. Apply fertilizer as per Manufacturer's recommendations. Add six (6") inches of compost and till into a depth of six (6") inches of the topsoil. Apply organic fertilizer such as Sustane or Green Sense at the rate of twenty (20) pounds per one
- 2. All planting areas shall receive a two (2") inch layer of specified mulch.
- 3. Backfill for tree pits shall be as follows: Use existing top soil on site (use imported topsoil as needed) free from large clumps, rocks, debris, caliche, subsoils, etc., placed in nine (9") inch layers and watered in thoroughly.

#### C. Grass Areas:

Blocks of sod should be laid joint to joint (staggered joints) after fertilizing the ground first. Roll grass areas to achieve a smooth, even surface. The joints between the blocks of sod should be filled with topsoil where they are evidently gaped open, then watered thoroughly.

- Maintenance of plant materials shall begin immediately after each plant is delivered to the site and shall continue until all construction has been satisfactorily accomplished.
- B. Plant materials shall be delivered to the site only after the beds are prepared and areas are ready for planting. All shipments of nursery materials shall be thoroughly protected from the drying winds during transit. All plants which cannot be planted at once, after delivery to the site, shall be well protected against the possibility of drying by wind and Balls of earth of B & B plants shall be kept covered with soil or other acceptable material. All plants remain the property of the Contractor until final
- C. Position the trees and shrubs in their intended location as per
- D. Notify the Owner's Authorized Representative for inspection and approval of all positioning of plant materials.
- Excavate pits with vertical sides and horizontal bottom. Tree pits shall be large enough to permit handling and planting without injury to balls of earth or roots and shall be of such depth that, when planted and settled, the crown of the plant shall bear the same relationship to the finish grade as it did to soil surface in original place of growth.
- Shrub and tree pits shall be no less than twenty-four (24") inches wider than the lateral dimension of the earth ball and six (6") inches deeper than it's vertical dimension. Remove and haul from site all rocks and stones over three-quarter (3/4") inch in diameter. Plants should be thoroughly moist before removing 3.3 CLEANUP AND ACCEPTANCE
- G. Dig a wide, rough sided hole exactly the same depth as the height of the ball, especially at the surface of the ground. The sides of the hole should be rough and jagged, never slick or
- H. Percolation Test: Fill the hole with water. If the water level does not percolate within 24 hours, the tree needs to move to another END OF SECTION location or have drainage added. Install a PVC stand pipe per

#### tree planting detail as approved by the Landscape Architect if the percolation test fails.

- Backfill only with 5 parts existing soil or sandy loam and 1 part bed preparation. When the hole is dug in solid rock, topsoil from the same area should not be used. Carefully settle by watering to prevent air pockets. Remove the burlap from the top  $\frac{1}{3}$  of the ball, as well as all nylon, plastic string and wire. Container trees will usually be root bound, if so follow standard nursery practice of 'root scoring'.
- J. Do not wrap trees.
- K. Do not over prune.
- Mulch the top of the ball. Do not plant grass all the way to the trunk of the tree. Leave the area above the top of the ball and mulch with at least two (2") inches of specified mulch.
- All plant beds and trees to be mulched with a minimum settled thickness of two (2") inches over the entire bed or pit.
- N. Obstruction below ground: In the event that rock, or underground construction work or obstructions are encountered in any plant pit excavation work to be done under this section, alternate locations may be selected by the Owner. Where locations cannot be changed, the obstructions shall be removed to a depth of not less than three (3') feet below grade and no less than six (6") inches below the bottom of ball when plant is properly set at the required grade. The work of this section shall include the removal from the site of such rock or underground obstructions encountered at the cost of the Landscape
- Trees and large shrubs shall be staked as site conditions require. Position stakes to secure trees against seasonal prevailing winds.
- P. Pruning and Mulching: Pruning shall be directed by the Landscape Architect and shall be pruned in accordance with standard horticultural practice following Fine Pruning, Class I pruning standards provided by the National Arborist Association.
- 1. Dead wood, suckers, broken and badly bruised branches shall be removed. General tipping of the branches is not permitted. Do not cut terminal branches.
- 2. Pruning shall be done with clean, sharp tools.
- 3. Immediately after planting operations are completed, all tree pits shall be covered with a layer of organic material two (2") inches in depth. This limit of the organic material for trees shall be the diameter of the plant pit.

#### Q. Steel Curbing Installation:

- Curbing shall be aligned as indicated on plans. Stake out limits of steel curbing and obtain Owners approval prior to installation.
- 2. All steel curbing shall be free of kinks and abrupt bends.
- 3. Top of curbing shall be  $\frac{1}{2}$ " maximum height above final
- 4. Stakes are to be installed on the planting bed side of the curbing, as opposed to the grass side.
- 5. Do not install steel edging along sidewalks or curbs.
- 6. Cut steel edging at 45 degree angle where edging meets sidewalks or curbs.

A. Cleanup: During the work, the premises shall be kept neat and orderly at all times. Storage areas for all materials shall be so organized so that they, too, are neat and orderly. All trash and debris shall be removed from the site as work progresses. Keep paved areas clean by sweeping or hosing them at end of each work day.

Owner:

Suite 100

Suite 104

214.810.4535

**Civil Engineer:** 

Pacheco Koch

Suite 1400

972.235.3031

7557 Rambler Road

Dallas, Texas 75231

JR Baumann Holdings LLC

4801 Arapaho Road

Addison, Texas 75001

**Architect/Applicant:** 

Greenlight Studio LLC

100 N. Cottonwood Drive

Richardson, Texas 75080

# Baumann Building 4901 Arapaho Road

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4245 North Central Expy

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Dallas, Texas 75205

214,865,7192 office

Suite 501

Lot 1, Block A Wingate Inn of Addison Addition Addison, Texas

Town Project No. 1809-Z

Project Number: 19147 Issue Date: 01.24.2020 Drawn By:

Checked By:

Town Comments

Town Comments


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Sheet Title:

LANDSCAPE **SPECIFICATIONS** AND DETAILS

Sheet Number:



H. BACKFILL: USE EXISTING NATIVE SOIL A. TREE: TREES SHALL CONFORM WITH LATEST AMERICAN STANDARD FOR TO ELIMINATE AIR POCKETS. NURSERY STOCK. www.anla.org

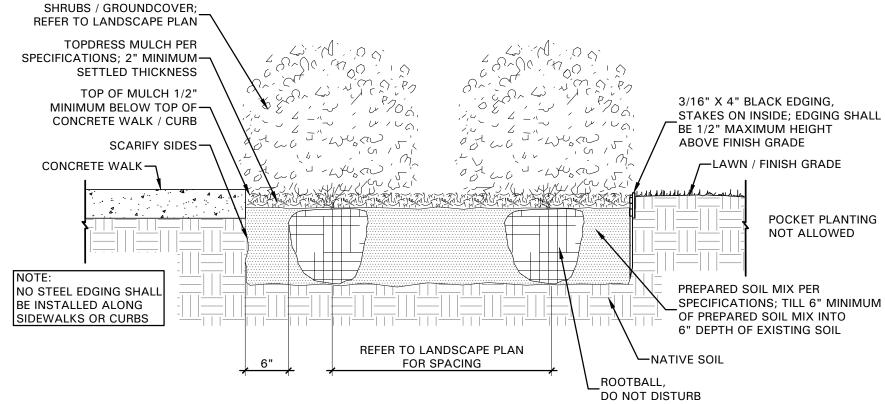B. TREE PIT: WIDTH TO BE AT LEAST TWO (2) TIMES THE DIAMETER OF THE ROOT BALL CENTER TREE IN HOLE & REST ROOT BALL ON UNDISTURBED NATIVE SHOULD NOT BE VISIBLE. C. ROOT BALL: REMOVE TOP 1/3 BURLAP

> AVAILABLE FROM: Tree Stake Solutions ATTN: Jeff Tuley (903) 676-6143

WHEN GIRDLING ROOTS ARE PRESENT & ROOT FLARE IS NOT APPARENT. STAKED BELOW GROUND WHERE E. ROOTBALL ANCHOR RING: REFER TO NECESSARY; ABOVE GROUND STAKING MANUFACTURER'S GUIDELINES FOR IS EXPRESSLY PROHIBITED. SIZING. PLACE ROOTBALL ANCHOR

> K. IT SHALL BE THE RESPONSIBILITY OF THF SPECIFICATIONS PRIOR INSTALLATION.

(no amendments) WATER THOROUGHLY

DOUBLE SHREDDED MULCH: HARDWOOD MULCH 2 INCH SETTLED THICKNESS, WITH 2" HT. WATERING RING: ENSURE THAT ROOT FLARE IS EXPOSED. BELOW GROUND STAKE

TREE STAKE SOLUTIONS 'SAFETY STAKE' BELOW GROUND MODEL

jeff@treestakesolutions.com www.treestakesolutions.com OR APPROVED EQUAL. TREES SHALL BE

THE CONTRACTOR TO OBTAIN A COPY MANUFACTURER'S INSTALLATION OF TREE STAKES. CONTRACTOR SHALL ADHERE TO MANUFACTURER'S INSTALLATION GUIDELINES, SPECIFICATIONS, AND OTHER REQUIREMENTS FOR TREE STAKE

ADJACENT TO ROOTBALL (DO NOT DISTURB ROOTBALL)

SOLUTIONS.

MANUFACTURER'S GUIDELINES FOR SIZING. INSTALL NAIL STAKES WITH HAMMER OR MALLET FIRMLY INTO UNDISTURBED GROUND. DRIVE NAIL STAKES FLUSH WITH "U" BRACKET

STAKE:



#### **Planning & Zoning Commission**

**Meeting Date:** 10/20/2020

#### **Agenda Caption:**

**PUBLIC HEARING** <u>Case 1818-Z/3820 Belt Line Road.</u> Public hearing, discussion, and take action on a recommendation regarding an ordinance changing the zoning on property located at 3820 Belt Line Road, from PD, Planned Development, to a new PD district to allow a two-story retail and office building.


#### **Attachments**

1818-Z P&Z Packet 1818-Z Plans

# 1818-Z

**PUBLIC HEARING** Case 1818-Z/3820 Belt Line Road. Public hearing, discussion, and take action on a recommendation regarding an ordinance changing the zoning on property located at 3820 Belt Line Road, from PD, Planned Development, to a new PD district to allow a two-story retail and office building.

#### **LOCATION MAP**

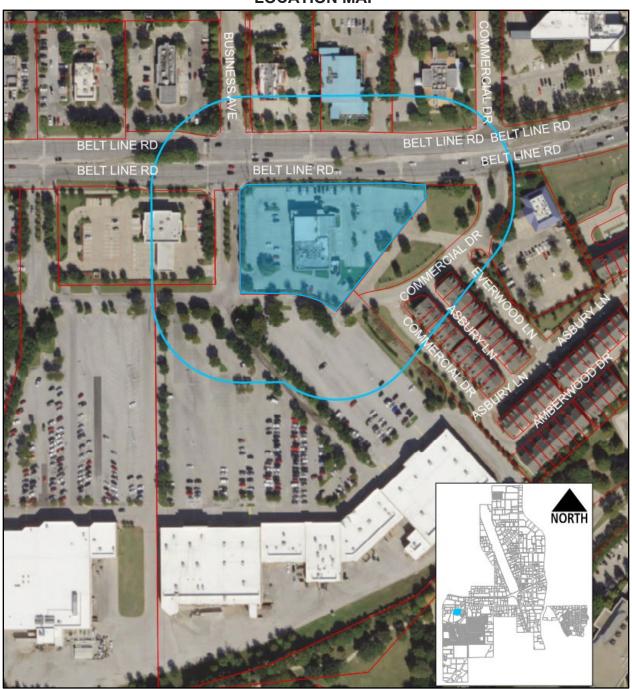



October 20, 2020

#### **STAFF REPORT**

RE:

Case 1818-Z/3820 Belt Line Road

LOCATION:

3820 Belt Line Road

Approval of an ordinance changing the zoning from Planned Development (PD) district, through Ordinance O93-018, as amended by Ordinance O15-030, to a new PD district in order to permit development of a new two-story retail and office building.

APPLICANT:

Gregg Lisciotti, Addison Retail LLC

DISCUSSION:

<u>Background</u>: This 2.034-acre property is part of a Planned Development (PD) district through Ordinance O93-018, as amended by Ordinance O15-030. This is a large PD that applies to several properties including Addison Town Center. The property currently contains a one-story restaurant building, previously occupied by Humperdink's Restaurant and Brewpub. The building has been vacant since May 2017.

Addison Retail LLC recently purchased the property with the intent to develop a retail center. Given the existing site is governed by the previously approved development plans, such action requires a rezoning.

In 2006, the Town established the Belt Line District, requiring all properties along the Belt Line Road corridor to follow the envisioned standards as they redevelop in order to accommodate more density and provide for a more pedestrian friendly experience. The intent of this zoning district is:

- 1. To provide a comfortable and attractive environment for pedestrians which includes such things as buildings framing public space, street trees, lighting and awnings.
- 2. To construct buildings close to the sidewalk and street.
- 3. To construct continuous building frontage along block faces except where it is desirable to provide for pedestrian and auto pass-throughs to parking at mid-block.

- 4. To provide shared parking both on-street and in the center of blocks that will benefit the entire district.
- 5. To contribute to the definition and use of public parks and plazas.
- To design and build nonresidential buildings to accommodate a range of uses over time without the need to destroy older buildings and rebuild them for each successive use.
- 7. To design streets and buildings that will contribute to creating a safe environment.
- 8. To encourage redevelopment on a block-by-block basis.

Since the Town adopted the Belt Line District, only the Asbury Circle townhome neighborhood, located just east of this site, has been zoned to the Belt Line District. The Belt Line District also served as the foundation for the Addison Grove Planned Development district with several additional requirements.

<u>Proposed Plan</u>: The applicant is proposing to develop a new two-story, surface-parked, retail and office building. The building is proposed to be 3,223 square feet with 2,503 square feet of first floor retail and 720 square feet of second floor office. The proposed development is located on the eastern portion of the site and will not replace the existing restaurant space.

A new Planned Development district is being proposed based, in part, on the Belt Line District standards as well as the streetscape standards established in the Master Transportation Plan (MTP).

<u>Land Uses</u>: Under the Belt Line District retail and commercial uses are permitted as-of-right and are required to be constructed to a depth of 50 feet. Restaurant uses are permitted through a Special Use Permit (SUP). It is noted that uses that are not explicitly authorized, are prohibited. The applicant is proposing retail and commercial uses, to be constructed at a depth of just over 94 feet, this meets the requirements of the Belt Line District.

#### Block Face:

<u>Block Length</u>: The Belt Line District standards call for a block length minimum of 200 feet and maximum of 600 feet. The proposed plans show the main building face as 60 feet and the existing standalone restaurant building face as 99.4 feet. **At 159.4 feet this does not meet the requirements of the Belt Line District. The applicant is asking to count the property in its entirety as one full block, measuring approximately 420 feet.** 

<u>Building Setback</u>: The Belt Line District identifies Belt Line Road as street type A-1, which has a required built-to line of 94 feet. The submitted site plan shows a 94-foot building setback.

<u>Building Height</u>: The Belt Line District standards require a minimum height of 2 stories and a maximum height of 4 stories, for this subdistrict. The submitted façade plans show a two-story building with a maximum height of 25 feet. The first-floor retail will have ceiling heights of 16 feet, which meets Belt Line District Requirements.

Streets: The Belt Line District standards require conformity with the Master Transportation Plan and show street type A-1 to have a 14-foot sidewalk directly in front of the front building façade, an 18-foot row of parking, a 24-foot drive aisle another 18-foot row of parking, then a 4-foot landscape buffer, and an 8-foot sidewalk protected by a 8-foot parkway buffer from Belt Line Road. The submitted site plan shows a 14.8-foot sidewalk directly in front of the proposed building, an 18-foot row of parking, a 24-foot drive aisle, a 17.7-foot row of parking, a 3.4-foot landscape buffer, an 8-foot sidewalk at the back of curb, and an 8.2-foot parkway buffer. This is consistent with the Belt Line District standards and the Master Transportation Plan. The row of parking closest to Belt Line Road is 5 inches less than the minimum parking space length, this was allowed to accommodate landscape improvements along Belt Line Road.

<u>Streetscape and Landscape</u>: The landscape plans have been reviewed by the Parks Department for compliance with the Town's Landscape Ordinance. The proposed landscape plans meet all requirements and the applicant agreed to provide 50% of the funding for the landscape improvements along Belt Line Road, including a landscape buffer and sidewalk improvements.

#### **Building Standards:**

<u>Building Form</u>: The Belt Line District standards require a tripartite architecture and landmark features when a building is located on an axis with a terminating street or at the intersection of streets. The proposed building facades show unique building articulations which are offset from the front wall planes.

<u>Architectural Features</u>: The Belt Line District standards require that windows be a vertical proportion and prohibits glass curtain walls. The proposed façade plans shown meet all Belt Line District requirements.

External Facades: The Belt Line District standards require ground floor exterior walls to be constructed of 80% brick or stone, and windows/glazing for each building façade to be limited to a minimum of 30% glazing and maximum of 70% glazing. The submitted plans show the facades as primarily brick or stone. However, not all building elevations meet the glazing requirements, showing the primary building south façade at 17% glazing. The south façade's building materials are made up of 73% brick or stone, which is also less the Belt Line Road requirements of 80%. The applicant is requesting that the Town allow the south façade of the building to be exempt from the 30% glazing requirement and the 80% brick or stone building materials requirement.

<u>Color</u>: The Belt Line District standards require the dominant color of all buildings to be muted shades of color. Black and stark white shall not be used except as an accent color. The submitted plans show facades of the main building in cool light and dark grey tones and the standalone restaurant building in light grey and maroon, with black trim.

<u>Retail Ground Floor</u>: The Belt Line District standards require a minimum clear height of 16 feet between finished floors, an awning or canopy which extends 6 feet over the sidewalk for at least 75% of the frontage on any portion of the building and maintains a 7.5-foot clearance over the sidewalk, and highly transparent glass windows. The submitted façade plans show all the requirements will be met.

#### Parking:

<u>Automobile Parking</u>: The Belt Line District parking requirement ratio for a retail use is 1 parking space per 200 square feet, for a restaurant use the ratio is 1 parking space per 100 square feet, and for office space the ratio is 1 parking space per 300 square feet. The site shows a total of 128 parking spaces. The proposed 10,382 square feet of existing restaurant space would require 112 parking spaces, the 2,503 square feet of retail would require 13 parking spaces, and the 720 square feet would require 3 parking spaces, all totaling 128 parking spaces. The proposed development meets parking requirements.

<u>Bicycle Parking</u>: The Belt Line District requires bicycle parking at a ratio of 1 bicycle parking space per 10 automobile required parking spaces, located within 50 feet of an entrance to the building. The proposed site requires 13 bicycle parking spaces and the submitted site plan shows 14 bicycles spaces will be provided.

<u>Fire Access</u>: Plans have been reviewed by the Fire Marshal to ensure sufficient site access and building coverage. The submitted site plans show all requirements will be met.

#### RECOMMENDATION: APPROVAL


In approaching this case, staff has attempted to work with the developer to apply as many of the Belt Line District standards as possible. While implementing the Belt Line District standards is the long-term goal, some standards are not feasible on a small in-fill site such as this. As a result, a Planned Development District is necessary.


The property does not comply with the Belt Line District standards in the following ways:

- The block length of the buildings is smaller than required.
- The southern facade of the building does not provide the required percentage of glazing and brick or stone.

While these standards are not met, Staff recognizes that the small size of the site's block face, 420 feet, makes a minimum 200-foot façade unfeasible. Additionally, Staff supports reducing the minimum glazing and brick or stone requirements for the southern façade as they are not visible from Belt Line Road.

Staff believes that the development meets the future vision for the Belt Line District and recommends approval without conditions.

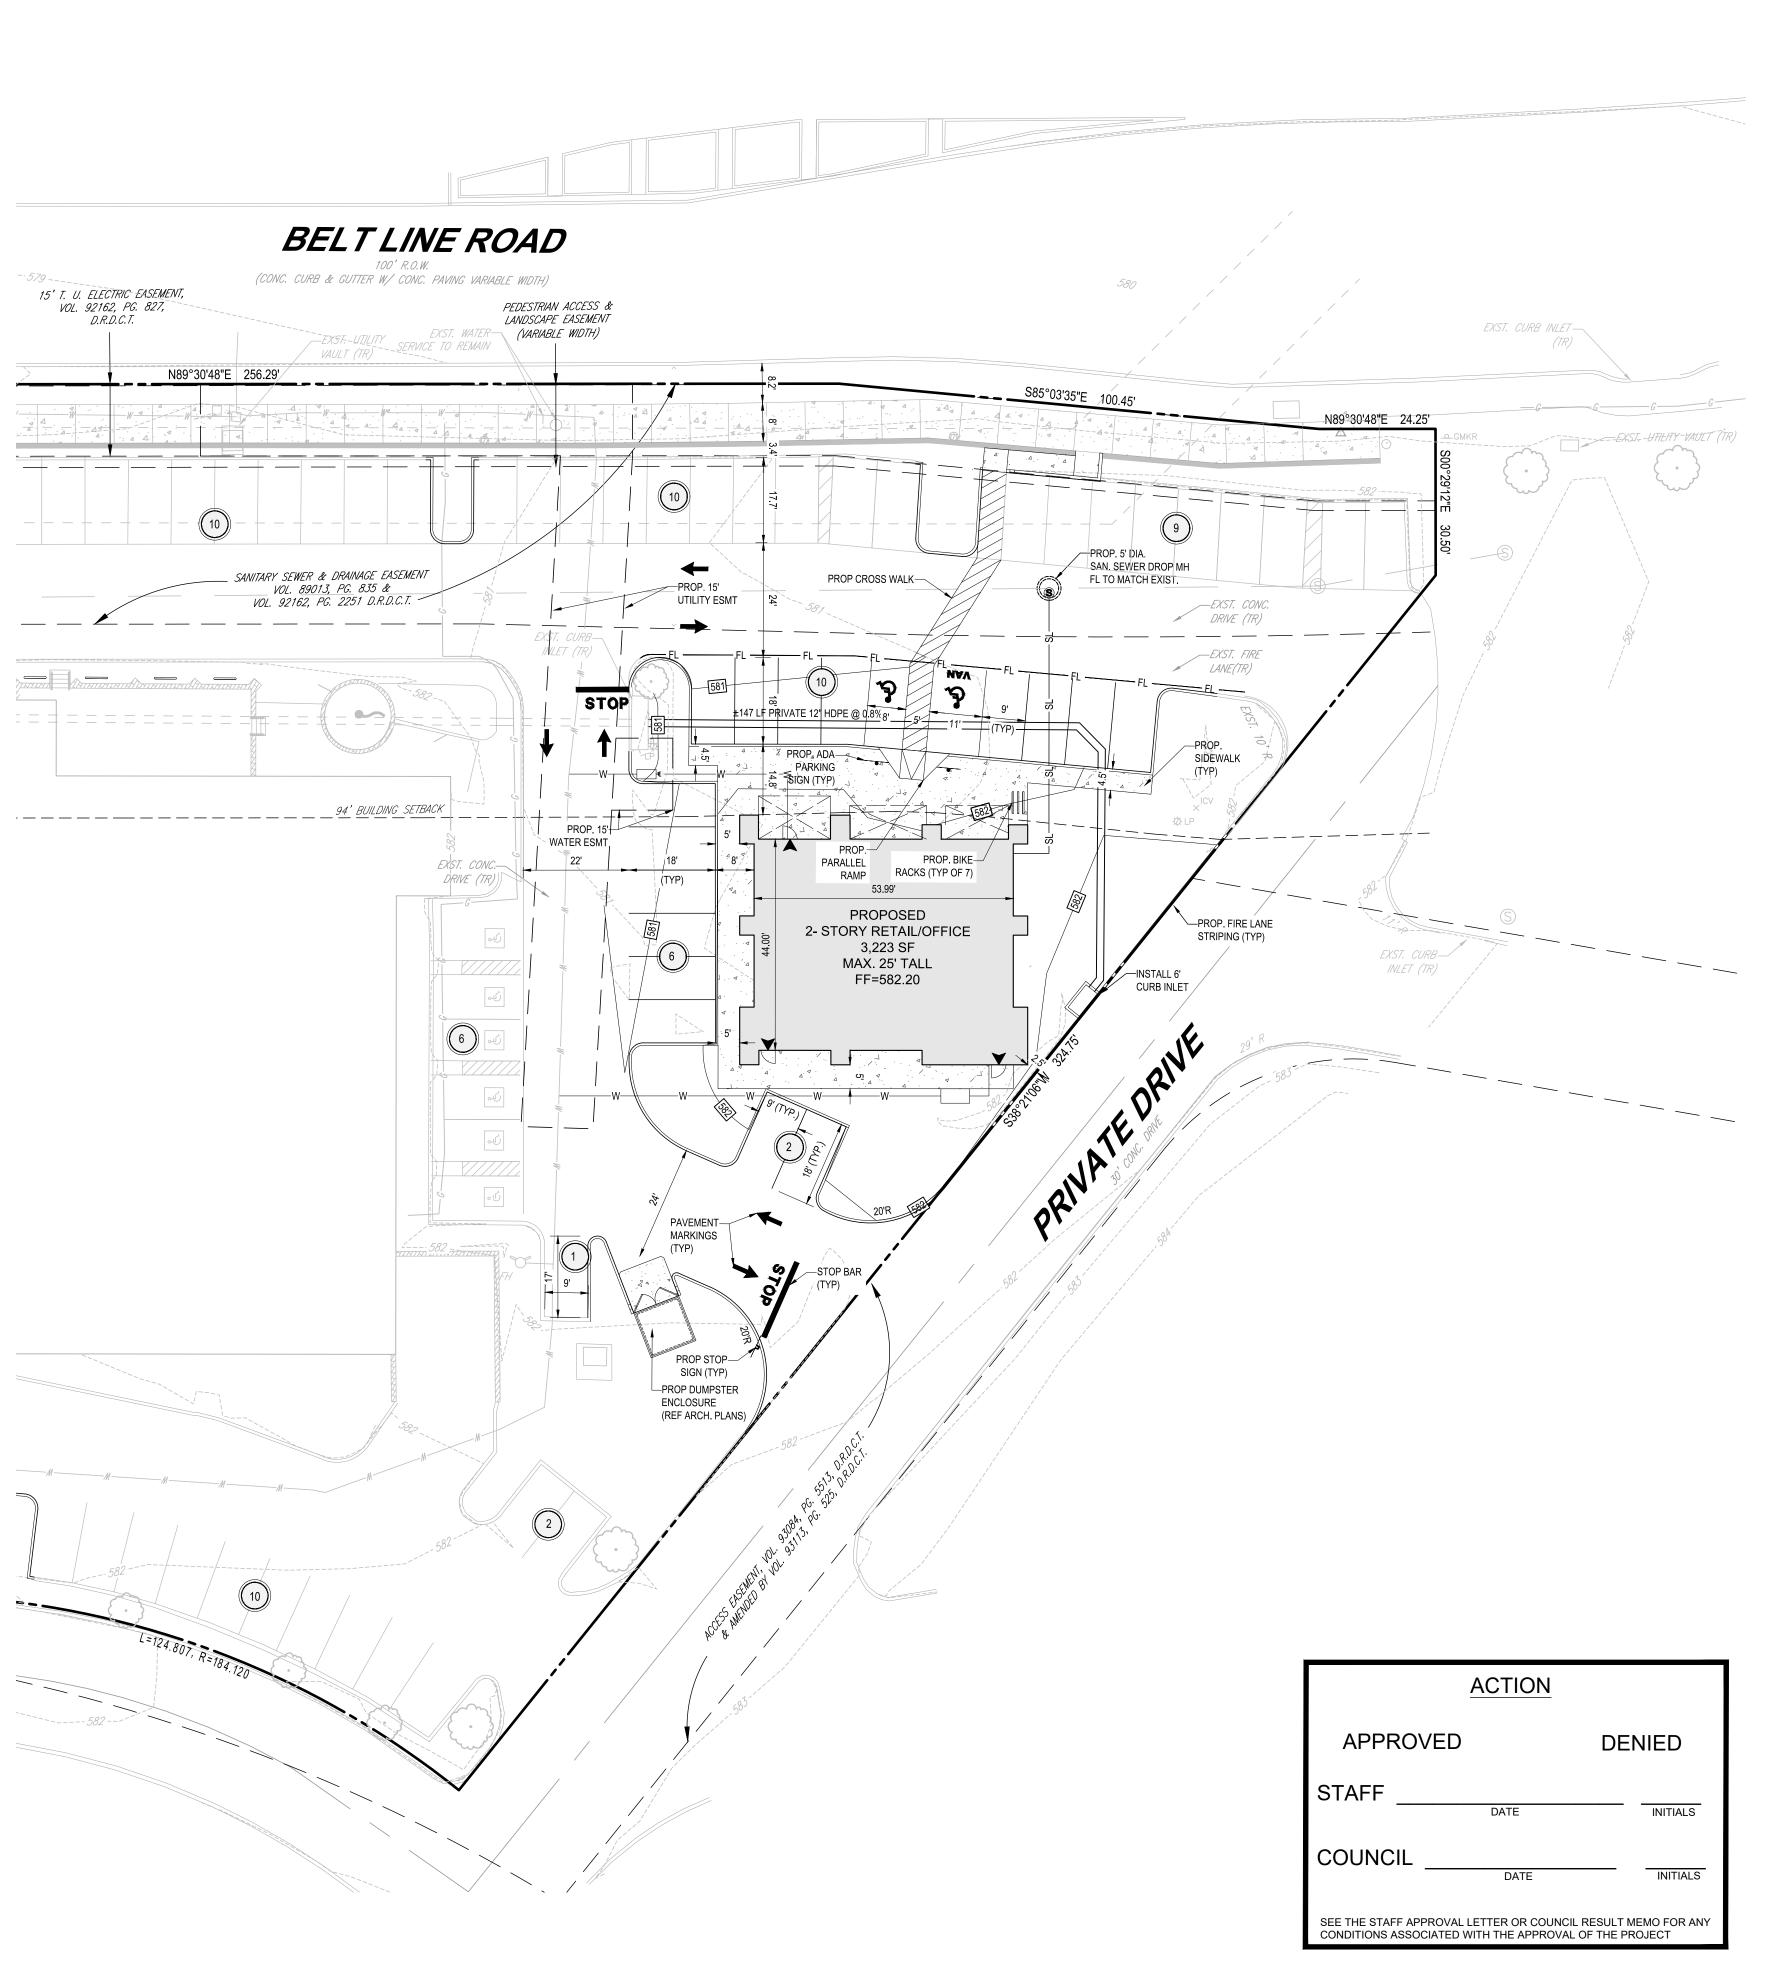

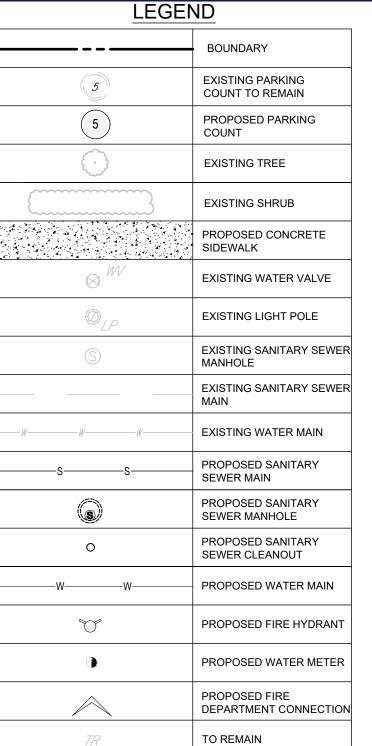

# TOWN OF ADDISON SITE PLAN NOTES:

- 1. ANY REVISION TO THIS PLAN WILL REQUIRE TOWN APPROVAL AND WILL REQUIRE REVISIONS TO ANY CORRESPONDING PLANS TO AVOID CONFLICTS BETWEEN PLANS.
- 2. OPEN STORAGE, WHERE PERMITTED, SHALL BE SCREENED IN ACCORDANCE WITH THE ZONING ORDINANCE.
- 3. BUILDINGS WITH AN AGGREGATE SUM OF 5,000 SQUARE FEET OR GREATER ON A LOT SHALL HAVE AUTOMATIC FIRE SPRINKLERS INSTALLED THROUGHOUT ALL STRUCTURES. ALTERNATIVE FIRE PROTECTION MEASURES MAY BE APPROVED BY THE FIRE DEPARTMENT.
- 4. ALL SIGNAGE IS SUBJECT TO TOWN APPROVAL.
- 5. ALL FENCES AND RETAINING WALLS SHALL BE SHOWN ON THE SITE PLAN AND ARE SUBJECT TO BUILDING INSPECTION DIVISION APPROVAL.


#### GENERAL SITE PLAN NOTES:

- 1. ALL DIMENSIONS ARE FROM FACE OF CURB OR FACE OF BUILDING UNLESS NOTED OTHERWISE.
- 2. ALL CURB RADII ARE 3' UNLESS NOTED OTHERWISE
- . CONTRACTOR SHALL REFER TO THE ARCHITECTURAL PLANS FOR EXACT LOCATIONS AND DIMENSIONS OF VESTIBULES, SLOPE PAVING, SIDEWALKS, EXIT PORCHES, TRUCK DOCKS, PRECISE BUILDING DIMENSIONS AND EXACT BUILDING UTILITY ENTRANCE LOCATIONS.
- 4. ALL DISTURBED AREAS ARE TO RECEIVE FOUR INCHES OF TOPSOIL, SEED , MULCH AND WATER UNTIL A HEALTHY STAND OF GRASS IS ESTABLISHED.
- EXISTING STRUCTURES WITHIN CONSTRUCTION LIMITS ARE TO BE ABANDONED, REMOVED OR RELOCATED AS NECESSARY. ALL COSTS SHALL BE INCLUDED IN BASE BID.
- 6. CONTRACTOR SHALL BE RESPONSIBLE FOR ALL RELOCATIONS, (UNLESS OTHERWISE NOTED ON PLANS) INCLUDING BUT NOT LIMITED TO, ALL UTILITIES, STORM DRAINAGE, SIGNS, TRAFFIC SIGNALS & POLES, ETC. AS REQUIRED. ALL WORK SHALL BE IN ACCORDANCE WITH GOVERNING AUTHORITIES REQUIREMENTS AND PROJECT SITE WORK SPECIFICATIONS AND SHALL BE APPROVED BY SUCH. ALL COST SHALL BE INCLUDED IN BASE BID.
- 7. SITE BOUNDARY, TOPOGRAPHY, UTILITY AND ROAD INFORMATION TAKEN FORM A SURVEY BY A LAND SURVEYOR.
- 8. THIS DEVELOPMENT WILL NOT IMPACT THE EXISTING NATURAL RESOURCES OF THE SURROUNDING PROPERTIES.
- 9. SITE LIES WITHIN 'ZONE X, 0.2 PCT ANNUAL CHANCE FLOOD HAZARD,' ACCORDING TO FEMA FLOOD MAP 48113C0180K.
- 10. THE CONSTRUCTION OF THIS PROJECT WILL INCLUDE THE REMOVAL OF 6 TREES AND THE PLANTING OF 25 TREES, RESULTING IN A SURPLUS OF 19 TREES.
- 11. THIS PLAN CONFORMS WITH DESIGN STANDARDS INCLUDED IN THE TOWN OF ADDISON TRANSPORTATION PLAN, WATER SYSTEM REQUIREMENTS, WASTEWATER SYSTEM REQUIREMENTS, AND DRAINAGE CRITERIA MANUAL.
- 12. REFER TO ARCHITECTURAL PLANS FOR EXACT DIMENSIONS OF PROPOSED BUILDINGS. ONLY THE OVERALL FOOTPRINTS HAVE BEEN OUTLINED IN THIS SITE PLAN.
- 13. REFERENCE APPROVED CONSTRUCTION DOCUMENTS TITLED BELT LINE 1.5 PREPARED BY PACHECO KOCH DATED 01/02/2020 SIGNED BY AMBER M. DAVIS.
- 14. ANY PAVEMENT REPLACEMENT SHALL BE IN ACCORDANCE WITH THE TOWN OF ADDISON'S PAVEMENT SECTION SPECIFICATIONS, OR MATCH EXISTING SECTIONS WHICHEVER IS GREATER.

#### WATER METER TABLE

METER TYPE	AMOUNT
1.5" METER - PROPOSED	1

ENGINEER:
BOHLER ENGINEERING
AXIS SURVEYING
ADDISON RETAIL, LLC
6017 MAIN STREET
714 FERRIS AVE B
83 ORCHARD HILL PARK DR
FRISCO, TX 75034
WAXAHACHIE, TX 75168
LEOMINSTER, MA 04153
PHONE: (469) 458-7300
PHONE: (214) 903-8200
PHONE: (978) 466-6661
CONTACT: MATHIAS HAUBERT
CONTACT: SEAN SHROPSHIRE
CONTACT: GREGG LISCIOTT

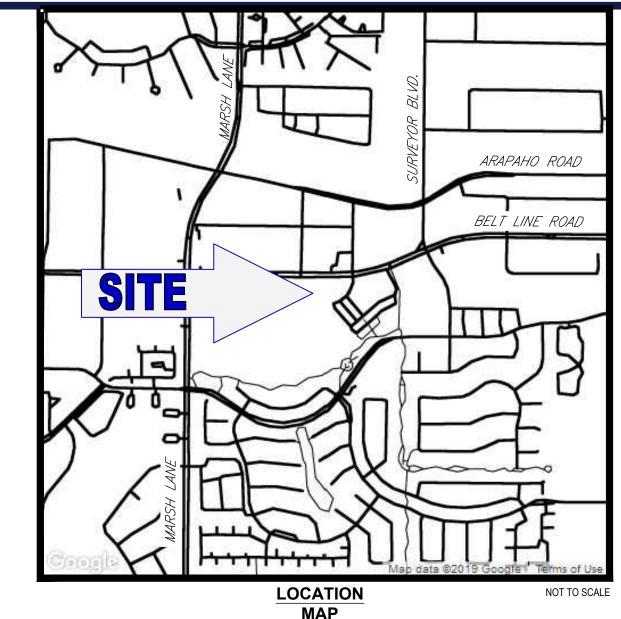

## SITE DATA SUMMARY SITE INFORMATION

TOTAL LOT AREA 88,597 SF (2.034 AC)

PROPOSED BUILDING AREAS & HEIGHTS: (2,503 SF = RETAIL; 720 SF = OFFICE)

EXISTING BUILDING AREAS

10,382 SF, 1-STORY
760 SF PATIO

TOTAL LOT COVERAGE

13,645 SF (15.4%)

#### PARKING DATA

TARRINGT	
REQUIRED	
GENERAL RETAIL/PROFESSIONAL SERVICES	1 SPACE / 200 SF
RETAIL REQURIED	13 SPACES
OFFICE	1 SPACE / 300 SF
OFFICE REQUIRED	3 SPACES
RESTAURANT	1 SPACE / 100 SF
RESTAURANT REQUIRED	112 SPACES
TOTAL PARKING REQUIRED	128 SPACES
BIKE PARKING (1 / 10 SPACES)	13 SPACES
PROVIDED	
GENERAL PARKING	120 SPACES
ADA COMPLIANT PARKING*	8 SPACES
TOTAL PROPOSED PARKING	128 SPACES
PROPOSED BIKE PARKING	14 SPACES

REQUIRED OPEN SPACE 20% (17,719 SF)

PROVIDED OPEN SPACE 21.5% (19,123 SF)
(INCLUDES OPEN SPACE IN ROW)

SPACE USAGE

### JURISDICTIONAL

EXISTING ZONING / USE	PD 93-018 / RESTAURANT
PROPOSED ZONING / USE	BELT LINE DISTRICT & RESTAURANT/RETAIL/OFFICE
BUILDING SETBACKS:	
FRONT	94'
SIDE	N/A
REAR	N/A

\* HANDICAP PARKING IS PROVIDED IN ACCORDANCE WITH ADA STANDARDS.

LANDSCAPE BUFFER\*\*

IMPERVIOUS SURFACE AFTER

\*\* EXISTING LANDSCAPE BUFFER RANGES FROM 18'-19'. EXISTING SIDEWALK AND LANDSCAPE AREA TO REMAIN IN CURRENT CONDITIONS. REQUIRED LANDSCAPE BUFFER HAS BEEN CALCULATED AS 19' FROM THE BELT LINE DISTRICT THOROUGHFARE PLAN.



19.6' LANDSCAPE BUFFER INCLUDING

71,294 SF



REVISIONS

DATE COMMENT

CHECKED E



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ISSUED FOR MUNICIPAL & AGENCY REVIEW & APPROVAL

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 PROJECT No.:
 TD180002

 DRAWN BY:
 JJB

 CHECKED BY:
 MJH

 DATE:
 10/7/2020

PROJECT:

CAD I.D.:

SITE DEVELOPMENT PLANS

— FOR —

ADDISON RETAIL LLC

3820 BELT LINE ROAD
ADDISON, TX 75001
DALLAS COUNTY
THOMAS L CHINOWITH ABST. 273
BLOCK A, LOT 1R, 2.034 AC

### BOHLER/


6017 MAIN STREET FRISCO, TX 75034 Phone: (469) 458-7300 **TX@BohlerEng.com** TBPE No. 18065 | TBPLS No. 10194413


SHEET TITLE:

SITE PLAN

EET NUMBER:

C-300

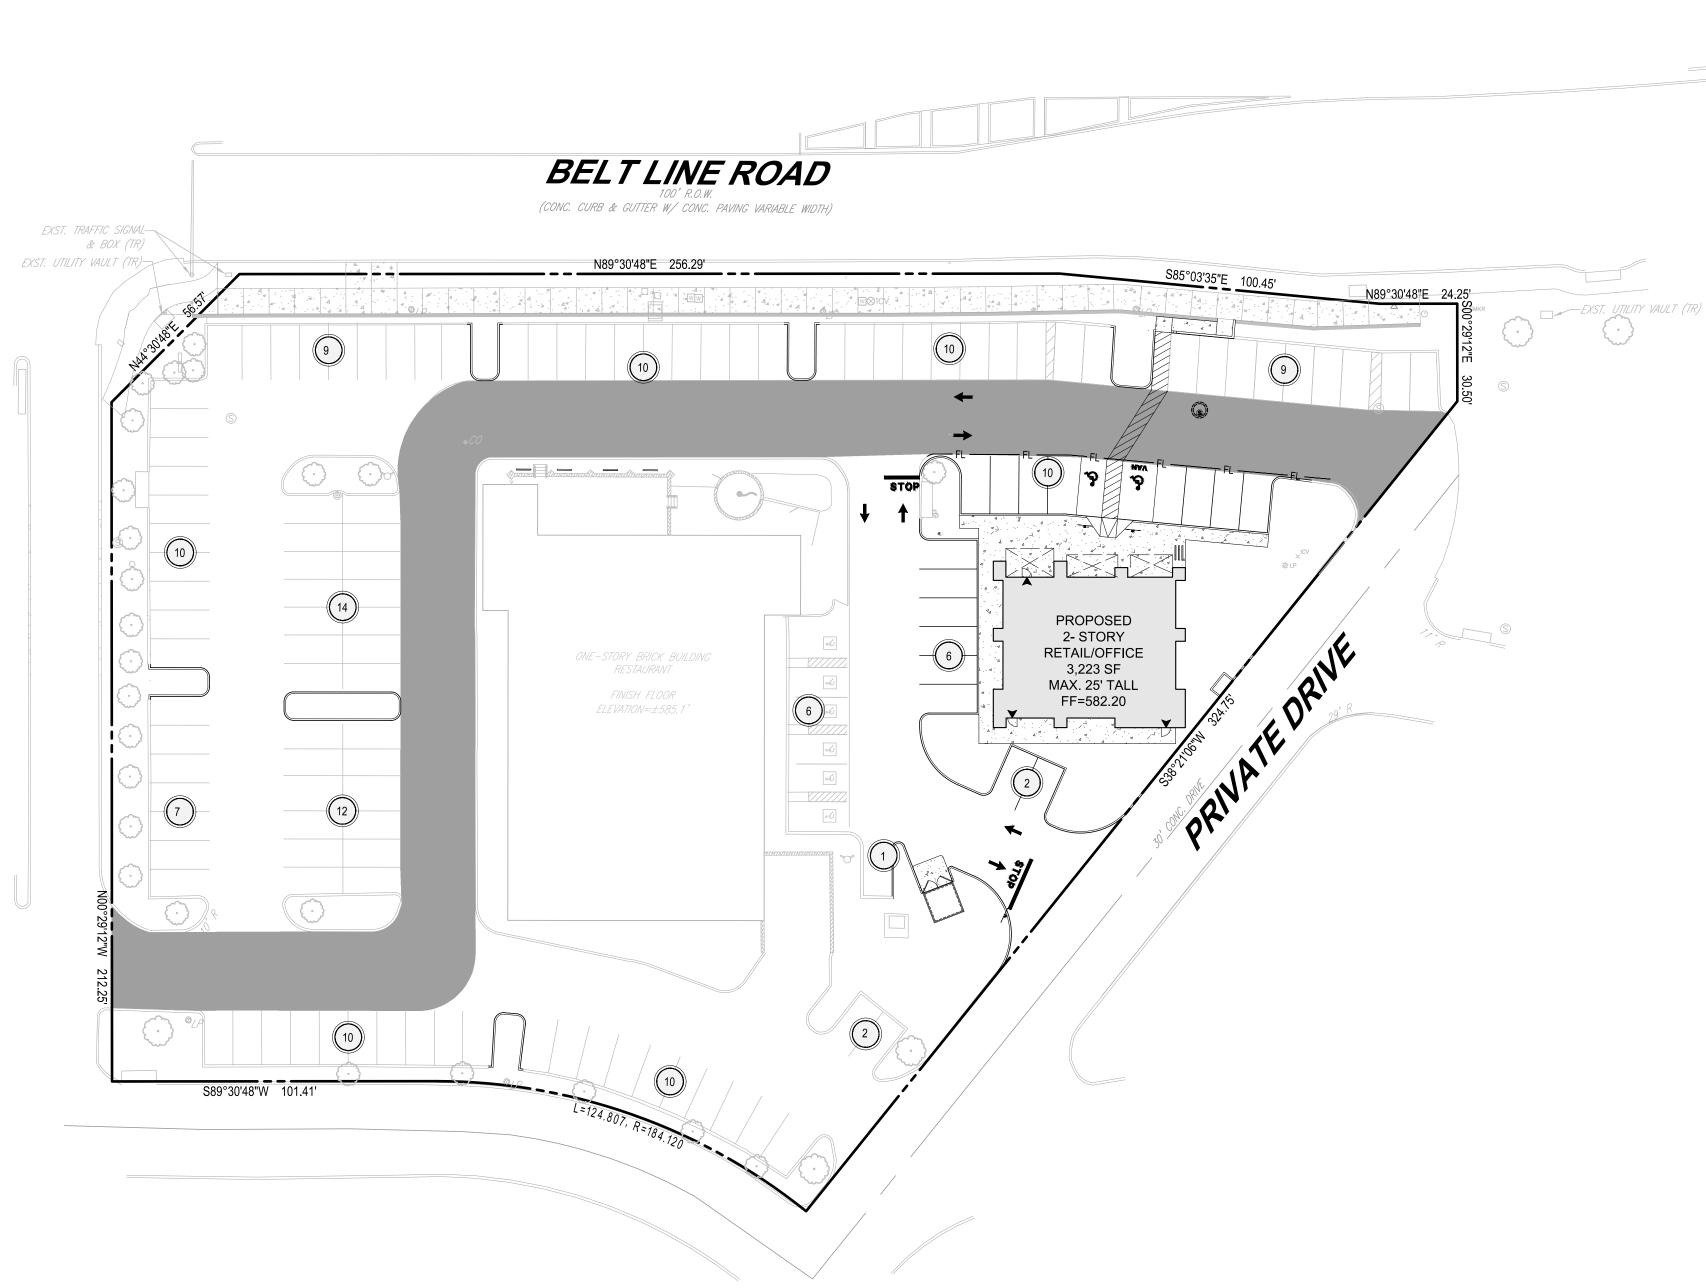

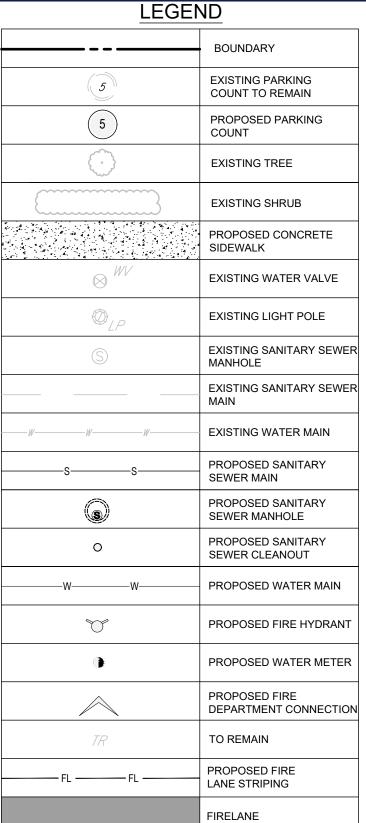

#### TOWN OF ADDISON SITE PLAN NOTES:

- ANY REVISION TO THIS PLAN WILL REQUIRE TOWN APPROVAL AND WILL REQUIRE
  REVISIONS TO ANY CORRESPONDING PLANS TO AVOID CONFLICTS BETWEEN PLANS.
- 2. OPEN STORAGE, WHERE PERMITTED, SHALL BE SCREENED IN ACCORDANCE WITH THE ZONING ORDINANCE.
- 3. BUILDINGS WITH AN AGGREGATE SUM OF 5,000 SQUARE FEET OR GREATER ON A LOT SHALL HAVE AUTOMATIC FIRE SPRINKLERS INSTALLED THROUGHOUT ALL STRUCTURES. ALTERNATIVE FIRE PROTECTION MEASURES MAY BE APPROVED BY THE FIRE DEPARTMENT.
- 4. ALL SIGNAGE IS SUBJECT TO TOWN APPROVAL.
- 5. ALL FENCES AND RETAINING WALLS SHALL BE SHOWN ON THE SITE PLAN AND ARE SUBJECT TO BUILDING INSPECTION DIVISION APPROVAL.

  GENERAL SITE PLAN NOTES:
- ALL DIMENSIONS ARE FROM FACE OF CURB OR FACE OF BUILDING UNLESS NOTED OTHERWISE.
- 2. ALL CURB RADII ARE 3' UNLESS NOTED OTHERWISE
- CONTRACTOR SHALL REFER TO THE ARCHITECTURAL PLANS FOR EXACT LOCATIONS AND DIMENSIONS OF VESTIBULES, SLOPE PAVING, SIDEWALKS, EXIT PORCHES, TRUCK DOCKS, PRECISE BUILDING DIMENSIONS AND EXACT BUILDING UTILITY ENTRANCE LOCATIONS.
- 4. ALL DISTURBED AREAS ARE TO RECEIVE FOUR INCHES OF TOPSOIL, SEED , MULCH AND WATER UNTIL A HEALTHY STAND OF GRASS IS ESTABLISHED.
- 5. EXISTING STRUCTURES WITHIN CONSTRUCTION LIMITS ARE TO BE ABANDONED, REMOVED OR RELOCATED AS NECESSARY. ALL COSTS SHALL BE INCLUDED IN BASE
- 6. CONTRACTOR SHALL BE RESPONSIBLE FOR ALL RELOCATIONS, (UNLESS OTHERWISE NOTED ON PLANS) INCLUDING BUT NOT LIMITED TO, ALL UTILITIES, STORM DRAINAGE, SIGNS, TRAFFIC SIGNALS & POLES, ETC. AS REQUIRED. ALL WORK SHALL BE IN ACCORDANCE WITH GOVERNING AUTHORITIES REQUIREMENTS AND PROJECT SITE WORK SPECIFICATIONS AND SHALL BE APPROVED BY SUCH. ALL COST SHALL BE INCLUDED IN BASE BID.
- 7. SITE BOUNDARY, TOPOGRAPHY, UTILITY AND ROAD INFORMATION TAKEN FORM A SURVEY BY A LAND SURVEYOR.
- 8. THIS DEVELOPMENT WILL NOT IMPACT THE EXISTING NATURAL RESOURCES OF THE SURROUNDING PROPERTIES.
- 9. SITE LIES WITHIN 'ZONE X, 0.2 PCT ANNUAL CHANCE FLOOD HAZARD,' ACCORDING TO FEMA FLOOD MAP 48113C0180K.
- 10. THE CONSTRUCTION OF THIS PROJECT WILL INCLUDE THE REMOVAL OF 6 TREES AND THE PLANTING OF 25 TREES, RESULTING IN A SURPLUS OF 19 TREES.
- 11. THIS PLAN CONFORMS WITH DESIGN STANDARDS INCLUDED IN THE TOWN OF ADDISON TRANSPORTATION PLAN, WATER SYSTEM REQUIREMENTS, WASTEWATER SYSTEM REQUIREMENTS, AND DRAINAGE CRITERIA MANUAL.
- 12. REFER TO ARCHITECTURAL PLANS FOR EXACT DIMENSIONS OF PROPOSED BUILDINGS. ONLY THE OVERALL FOOTPRINTS HAVE BEEN OUTLINED IN THIS SITE PLAN.
- 13. REFERENCE APPROVED CONSTRUCTION DOCUMENTS TITLED BELT LINE 1.5 PREPARED BY PACHECO KOCH DATED 01/02/2020 SIGNED BY AMBER M. DAVIS.
- 14. ANY PAVEMENT REPLACEMENT SHALL BE IN ACCORDANCE WITH THE TOWN OF ADDISON'S PAVEMENT SECTION SPECIFICATIONS, OR MATCH EXISTING SECTIONS WHICHEVER IS GREATER.

WAXAHACHIE, TX 75168

CONTACT: MATHIAS HAUBERT CONTACT: SEAN SHROPSHIRE CONTACT: GREGG LISCIOTT

PHONE: (214) 903-8200

WATER METER TABLE			
TER TYPE	AMOUNT		

LEOMINSTER, MA 04153

PHONE: (978) 466-6661

		1.5" METE	R - PROPOSED	1	
,					
	ENGINEER:		SURVEYOR:	OWNER/	APPLICANT
	BOHLER ENG	INEERING	AXIS SURVEYING	ADDISON	N RETAIL, LLC
	6017 MAIN ST	REET	714 FERRIS AVE E	83 ORCH	IARD HILL PARK DR

FRISCO, TX 75034

PHONE:(469) 458-7300


**ACTION** 

SEE THE STAFF APPROVAL LETTER OR COUNCIL RESULT MEMO FOR ANY

CONDITIONS ASSOCIATED WITH THE APPROVAL OF THE PROJECT

**APPROVED** 

DENIED

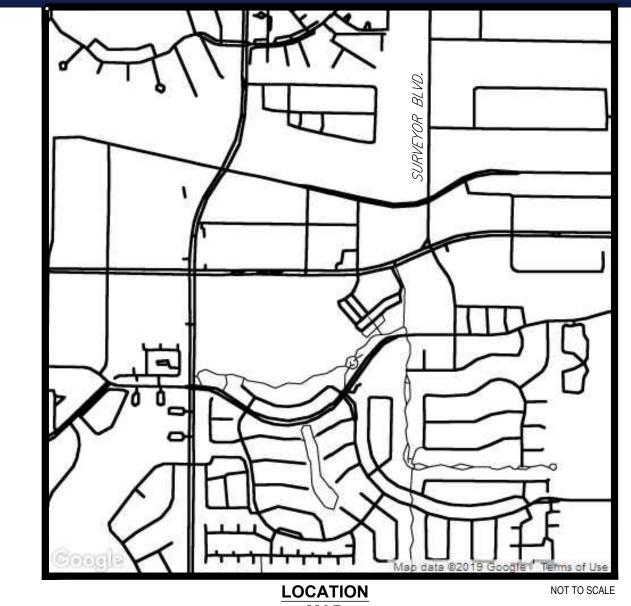

SITE DATA SUMMARY	
SITE INFORMATION	

TOTAL LOT AREA 88,597 SF (2.034 AC)

PROPOSED BUILDING AREAS & HEIGHTS: (2,503 SF = RETAIL; 720 SF = OFFICE)

EXISTING BUILDING AREAS 10,382 SF, 1-STORY 760 SF PATIO

13,645 SF (15.4%)

#### PARKING DA

TOTAL LOT COVERAGE

PROVIDED OPEN SPACE

PARKIN	IG DATA
REQUIRED	
GENERAL RETAIL/PROFESSIONAL SERVICES	1 SPACE / 200 SF
RETAIL REQURIED	13 SPACES
OFFICE	1 SPACE / 300 SF
OFFICE REQUIRED	3 SPACES
RESTAURANT	1 SPACE / 100 SF
RESTAURANT REQUIRED	112 SPACES
TOTAL PARKING REQUIRED	128 SPACES
BIKE PARKING (1 / 10 SPACES)	13 SPACES
PROVIDED	
GENERAL PARKING	120 SPACES
ADA COMPLIANT PARKING*	8 SPACES
TOTAL PROPOSED PARKING	128 SPACES
PROPOSED BIKE PARKING	14 SPACES
SPACE	USAGE
REQUIRED OPEN SPACE	20% (17,719 SF)
	<u> </u>

IMPERVIOUS SURFACE AFTER DEVELOPMENT 71,294 SF

JURISDICTIONAL

EXISTING ZONING / USE PD 93-018 / RESTAURANT

PROPOSED ZONING / USE BELT LINE DISTRICT &

BUILDING SETBACKS:

FRONT
94'

SIDE
N/A

REAR
N/A

LANDSCAPE BUFFER\*\*

19.6' LANDSCAPE BUFFER INCLUDING SIDEWALK

N. \* HANDICAP PARKING IS PROVIDED IN ACCORDANCE WITH ADA STANDARDS.

\*\* EXISTING LANDSCAPE BUFFER

RANGES FROM 18'-19'. EXISTING
SIDEWALK AND LANDSCAPE AREA TO
REMAIN IN CURRENT CONDITIONS.
REQUIRED LANDSCAPE BUFFER HAS
BEEN CALCULATED AS 19' FROM THE
BELT LINE DISTRICT THOROUGHFARE
PLAN.



21.5% (19,123 SF)

(INCLUDES OPEN SPACE IN ROW)

RESTAURANT/RETAIL/OFFICE



REVISIONS

DATE COMMENT DRAWN BY CHECKED BY



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 SP0

PROJECT:

SITE DEVELOPMENT PLANS

— 1 OK —

ADDISON RETAIL LLC

3820 BELT LINE ROAD ADDISON, TX 75001 DALLAS COUNTY THOMAS L CHINOWITH ABST. 273 BLOCK A, LOT 1R, 2.034 AC



6017 MAIN STREET FRISCO, TX 75034 Phone: (469) 458-7300 **TX@BohlerEng.com** 


TBPE No. 18065 | TBPLS No. 10194413

SHEET TITLE:

OVERALL SITE PLAN

EET NUMBER:

C-301

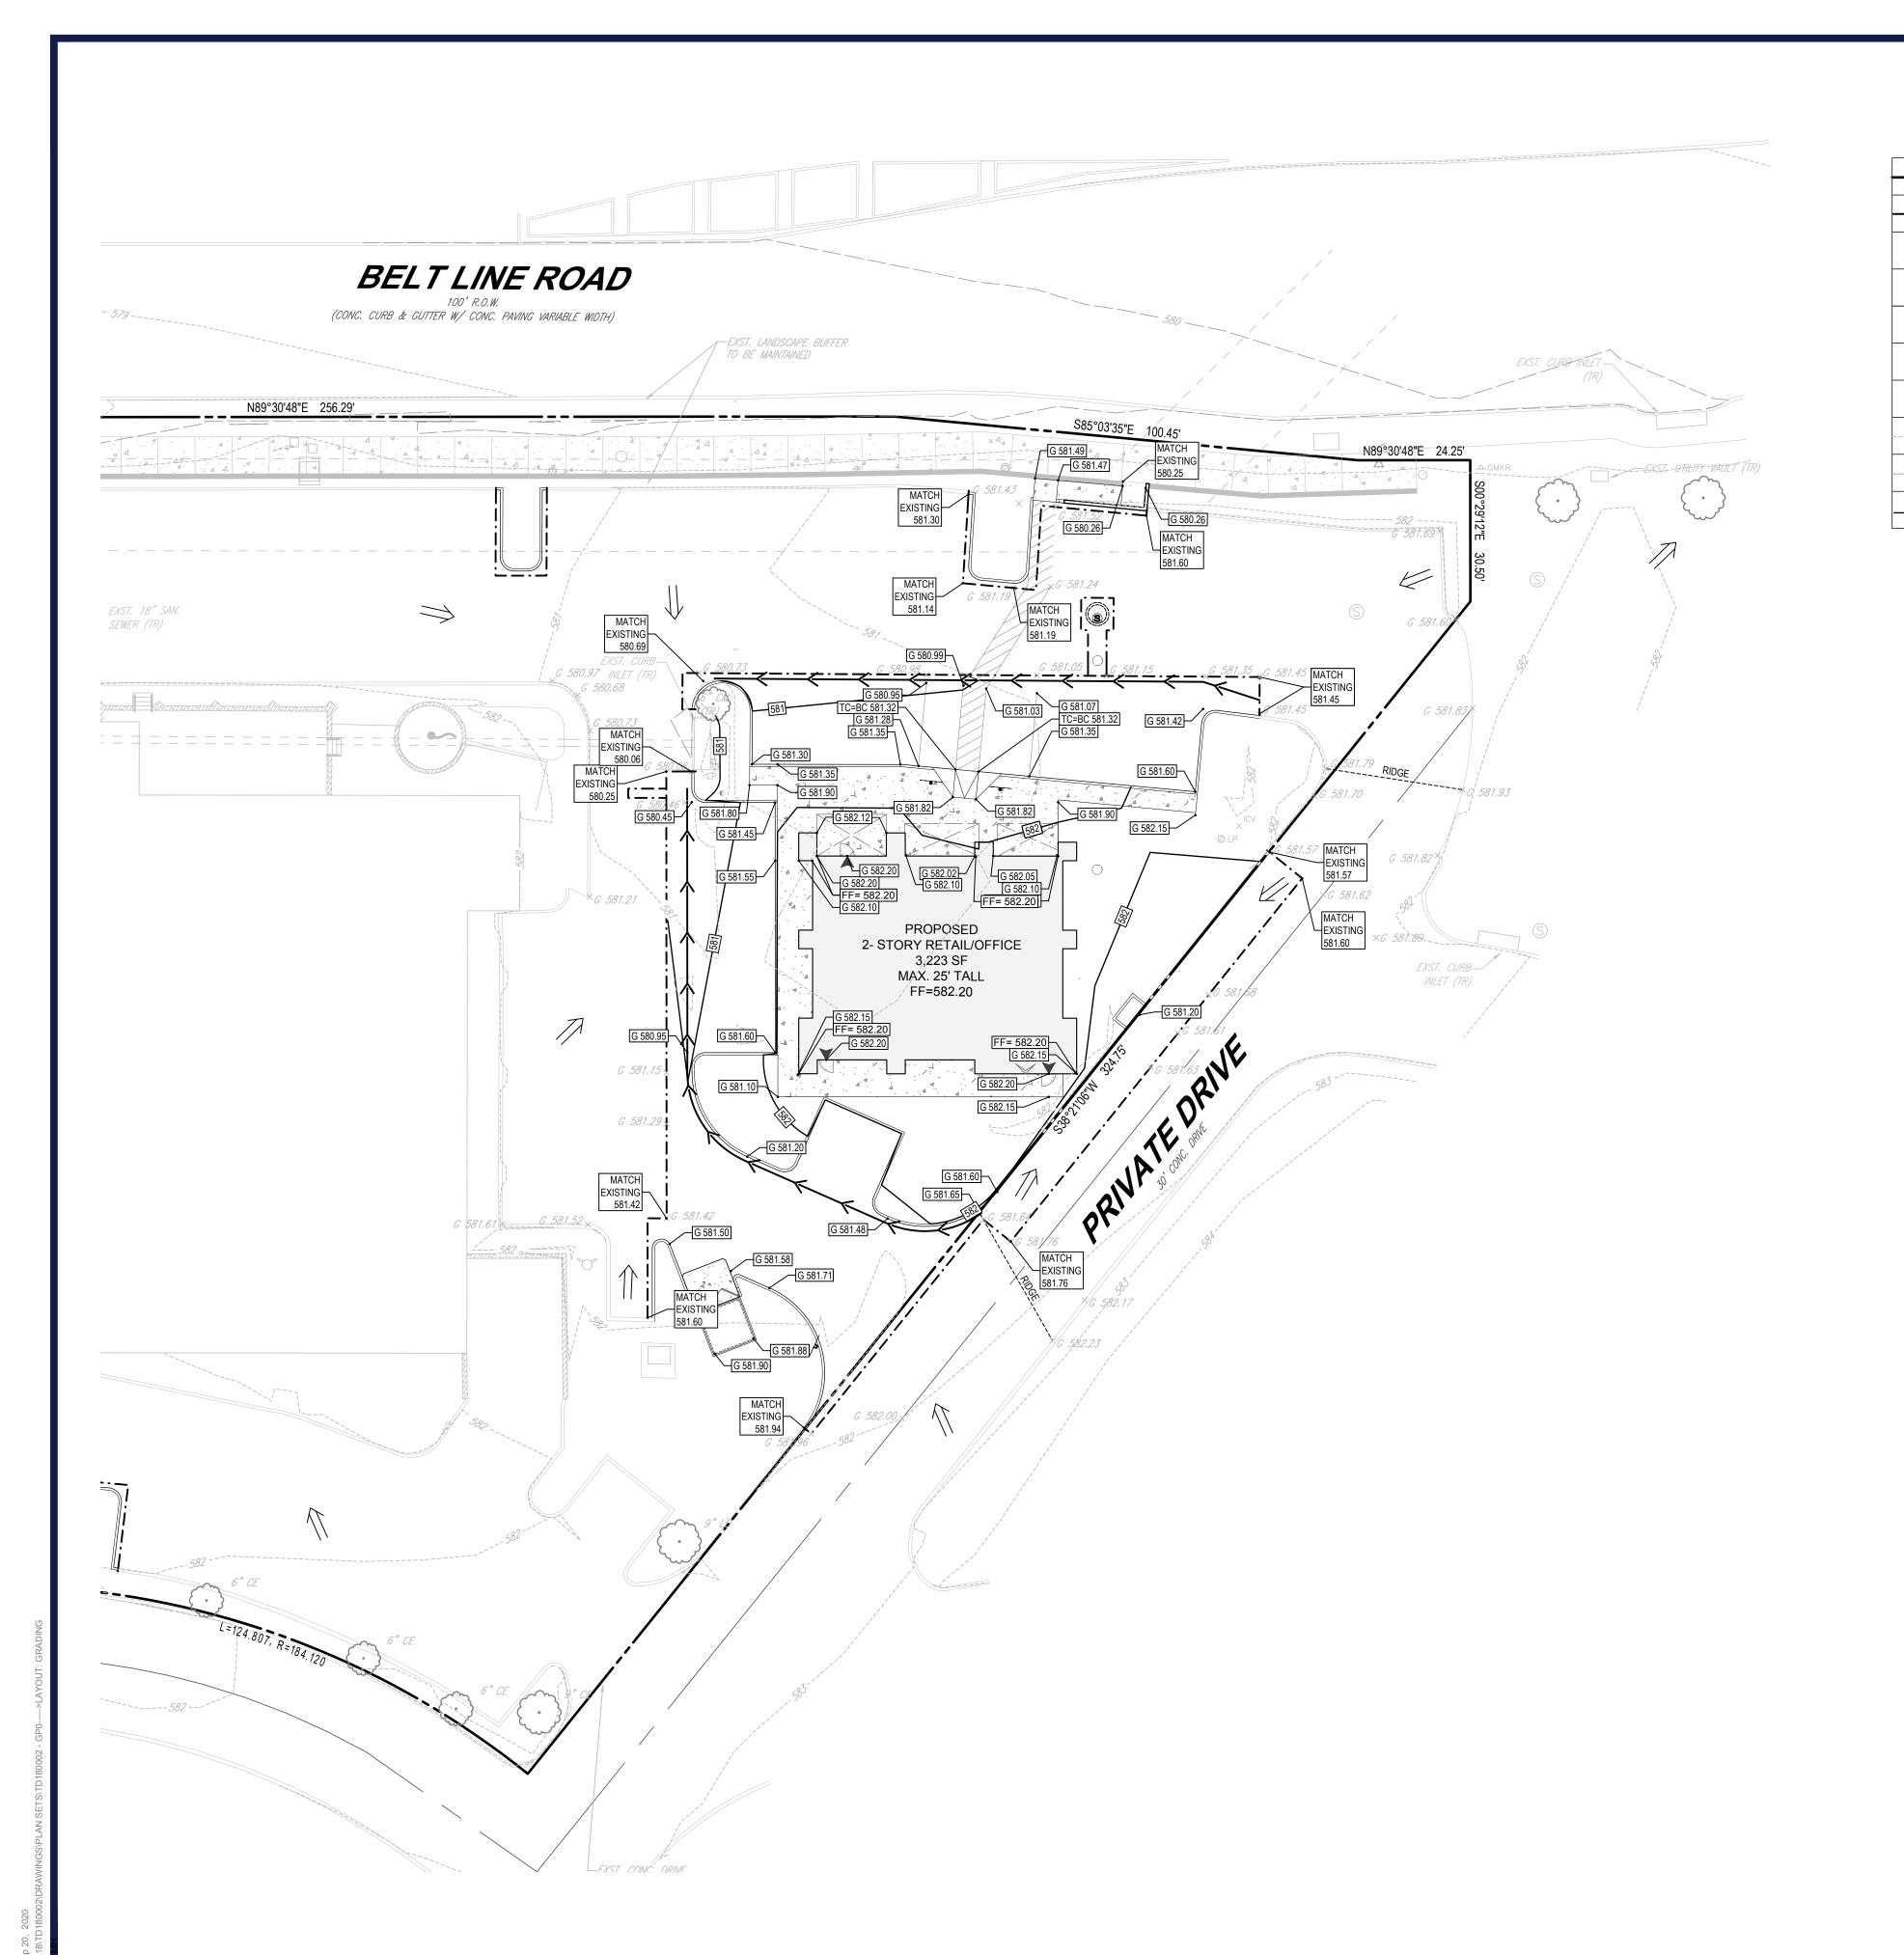

#### LEGEND

	BOUNDARY
	PROPOSED SAWCUT LIMIT
$\odot$	EXISTING TREE
	EXISTING SHRUB
₩V	EXISTING WATER VALVE
<b>⊕</b> LP	EXISTING LIGHT POLE
(S)	EXISTING SANITARY SEWER
600 :	EXISTING MINOR CONTOUR
- — — — 600 — — —	EXISTING MAJOR CONTOUR
601	PROPOSED CONTOUR

#### **GRADING NOTES:**

- 1. ALL CONSTRUCTION TO BE IN ACCORDANCE WITH THESE PLANS AND THE
- 2. PRIOR TO STARTING CONSTRUCTION, THE CONTRACTOR SHALL MAKE CERTAIN THAT ALL REQUIRED PERMITS AND APPROVALS HAVE BEEN OBTAINED. NO CONSTRUCTION OR FABRICATION SHALL BEGIN UNTIL THE CONTRACTOR HAS RECEIVED AND THOROUGHLY REVIEWED ALL PLANS AND OTHER DOCUMENTS APPROVED BY ALL OF THE PERMITTING
- 3. THE GENERAL CONTRACTOR AND ALL SUB-CONTRACTORS SHALL VERIFY THE SUITABILITY OF ALL EXISTING AND PROPOSED SITE CONDITIONS INCLUDING GRADES AND DIMENSIONS BEFORE COMMENCEMENT OF ANY CONSTRUCTION. THE ENGINEER SHALL BE NOTIFIED IMMEDIATELY OF ANY DISCREPANCIES. MINOR ADJUSTMENTS TO FINISH GRADE TO ACCOMPLISH SPOT DRAINAGE ARE ACCEPTABLE, IF NECESSARY. UPON PRIOR APPROVAL OF ENGINEER. PAVING INSTALLED SHALL "FLUSH OUT" AT ANY JUNCTURE WITH EXISTING PAVING.
- 4. THE CONTRACTOR IS SPECIFICALLY CAUTIONED THAT THE LOCATION AND/OR ELEVATION OF EXISTING UTILITIES AS SHOWN ON THESE PLANS IS BASED ON RECORDS OF THE VARIOUS UTILITY COMPANIES, AND WHERE POSSIBLE, MEASUREMENTS TAKEN IN THE FIELD. THE INFORMATION IS NOT TO BE RELIED ON AS BEING EXACT OR COMPLETE. THE CONTRACTOR MUST CALL THE APPROPRIATE UTILITY COMPANIES AT LEAST 72 HOURS BEFORE ANY EXCAVATION TO REQUEST EXACT FIELD LOCATION OF UTILITIES. IT SHALL BE THE RESPONSIBILITY OF THE CONTRACTOR TO RELOCATE ALL EXISTING UTILITIES WHICH CONFLICT WITH THE PROPOSED IMPROVEMENTS SHOWN ON THE PLANS.
- 5. EXISTING GRADE CONTOUR INTERVALS SHOWN AT 1 FOOT INTERVALS.
- 6. PROPOSED GRADE CONTOUR INTERVALS SHOWN AT 1 FOOT INTERVALS.
- 7. THE CONTRACTOR SHALL ADHERE TO ALL TERMS & CONDITIONS AS OUTLINED IN THE TEXAS GENERAL T.P.D.E.S. PERMIT FOR STORM WATER DISCHARGE ASSOCIATED WITH CONSTRUCTION ACTIVITIES.
- 8. CONTRACTOR SHALL ASSURE POSITIVE DRAINAGE AWAY FROM BUILDINGS FOR ALL NATURAL AND PAVED AREAS.
- 9. TOPOGRAPHIC INFORMATION IS TAKEN FROM BOUNDARY/TOPOGRAPHIC SURVEY FROM BOHLER ENGINEERING. IF THE CONTRACTOR DOES NOT ACCEPT EXISTING TOPOGRAPHY AS SHOWN ON THE PLANS, WITHOUT EXCEPTION, THEN THE CONTRACTOR SHALL SUPPLY, AT THEIR EXPENSE, A TOPOGRAPHIC SURVEY BY A REGISTERED LAND SURVEYOR TO THE OWNER FOR REVIEW.
- RECEIVE 4 INCHES OF TOPSOIL. CONTRACTOR SHALL STABILIZE
  DISTURBED AREAS IN ACCORDANCE WITH GOVERNING SPECIFICATIONS
- 12. ALL ELEVATIONS ARE TOP OF PAVEMENT UNLESS NOTED OTHERWISE. TO
- 13. GRADING FOR ALL SIDEWALKS AND ACCESSIBLE ROUTES INCLUDING CROSSING DRIVEWAYS SHALL CONFORM TO ADA STANDARDS. SLOPES SHALL NOT EXCEED 5% LONGITUDINAL SLOPE OR 2% CROSS SLOPE. SIDEWALK ACCESS TO EXTERNAL BUILDING DOORS SHALL BE ADA COMPLIANT. CONTRACTOR SHALL NOTIFY ENGINEER IMMEDIATELY IF ADA CRITERIA CANNOT BE MET AT ANY LOCATION.
- 14. ANY PROPOSED CONTOURS SHOWN ARE APPROXIMATE. PROPOSED SPOT ELEVATIONS AND DESIGNATED GRADIENT ARE TO BE USED IN THE

- TOWN OF ADDISON STANDARDS AND SPECIFICATIONS.

- 10. ALL SUBSURFACE AREAS DISTURBED BY GRADING OPERATION SHALL UNTIL A HEALTHY STAND OF VEGETATION IS OBTAINED.
- 11. CONSTRUCTION SHALL COMPLY WITH ALL APPLICABLE GOVERNING CODES AND BE CONSTRUCTED TO SAME.
- GET TOP OF CURB ELEVATIONS ADD 6" TO THE ELEVATION SHOWN.
- EVENT OF ANY DISCREPANCIES.
- 15. REFER TO EROSION CONTROL PLAN FOR EROSION CONTROL DEVICES TO BE INSTALLED PRIOR TO COMMENCING GRADING OPERATIONS.
- 16. ALL VEGETATION SHALL BE CLEARED AND GRUBBED FOR ALL AREAS TO BE DISTURBED.





**REVISIONS** 

REV DATE COMMENT



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PROJECT No.: DRAWN BY: **CHECKED BY:** 08/03/2020 DATE: CAD I.D.:

PROJECT:

### SITE **DEVELOPMENT**

**PLANS** 


### **ADDISON RETAIL**

LLC

3820 BELT LINE ROAD ADDISON, TX 75001 DALLAS COUNTY THOMAS L CHINOWITH ABST. 273 BLOCK A, LOT 1R, 2.034 AC

## **BOHLER**


6017 MAIN STREET FRISCO, TX 75034 Phone: (469) 458-7300 TX@BohlerEng.com TBPE No. 18065 | TBPLS No. 10194413

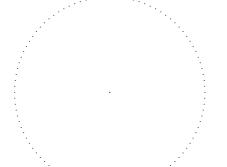

SHEET TITLE:

PRELIMINARY **GRADING PLAN** 

C-400

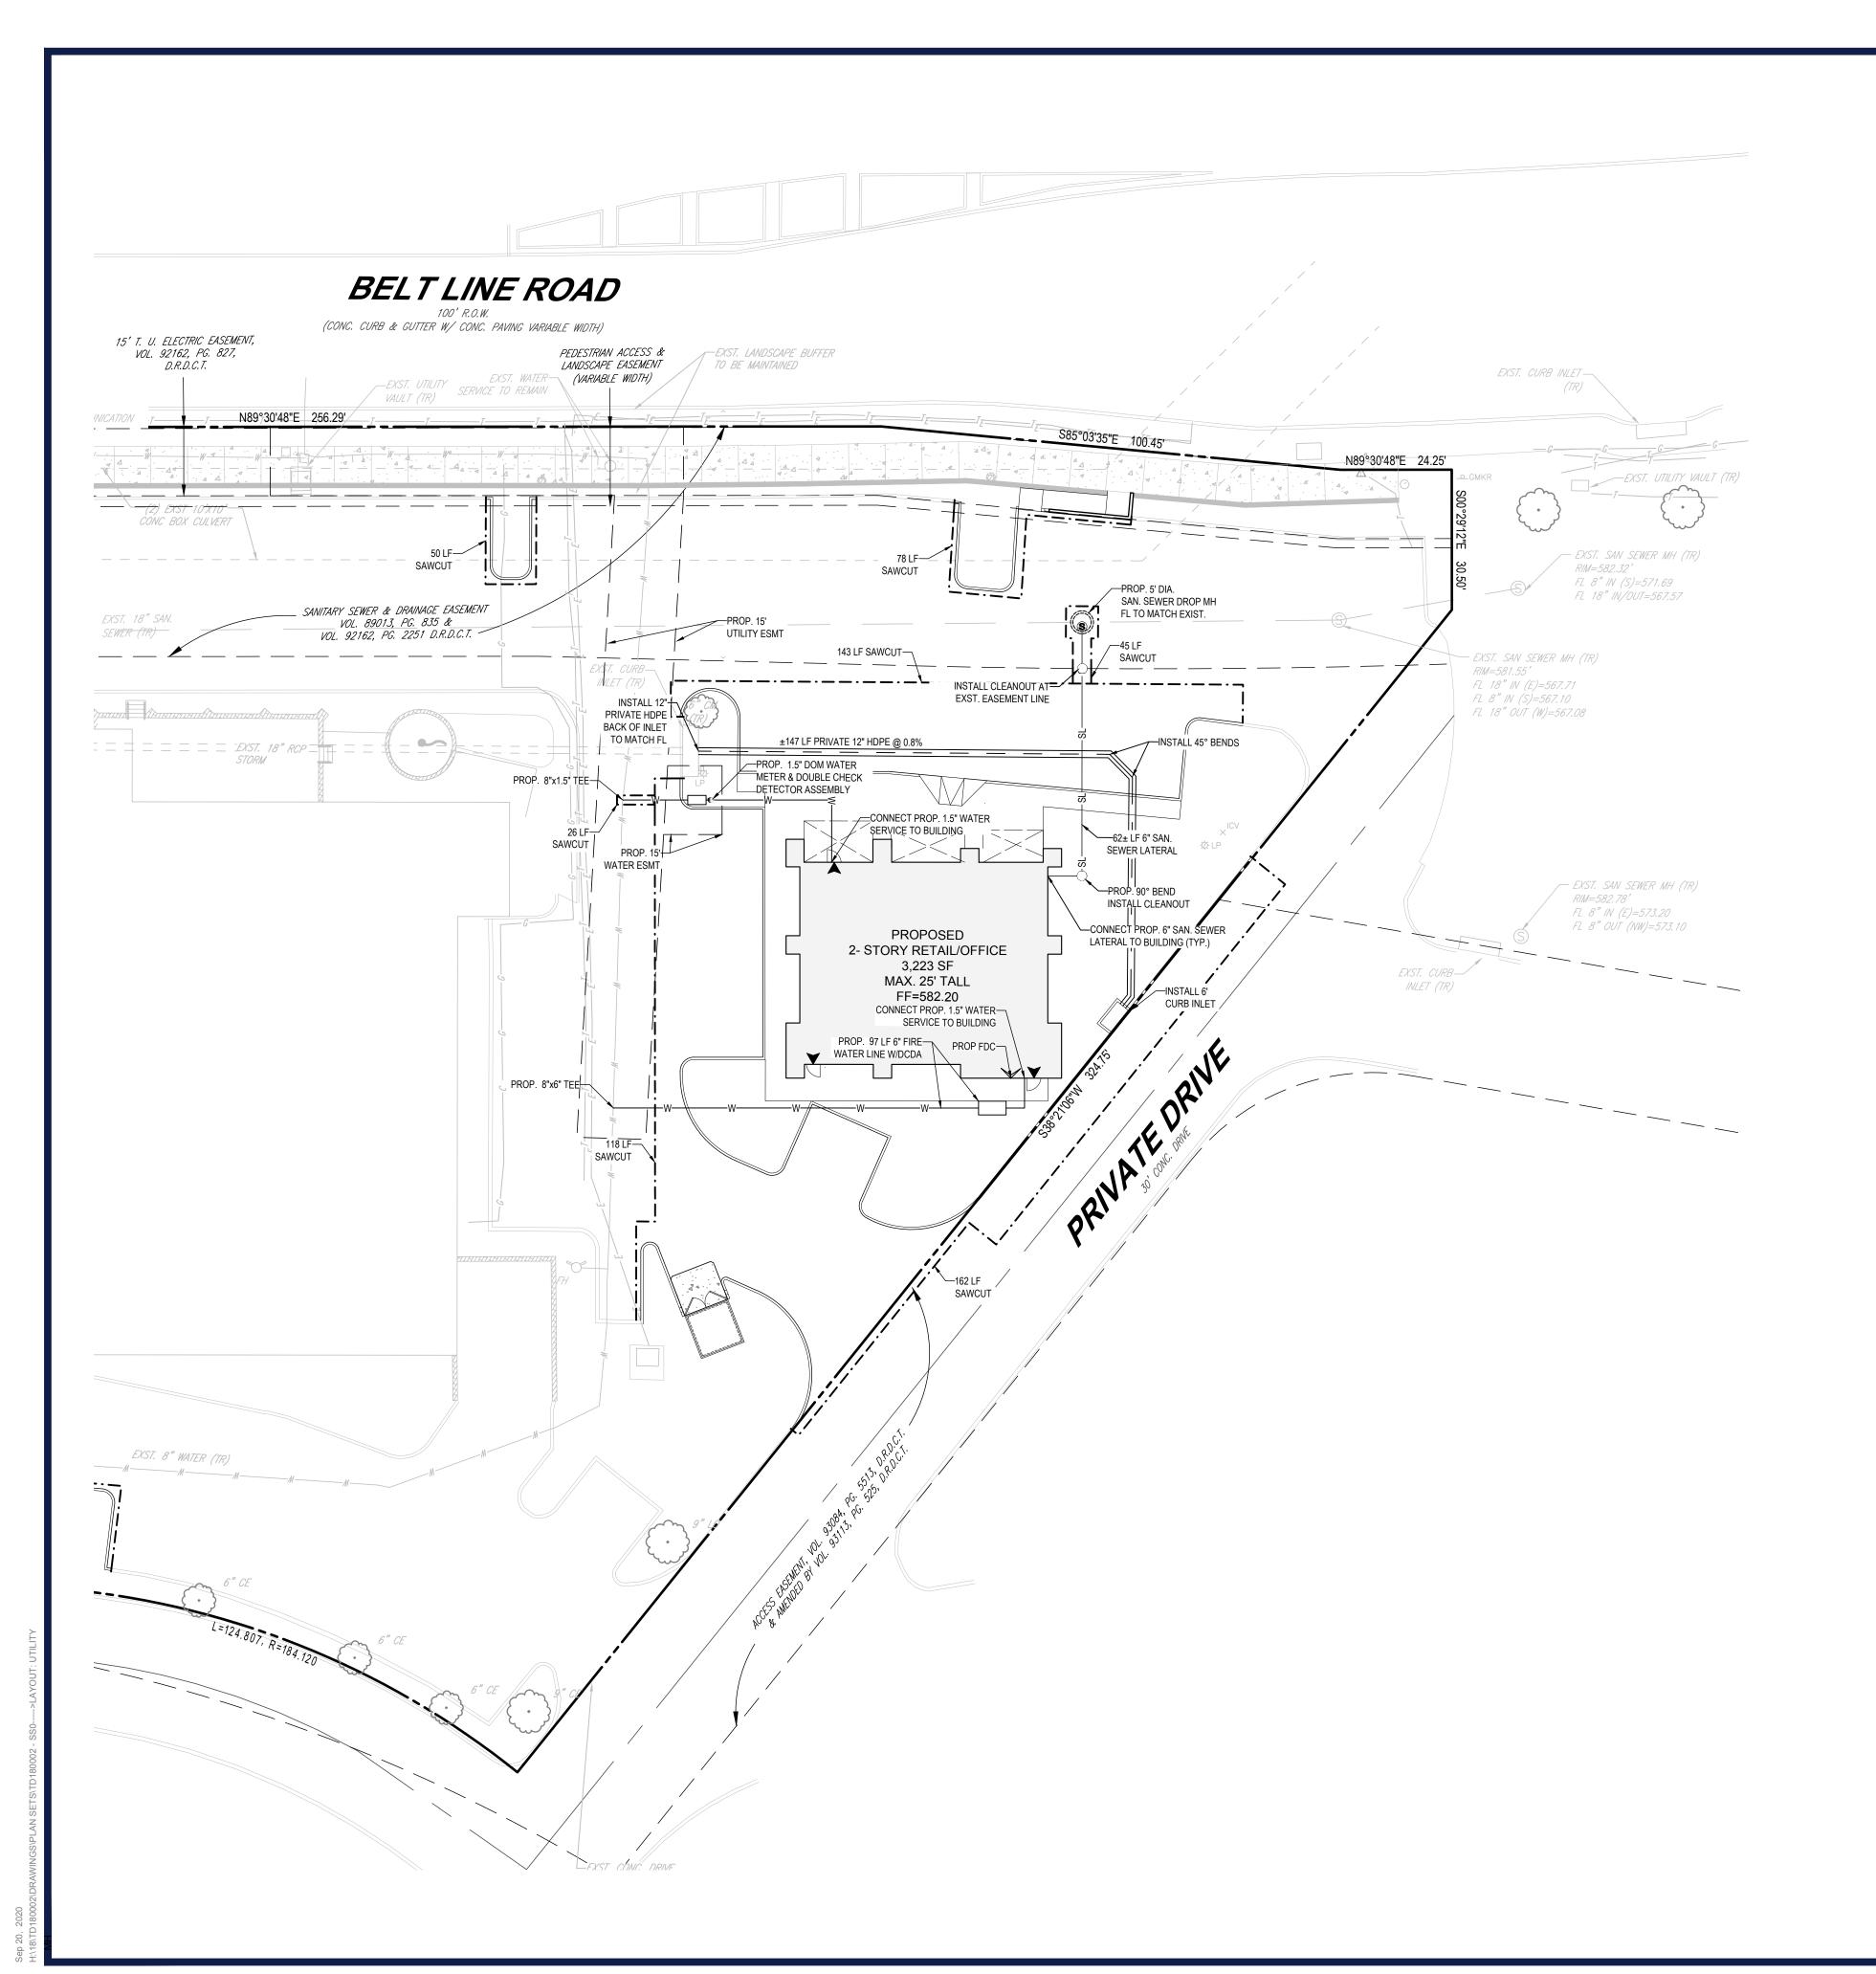

#### LEGEND

	BOUNDARY
5	PROPOSED PARKING COUNT
$\odot$	EXISTING TREE
	EXISTING SHRUB
₩V	EXISTING WATER VALVE
W	EXISTING WATER METER OF SERVICE
$\Theta_{LP}$	EXISTING LIGHT POLE
S	EXISTING SANITARY SEWE
	EXISTING SANITARY SEWE
	EXISTING WATER MAIN
SLSL	PROPOSED SANITARY SEWER LATERAL
	PROPOSED SANITARY SEWER MANHOLE
0	PROPOSED SANITARY SEWER CLEANOUT
	PROPOSED WATER MAIN
~	EXISTING FIRE HYDRANT
•	PROPOSED WATER METER & BACK FLOW PREVENTION ASSEMBLY
^	PROPOSED FIRE DEPARTMENT CONNECTION
TR	TO REMAIN

- 1. CONTRACTOR TO NOTIFY THE ENGINEER IN WRITING SHOULD ANY DISCREPANCIES EXIST.
- 2. CONTRACTOR TO OBTAIN ALL NECESSARY PERMITS AND COORDINATE WITH ADJACENT USERS AND APPROPRIATE JURISDICTIONS FOR ANY ANTICIPATED SERVICE DISRUPTION.
- 3. CONTRACTOR TO PROVIDE NECESSARY FITTINGS TO CONNECT TO BUILDING SERVICE. SEE ARCHITECTURAL AND M.E.P. PLANS FOR FURTHER DETAIL.
- 4. THE CONTRACTOR WILL ENSURE THAT FIRE HYDRANTS ARE ACCESSIBLE TO FIRE TRUCKS
- 5. THE CONTRACTOR SHALL SEQUENCE HIS CONSTRUCTION SUCH THAT NO MORE THAN ONE FIRE HYDRANT IS OUT OF SERVICE AT ANY GIVEN TIME.
- 6. EXISTING UTILITIES ARE SHOWN USING REFERENCED ALTA SURVEY DATA, RECORD PLANS, AND LIMITED FIELD VERIFICATION.
- 7. CONTRACTOR SHALL FIELD VERIFY THE LOCATION OF ALL EXISTING UTILITIES PRIOR TO THE START OF CONSTRUCTION.
- 8. CONTRACTOR IS RESPONSIBLE FOR COORDINATING UTILITY RELOCATIONS WHERE NECESSARY AND PROTECTING EXISTING UTILITIES (SHOWN AND UNSHOWN).
- 9. CONTRACTOR SHALL REPLACE, AT THEIR OWN EXPENSE, ANY EXISTING UTILITIES
- 10. ALL EXISTING WATER SERVICES ARE TO BE CAPPED AND ABANDONED PER TOWN OF ADDISON STANDARDS AND REGULATIONS UNLESS NOTED OTHERWISE.
- 11. ACCORDING TO THE SANITARY SEWER MAP PROVIDED BY THE TOWN OF ADDISON, THIS SITE FALLS WITHIN THE D2 WASTEWATER SERVICE BASIN. IT IS SURROUNDED BY THE D1 SERVICE BASIN ON THE NORTH, THE F SERVICE BASIN ON THE EAST, AND THE D3 SERVICE BASIN ON THE WEST.
- 12. THE NUMBER AND PLACEMENT OF WATER VALVES IS SUBJECT TO CHANGE UPON DETAILED CIVIL PLAN REVIEW. APPROVAL OF THE CONCEPT PLAN DOES NOT LOCK IN
- 13. REFERENCE THE SPAGHETTI WAREHOUSE, INC. AS-BUILT PLAN SET BY JOHN W. BAIRD, JR., DATED 01/12/1993, FOR MORE INFORMATION REGARDING THE EXISTING UTILITIES WITHIN
- 14. THIS PLAN CONFORMS WITH DESIGN STANDARDS INCLUDED IN THE TOWN OF ADDISON TRANSPORTATION PLAN, WATER SYSTEM REQUIREMENTS, WASTEWATER SYSTEM REQUIREMENTS, AND DRAINAGE CRITERIA MANUAL.



#### **REVISIONS**

REV DATE COMMENT



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08/03/2020

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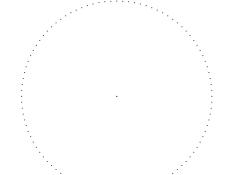
#### SITE **DEVELOPMENT PLANS**

#### **ADDISON RETAIL** LLC

3820 BELT LINE ROAD ADDISON, TX 75001 DALLAS COUNTY THOMAS L CHINOWITH ABST. 273 BLOCK A, LOT 1R, 2.034 AC

### **BOHLER**


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SHEET TITLE:

PRELIMINARY **UTILITY PLAN** 

C-500



#### TREE INVENTORY

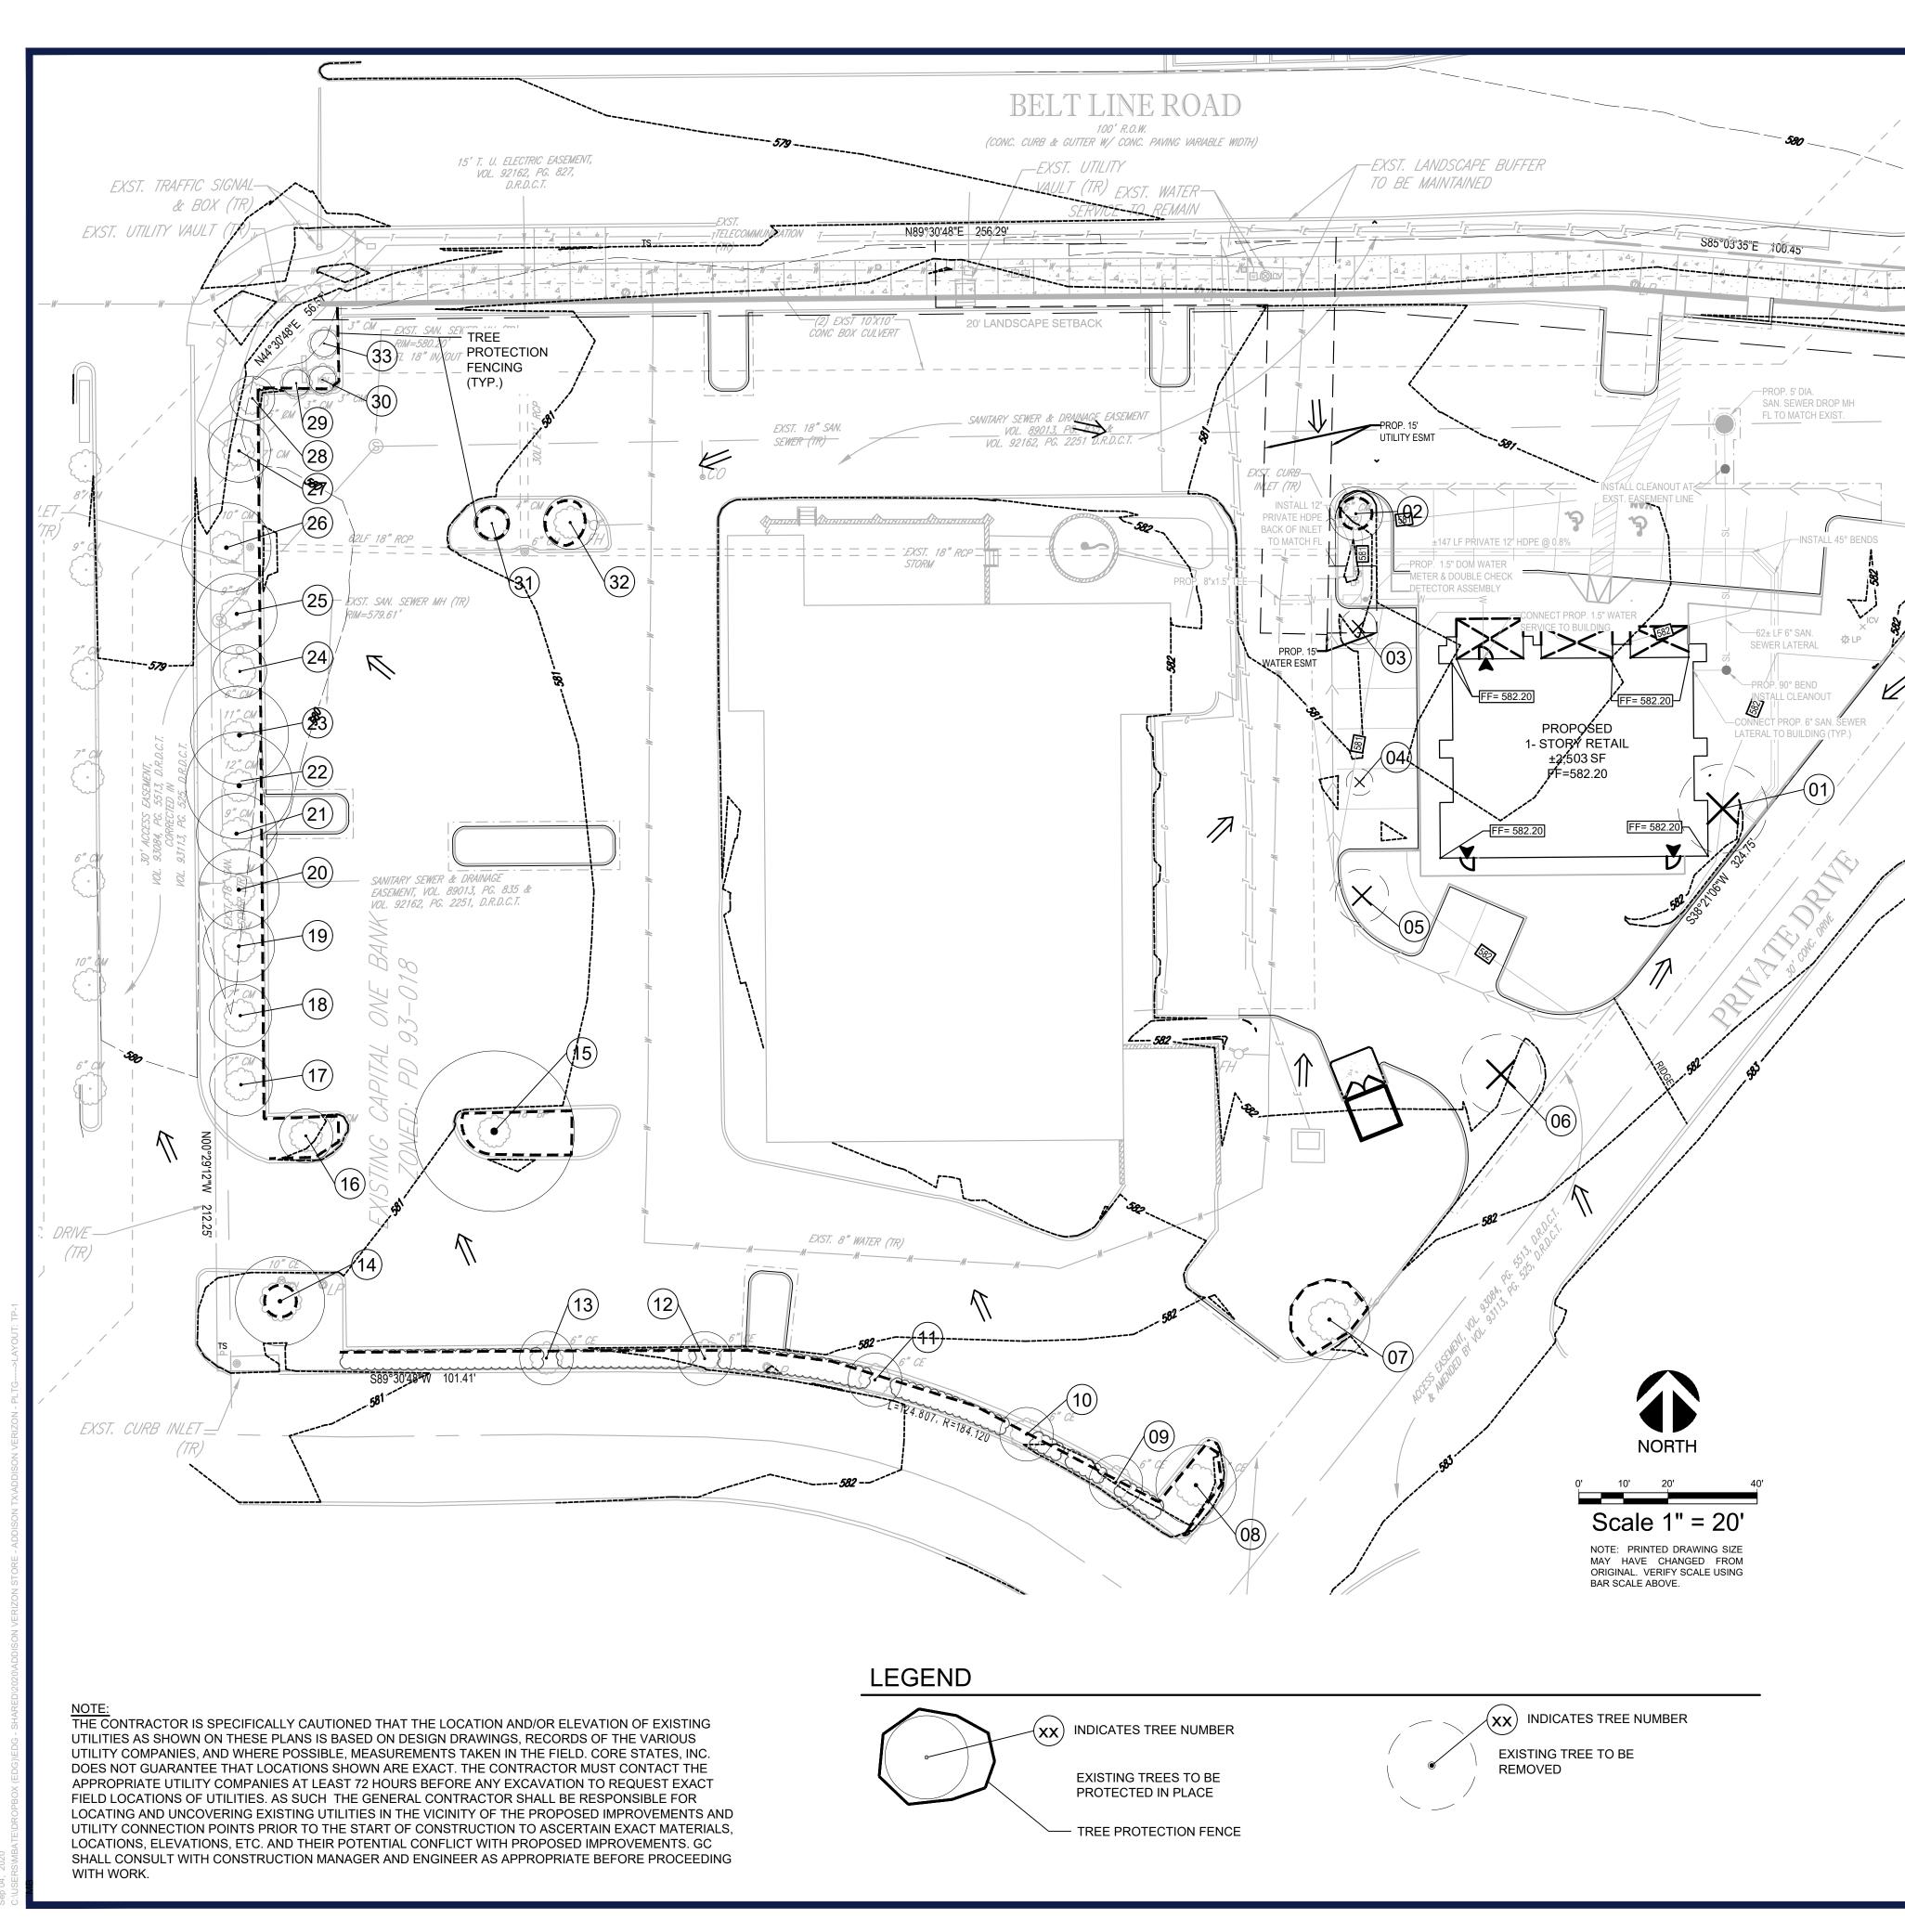EXST. CURB

N89°30'48' E 24.25'

No 1 2 3 4 5 6 7 8 9 10 11 12 13 14	DBH 10 6 4 3 6 9 9 9 6 6 6 C	Type LIVE OAK CREPE MYRTLE CREPE MYRTLE CREPE MYRTLE CREPE MYRTLE LIVE OAK LIVE OAK CEDAR ELM CEDAR ELM	Health GOOD GOOD POOR GOOD GOOD GOOD GOOD	Status REMOVE REMAIN REMOVE REMOVE REMOVE REMOVE REMAIN REMAIN	R.C.I. 10 0 4 3 6 9 0
2 3 4 5 6 7 8 9 10 11 12 13	6 4 3 6 9 9 9 9 6 6 6	CREPE MYRTLE CREPE MYRTLE CREPE MYRTLE CREPE MYRTLE LIVE OAK LIVE OAK CEDAR ELM CEDAR ELM CEDAR ELM	GOOD GOOD GOOD GOOD GOOD GOOD	REMAIN REMOVE REMOVE REMOVE REMOVE REMAIN	0 4 3 6 9
3 4 5 6 7 8 9 10 11 12 13	4 3 6 9 9 9 6 6 6	CREPE MYRTLE CREPE MYRTLE CREPE MYRTLE LIVE OAK LIVE OAK CEDAR ELM CEDAR ELM CEDAR ELM	GOOD POOR GOOD GOOD GOOD GOOD	REMOVE REMOVE REMOVE REMOVE REMAIN	4 3 6 9
4 5 6 7 8 9 10 11 12 13	3 6 9 9 9 6 6 6	CREPE MYRTLE CREPE MYRTLE LIVE OAK LIVE OAK CEDAR ELM CEDAR ELM CEDAR ELM	POOR GOOD GOOD GOOD GOOD	REMOVE REMOVE REMOVE REMAIN	3 6 9 0
5 6 7 8 9 10 11 12 13	6 9 9 9 6 6 6	CREPE MYRTLE LIVE OAK LIVE OAK CEDAR ELM CEDAR ELM CEDAR ELM	GOOD GOOD GOOD GOOD	REMOVE REMOVE REMAIN REMAIN	6 9 0
6 7 8 9 10 11 12 13	9 9 9 6 6 6 C	LIVE OAK LIVE OAK CEDAR ELM CEDAR ELM CEDAR ELM	GOOD GOOD GOOD	REMOVE REMAIN REMAIN	9
7 8 9 10 11 12 13	9 9 6 6 6 C	LIVE OAK CEDAR ELM CEDAR ELM CEDAR ELM	GOOD GOOD	REMAIN REMAIN	0
8 9 10 11 12 13	9 6 6 6 C	CEDAR ELM CEDAR ELM CEDAR ELM	GOOD GOOD	REMAIN	
9 10 11 12 13	6 6 6 C	CEDAR ELM CEDAR ELM	GOOD		0
10 11 12 13	6 6 C	CEDAR ELM		REMAIN	U
11 12 13	6 C		CO 00		0
12 13	С	CEDAR FIA	GOOD	REMAIN	0
13		CEDAR ELM	GOOD	REMAIN	0
		CEDAR ELM	GOOD	REMAIN	0
14	10	CEDAR ELM	GOOD	REMAIN	0
17	4	CEDAR ELM	FAIR	REMAIN	0
15	8	BRADFORD PEAR	FAR	REMAIN	0
16	6	CREPE MYRTLE	GOOD	REMAIN	0
17	7	CREPE MYRTLE	GOOD	REMAIN	0
18	7	CREPE MYRTLE	GOOD	REMAIN	0
19	8	CREPE MYRTLE	GOOD	REMAIN	0
20	9	CREPE MYRTLE	GOOD	REMAIN	0
21	12	CREPE MYRTLE	GOOD	REMAIN	0
22	11	CREPE MYRTLE	GOOD	REMAIN	0
23	11	CREPE MYRTLE	GOOD	REMAIN	0
24	6	CREPE MYRTLE	GOOD	REMAIN	0
25	9	CREPE MYRTLE	GOOD	REMAIN	0
26	10	CREPE MYRTLE	GOOD	REMAIN	0
27	7	CREPE MYRTLE	GOOD	REMAIN	0
28	5	CREPE MYRTLE	GOOD	REMAIN	0
29	3	CREPE MYRTLE	GOOD	REMAIN	0
30	3	CREPE MYRTLE	GOOD	REMAIN	0
31	4	CREPE MYRTLE	GOOD	REMAIN	0
32	6	CREPE MYRTLE	GOOD	REMAIN	0
33	3	CREPE MYRTLE	GOOD	REMAIN	0
		TOTAL CALIPER REP	LACEMENT	INCHES	32

R.C.I. = REPLACEMENT CALIPER INCHES

TOTAL NUMBER OF TREES TOTAL NUMBER OF TREES REMOVED TOTAL CALIPER INCHES OF REMOVED TREES TOTAL CALIPER INCHES TO MITIGATE	33
TOTAL NUMBER OF TREES REMOVED	5
TOTAL CALIPER INCHES OF REMOVED TREES	32"
TOTAL CALIPER INCHES TO MITIGATE	32"

#### TREE PROTECTION GENERAL NOTES

- (A) PRIOR TO THE LAND CLEARING STAGE OF DEVELOPMENT, THE CONTRACTOR SHALL CLEARLY MARK ALL PROTECTED TREES FOR WHICH A TREE REMOVAL PERMIT HAS NOT BEEN ISSUED AND SHALL ERECT BARRIERS FOR THE PROTECTION OF THE TREES ACCORDING TO THE FOLLOWING:

  (1) AROUND AN AREA AT OR GREATER THAN TWO-THIRDS OF THE DRIPLINE OF ALL PROTECTED
- (B) NO PERSON SHALL ATTACH ANY SIGN, NOTICE OR OTHER OBJECT TO ANY PROTECTED TREE OR FASTEN ANY WIRES, CABLES, NAILS OR SCREWS TO ANY PROTECTED TREE IN ANY MANNER THAT COULD PROVE HARMFUL TO THE PROTECTED TREE, EXCEPT AS NECESSARY IN CONJUNCTION WITH ACTIVITIES IN THE PUBLIC INTEREST.
- (C) DURING THE CONSTRUCTION STAGE OF DEVELOPMENT, THE CONTRACTOR SHALL NOT CAUSE OR PERMIT THE CLEANING OF EQUIPMENT OR MATERIAL WITHIN THE OUTSIDE PERIMETER OF THE CROWN (DRIPLINE) OR ON THE NEARBY GROUND OF ANY TREE OR GROUP OF TREES WHICH IS TO BE PRESERVED. WITHIN THE OUTSIDE PERIMETER OF THE CROWN (DRIPLINE) OF ANY TREE OR ON NEARBY GROUND, THE CONTRACTOR SHALL NOT CAUSE OR PERMIT STORAGE OF BUILDING MATERIAL AND/OR EQUIPMENT, OR DISPOSAL OF WASTE MATERIAL SUCH AS PAINTS, OIL, SOLVENTS, ASPHALT, CONCRETE, MORTAR OR ANY OTHER MATERIAL HARMFUL TO THE LIFE OF THE TREE.
- (D) NO PERSON SHALL PERMIT ANY UNNECESSARY FIRE OR BURNING WITHIN 30 FEET OF THE DRIPLINE OF A PROTECTED TREE.
   (E) ANY LANDSCAPING ACTIVITIES WITHIN THE BARRIER AREA SHALL BE ACCOMPLISHED WITH HAND
- (F) PRIOR TO ISSUING A CERTIFICATE OF OCCUPANCY OR COMPLIANCE FOR ANY DEVELOPMENT, BUILDING OR STRUCTURE, ALL TREES DESIGNATED TO BE PRESERVED THAT WERE DESTROYED DURING CONSTRUCTION SHALL BE REPLACED BY THE CONTRACTOR WITH TREES OF EQUIVALENT DIAMETER AT BREAST HEIGHT TREE CALIPER AND OF THE SAME SPECIES AS SPECIFIED BY THE DIRECTOR OF PARKS OR THE DIRECTOR'S DESIGNEE, BEFORE OCCUPANCY OR USE, UNLESS APPROVAL FOR THEIR REMOVAL HAS BEEN GRANTED UNDER PERMIT.
- (G) THE DIRECTOR OF PARKS OR THE DIRECTOR'S DESIGNEE MAY CONDUCT PERIODIC INSPECTIONS OF THE SITE DURING LAND CLEARANCE AND CONSTRUCTION.
- (H) IF, IN THE OPINION OF THE DIRECTOR OF PARKS OR THE DIRECTOR'S DESIGNEE, DEVELOPMENT ACTIVITIES WILL SO SEVERELY STRESS SLASH PINES OR ANY OTHER PROTECTED TREE SUCH THAT THEY ARE MADE SUSCEPTIBLE TO INSECT ATTACK, PREVENTATIVE SPRAYING OF THESE TREES BY THE CONTRACTOR MAY BE REQUIRED.

ENGINEER
BOHLER ENGINEERING
6017 MAIN STREET
FRISCO, TX 75034
PH# 469-458-7300

PH# 800-680-6630

LABOR.

CONTACT: MATHIAS HAUBERT

LANDSCAPE ARCHITECT
EVERGREEN DESIGN GROUP
15305 DALLAS PKWY, STE 300
ADDISON, TX 75001

CONTACT: RODNEY MCNABB

83 ORCHARD HILL PARK DR. LEOMINSTER, MA 04153 PH# 978-466-6661 CONTACT: GREGG LISCIOTTI SURVEYOR

OWNER/APPLICANT

ADDISON RETAIL, LLC

AXIS SURVEYING
714 FERRIS AVE B
WAXAHACHIE, TX 75168
PH# 214-903-8200
CONTACT: SEAN SHROPSHIRE





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 PROJECT No.:
 TD180002

 DRAWN BY:
 MNB

 CHECKED BY:
 KB/RM

 DATE:
 08/28/2020

 CAD I.D.:
 1"= 20'

PROJECT:

#### SITE DEVELOPMENT PLANS

FOR —

#### ADDISON RETAIL LLC

3820 BELT LINE ROAD
ADDISON, TX 75001
DALLAS COUNTY
THOMAS L CHINOWITH ABST. 273
BLOCK A, LOT 1R, 2.034 AC

## BOHLER/

6017 MAIN STREET FRISCO, TX 75034 Phone: (469) 458-7300 **TX@BohlerEng.com** TBPE No. 18065 | TBPLS No. 10194413




09/04/2020

SHEET TITLE:

TREE PRESERVATION

SHEET NUMBER:

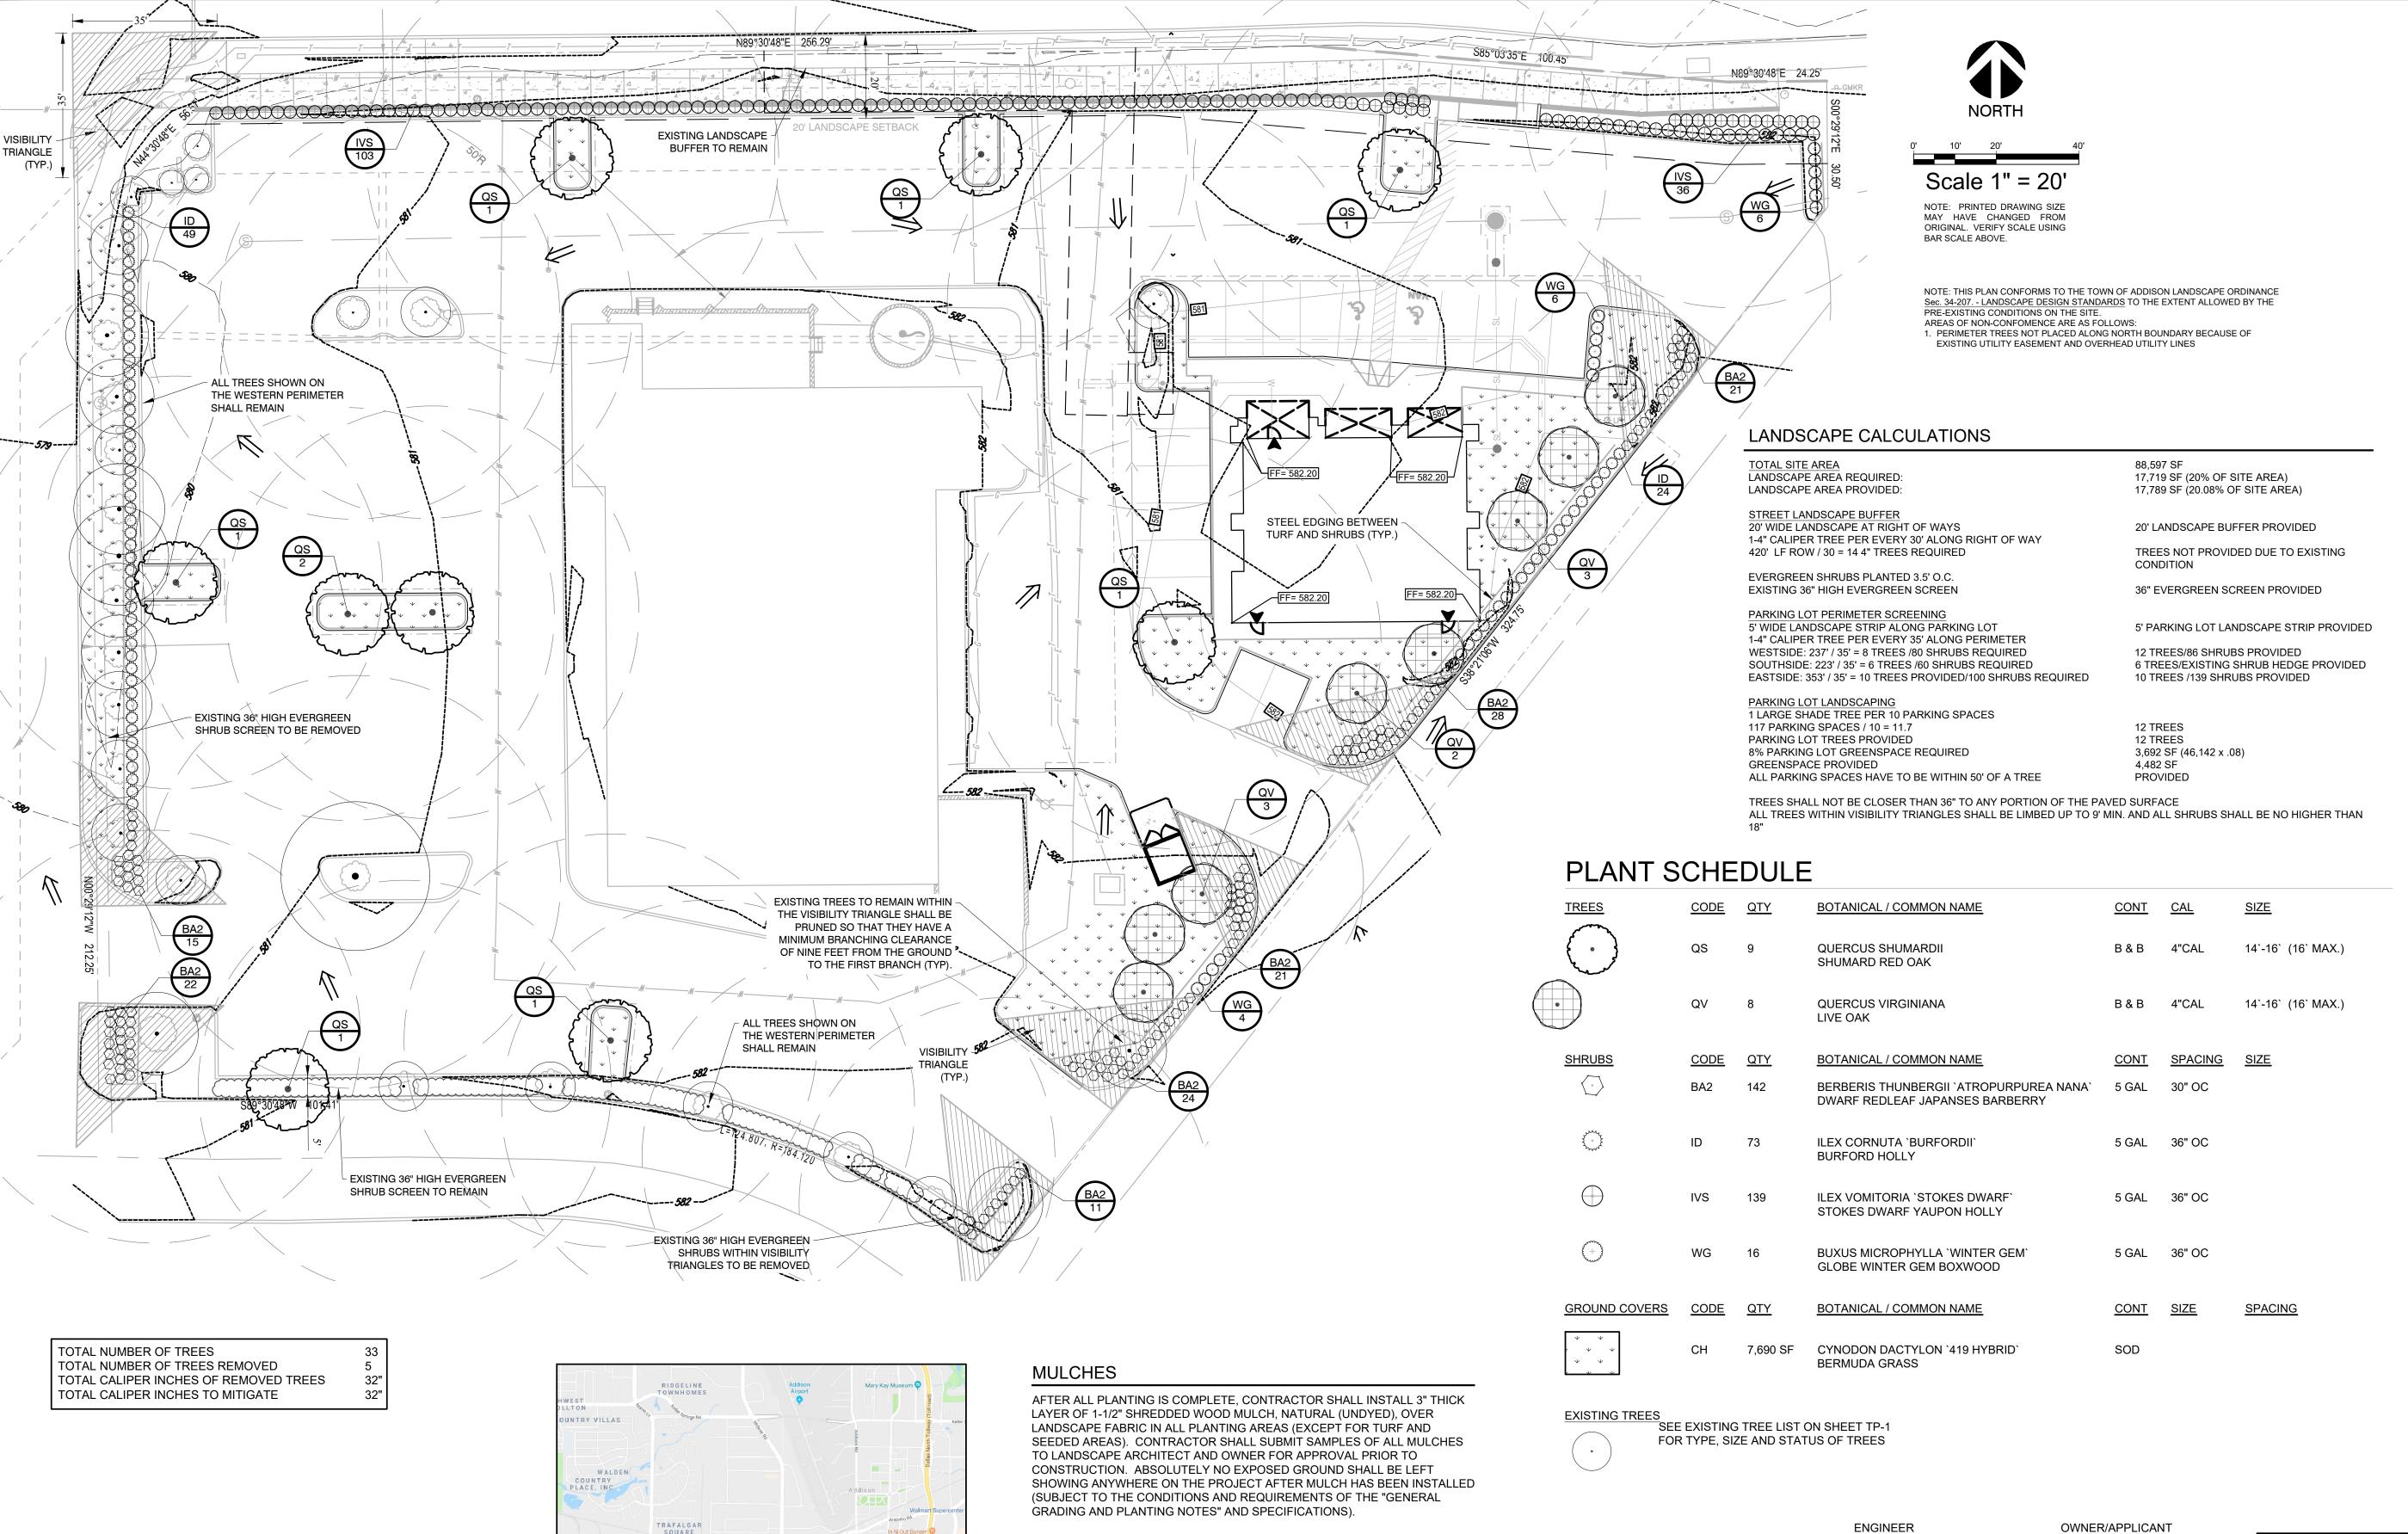

ROOT BARRIERS

ENCIRCLE THE ROOTBALL.

**VICINITY MAP** 

THE CONTRACTOR IS SPECIFICALLY CAUTIONED THAT THE LOCATION AND/OR ELEVATION OF EXISTING

UTILITIES AS SHOWN ON THESE PLANS IS BASED ON DESIGN DRAWINGS, RECORDS OF THE VARIOUS

UTILITY COMPANIES, AND WHERE POSSIBLE, MEASUREMENTS TAKEN IN THE FIELD. CORE STATES, INC. DOES NOT GUARANTEE THAT LOCATIONS SHOWN ARE EXACT. THE CONTRACTOR MUST CONTACT THE

APPROPRIATE UTILITY COMPANIES AT LEAST 72 HOURS BEFORE ANY EXCAVATION TO REQUEST

EXACT FIELD LOCATIONS OF UTILITIES. AS SUCH THE GENERAL CONTRACTOR SHALL BE

PROPOSED IMPROVEMENTS AND UTILITY CONNECTION POINTS PRIOR TO THE START OF

MANAGER AND ENGINEER AS APPROPRIATE BEFORE PROCEEDING WITH WORK.

RESPONSIBLE FOR LOCATING AND UNCOVERING EXISTING UTILITIES IN THE VICINITY OF THE

CONSTRUCTION TO ASCERTAIN EXACT MATERIALS, LOCATIONS, ELEVATIONS, ETC. AND THEIR

POTENTIAL CONFLICT WITH PROPOSED IMPROVEMENTS. GC SHALL CONSULT WITH CONSTRUCTION

THE CONTRACTOR SHALL INSTALL ROOT BARRIERS NEAR ALL

RECOMMENDATIONS. UNDER NO CIRCUMSTANCES SHALL THE

CONTRACTOR USE ROOT BARRIERS OF A TYPE THAT COMPLETELY

NEWLY-PLANTED TREES THAT ARE LOCATED WITHIN FIVE (5) FEET OF

ADJACENT TO HARDSCAPE. INSTALL PANELS PER MANUFACTURER'S

PAVING OR CURBS. ROOT BARRIERS SHALL BE "CENTURY" OR "DEEP-ROOT"

24" DEEP PANELS (OR EQUAL). BARRIERS SHALL BE LOCATED IMMEDIATELY

(800) 680-6630 15305 Dallas Pkwy., Ste 300 Addison, TX 75001

EVERGREEN www.EvergreenDesignGroup.com

BOHLER ENGINEERING

CONTACT: MATHIAS HAUBERT

**EVERGREEN DESIGN GROUP** 

CONTACT: RODNEY MCNABB

15305 DALLAS PKWY, STE 300

LANDSCAPE ARCHITECT

6017 MAIN STREET

FRISCO, TX 75034

PH# 469-458-7300

ADDISON, TX 75001

PH# 800-680-6630

ADDISON RETAIL, LLC

LEOMINSTER, MA 04153

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WAXAHACHIE, TX 75168

CONTACT: SEAN SHROPSHIRE

SURVEYOR

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SITE **DEVELOPMENT** 

**PLANS** 

**ADDISON** RETAIL

LLC

3820 BELT LINE ROAD

ADDISON, TX 75001

DALLAS COUNTY THOMAS L CHINOWITH ABST. 273 BLOCK A, LOT 1R, 2.034 AC

**BOHLER** 

6017 MAIN STREET

FRISCO, TX 75034

Phone: (469) 458-7300

TX@BohlerEng.com TBPE No. 18065 | TBPLS No. 10194413

09/04/2020

LANDSCAPE

**PLANTING** 

08/28/2020

COMMENT


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PROJECT No.: DRAWN BY:

**CHECKED BY:** 

CAD I.D.:


PROJECT:

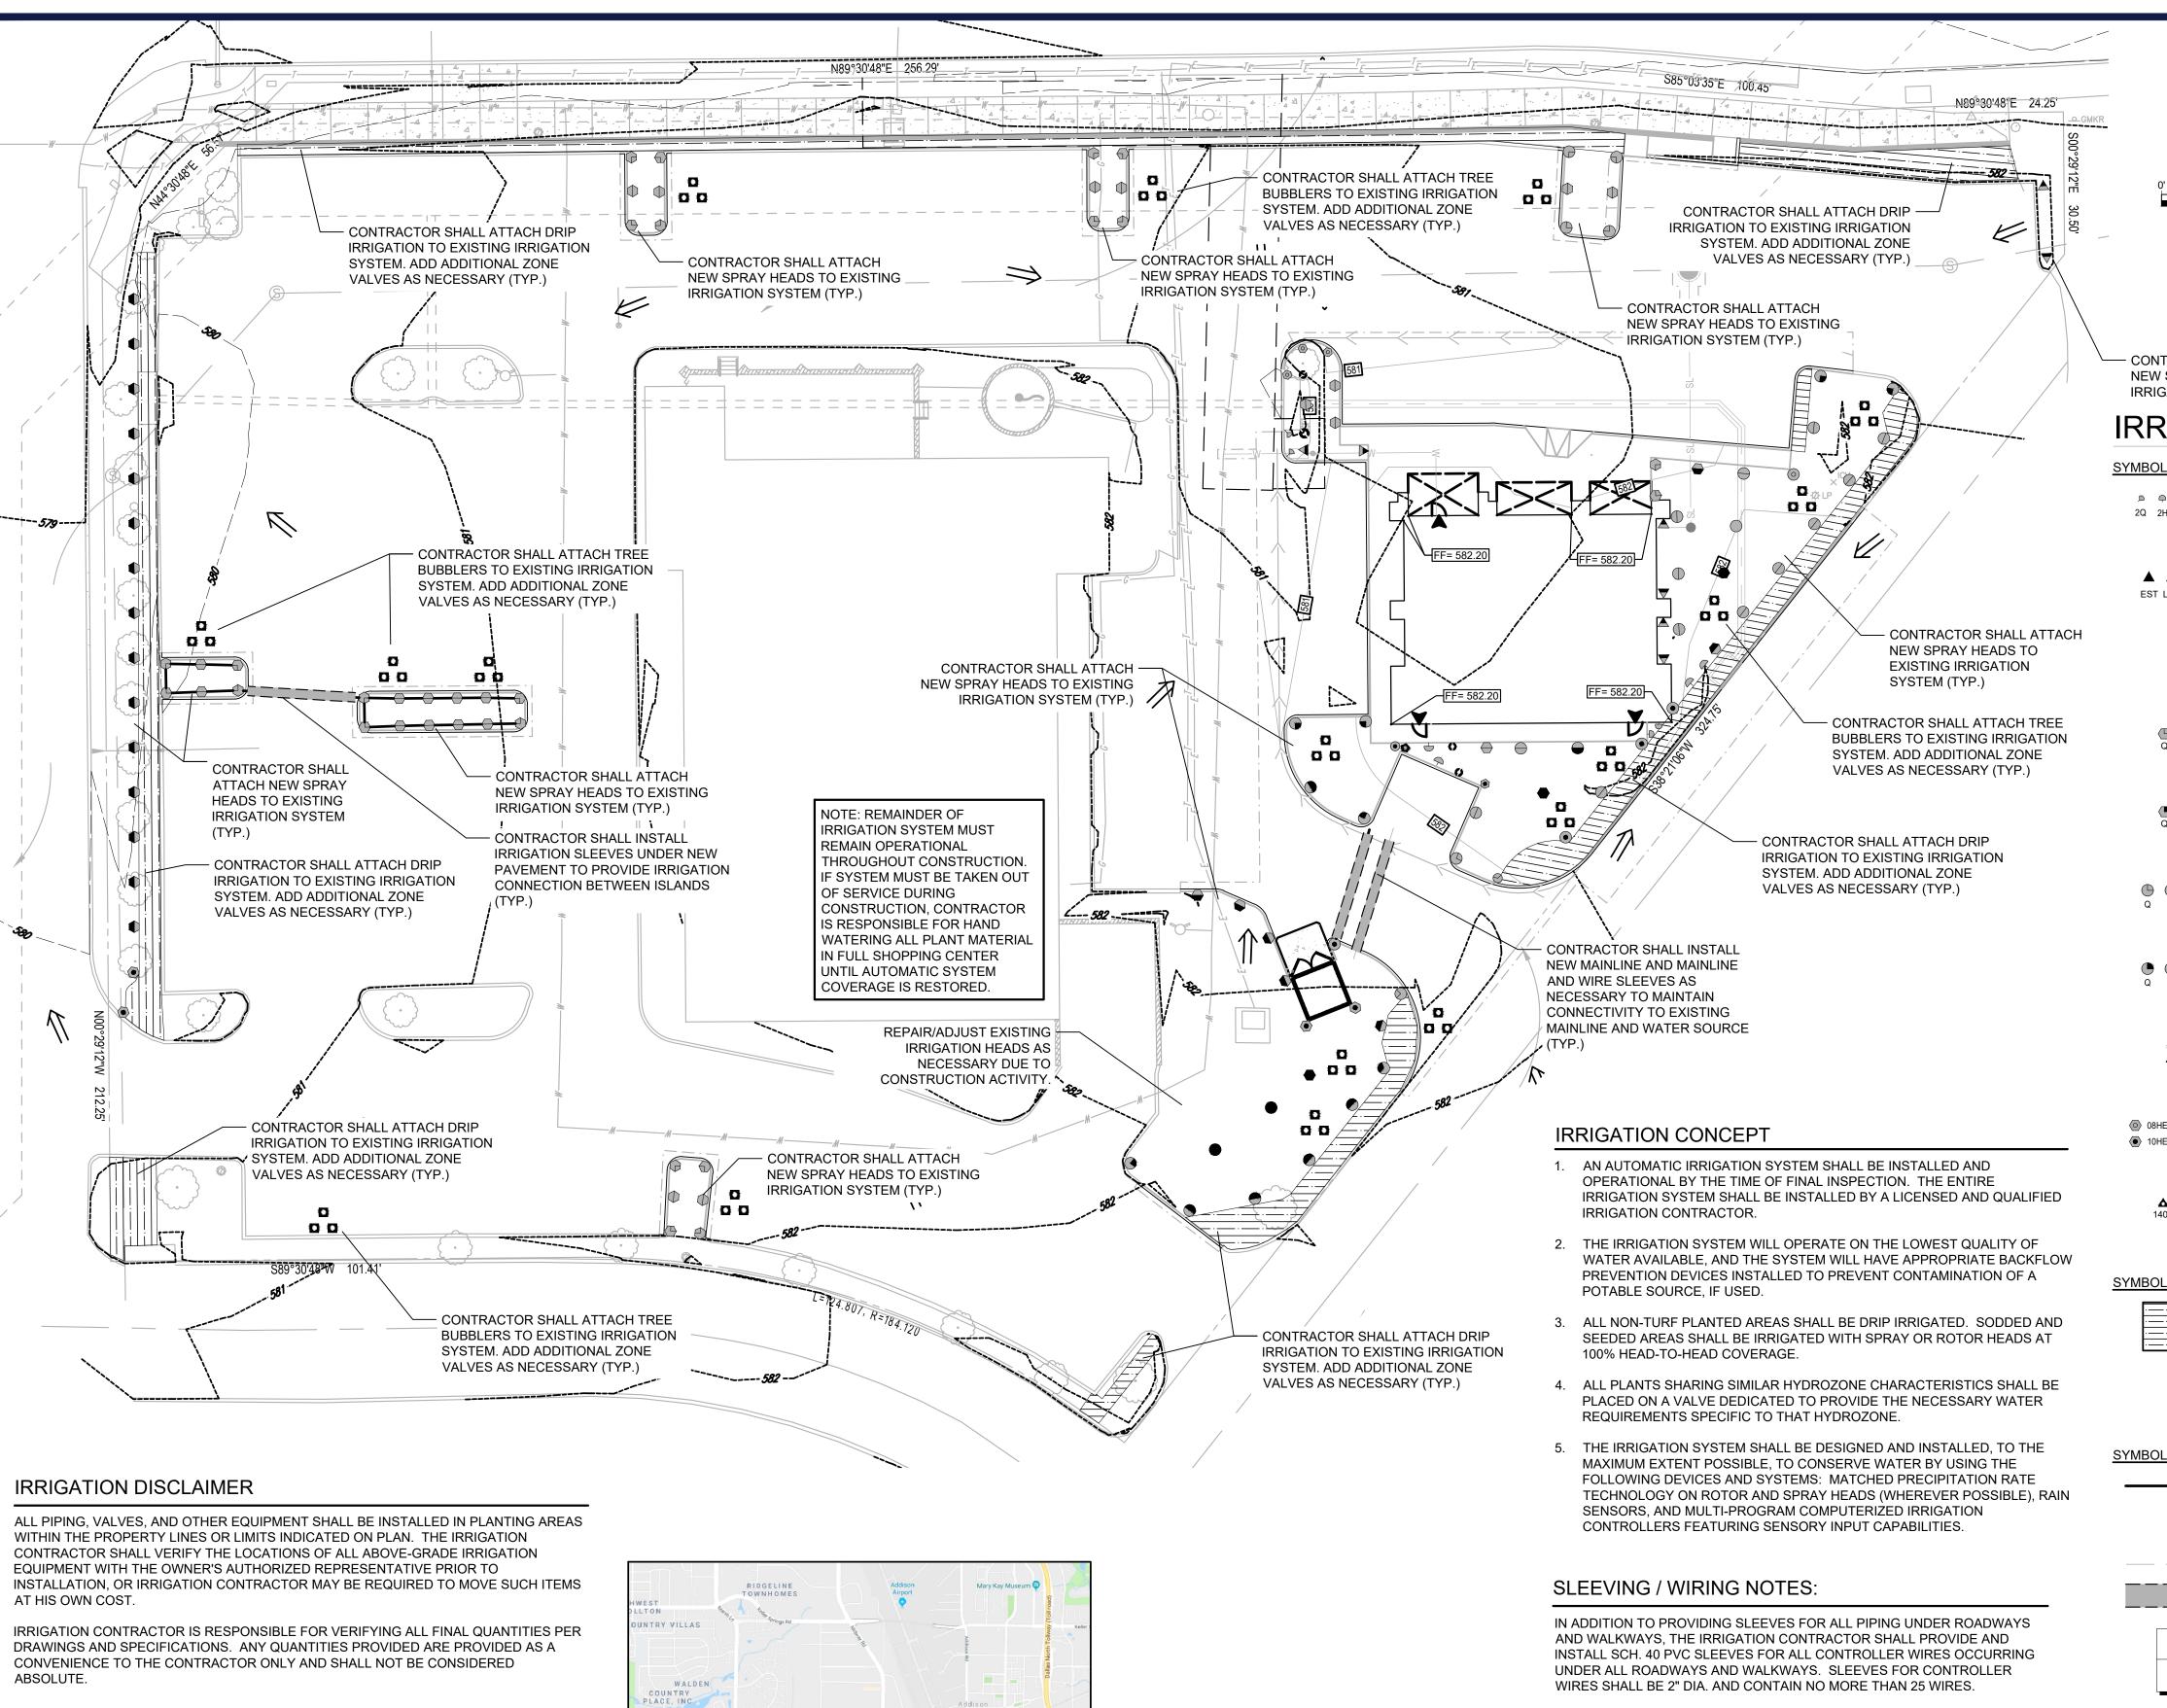

#### IRRIGATION WATER SOURCE

EXISTING WATER SOURCE TO BE USED FOR LANDSCAPE IRRIGATION.

THE CONTRACTOR IS SPECIFICALLY CAUTIONED THAT THE LOCATION AND/OR ELEVATION OF EXISTING UTILITIES AS SHOWN ON THESE PLANS IS BASED ON DESIGN DRAWINGS, RECORDS OF THE VARIOUS UTILITY COMPANIES, AND WHERE POSSIBLE, MEASUREMENTS TAKEN IN THE FIELD. CORE STATES, INC. DOES NOT GUARANTEE THAT LOCATIONS SHOWN ARE EXACT. THE CONTRACTOR MUST CONTACT THE APPROPRIATE UTILITY COMPANIES AT LEAST 72 HOURS BEFORE ANY EXCAVATION TO REQUEST EXACT FIELD LOCATIONS OF UTILITIES. AS SUCH THE GENERAL CONTRACTOR SHALL BE RESPONSIBLE FOR LOCATING AND UNCOVERING EXISTING UTILITIES IN THE VICINITY OF THE PROPOSED IMPROVEMENTS AND UTILITY CONNECTION POINTS PRIOR TO THE START OF CONSTRUCTION TO ASCERTAIN EXACT MATERIALS, LOCATIONS, ELEVATIONS, ETC. AND THEIR POTENTIAL CONFLICT WITH PROPOSED IMPROVEMENTS. GC SHALL CONSULT WITH CONSTRUCTION MANAGER AND ENGINEER AS APPROPRIATE BEFORE PROCEEDING WITH WORK.

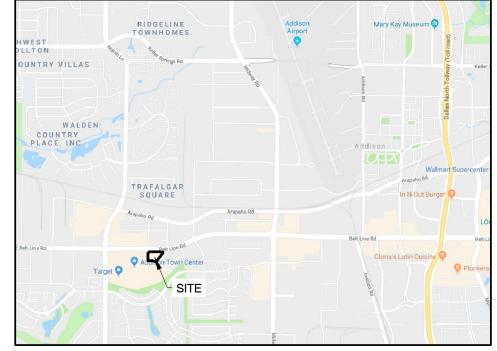

**VICINITY MAP** 



N.T.S.



Scale 1" = 20'

NOTE: PRINTED DRAWING SIZE MAY HAVE CHANGED FROM ORIGINAL. VERIFY SCALE USING BAR SCALE ABOVE.

A FULLY FUNCTIONAL AUTOMATED IRRIGATION SYSTEM. THAT HAS HEAD TO HEAD COVERAGE AND INCLUDE RAIN FREEZE SENSORS IS REQUIRED FOR THE FULL SITE. CONTRACTOR TO ENSURE THAT THE REMAINING AREAS NOT AFFECTED BY CONSTRUCTION ARE OPERATIONAL, PROVIDE HEAD TO HEAD COVERAGE AND THAT THE RAIN FREEZE SENSOR IS CONNECTED AND OPERATIONAL.

<u>PSI</u>

- CONTRACTOR SHALL ATTACH NEW SPRAY HEADS TO EXISTING IRRIGATION SYSTEM (TYP.)

#### IRRIGATION SCHEDULE

₽ ₽ ⊕ № <b>⊕</b> 2Q 2H 2F 4Q 4H 4F	RAIN BIRD 1806-PRS SQ SERIES TURF SPRAY 6.0" POP-UP SPRINKLER WITH CO-MOLDED WIPER SEAL. SIDE AND BOTTOM INLET. 1/2" NPT FEMALE THREADED INLET. PRESSURE REGULATING.	30
EST LCS RCS CST SST	RAIN BIRD 1806-PRS 15 STRIP SERIES TURF SPRAY 6.0" POP-UP SPRINKLER WITH CO-MOLDED WIPER SEAL. SIDE AND BOTTOM INLET. 1/2" NPT FEMALE THREADED INLET. PRESSURE REGULATING.	30
<i>P</i>	RAIN BIRD 1806-PRS 5 SERIES MPR TURF SPRAY 6.0" POP-UP SPRINKLER WITH CO-MOLDED WIPER SEAL. SIDE AND BOTTOM INLET. 1/2" NPT FEMALE THREADED INLET. PRESSURE REGULATING.	30
Q T H F	RAIN BIRD 1806-PRS 8 SERIES MPR TURF SPRAY 6.0" POP-UP SPRINKLER WITH CO-MOLDED WIPER SEAL. SIDE AND BOTTOM INLET. 1/2" NPT FEMALE THREADED INLET. PRESSURE REGULATING.	30
Q T H F	RAIN BIRD 1806-PRS 10 SERIES MPR TURF SPRAY 6.0" POP-UP SPRINKLER WITH CO-MOLDED WIPER SEAL. SIDE AND BOTTOM INLET. 1/2" NPT FEMALE THREADED INLET. PRESSURE REGULATING.	30
Q T H TQ F	RAIN BIRD 1806-PRS 12 SERIES MPR TURF SPRAY 6.0" POP-UP SPRINKLER WITH CO-MOLDED WIPER SEAL. SIDE AND BOTTOM INLET. 1/2" NPT FEMALE THREADED INLET. PRESSURE REGULATING.	30
Q T H TQ F	RAIN BIRD 1806-PRS 15 SERIES MPR TURF SPRAY 6.0" POP-UP SPRINKLER WITH CO-MOLDED WIPER SEAL. SIDE AND BOTTOM INLET. 1/2" NPT FEMALE THREADED INLET. PRESSURE REGULATING.	30
	RAIN BIRD 1806-PRS ADJ TURF SPRAY 6.0" POP-UP SPRINKLER WITH CO-MOLDED WIPER SEAL. SIDE AND BOTTOM INLET. 1/2" NPT FEMALE THREADED INLET. PRESSURE REGULATING.	30
<ul> <li>○ 08HE-VAN</li> <li>○ 12HE-VAN</li> <li>○ 15HE-VAN</li> </ul>	RAIN BIRD 1806-PRS HE-VAN SERIES TURF SPRAY 6.0" POP-UP SPRINKLER WITH CO-MOLDED WIPER SEAL. SIDE AND BOTTOM INLET. 1/2" NPT FEMALE THREADED INLET. PRESSURE REGULATING.	30
1402 1408 1401 1404	RAIN BIRD 1806-PRS-1400 FLOOD FLOOD BUBBLER 6.0" POPUP WITH PRESSURE REGULATING DEVICE.	30
SYMBOL	MANUFACTURER/MODEL/DESCRIPTION	

MANUFACTURER/MODEL/DESCRIPTION

#### MANUFACTURER/MODEL/DESCRIPTION


AREA TO RECEIVE DRIPLINE RAIN BIRD XFS-06-18 XFS SUB-SURFACE PRESSURE COMPENSATING DRIPLINE W/COPPER SHIELD TECHNOLOGY. 0.6 GPH EMITTERS AT 18" O.C. LATERALS SPACED AT 18" APART, WITH EMITTERS OFFSET FOR TRIANGULAR PATTERN. UV RESISTANT. SPECIFY XF INSERT FITTINGS.

### MANUFACTURER/MODEL/DESCRIPTION

IRRIGATION LATERAL LINE: PVC CLASS 200 SDR 21 PVC CLASS 200 IRRIGATION PIPE. ONLY LATERAL TRANSITION PIPE SIZES 1" AND ABOVE ARE INDICATED ON THE PLAN, WITH ALL OTHERS BEING 3/4" IN SIZE.

#### IRRIGATION MAINLINE: PVC SCHEDULE 40

### PIPE SLEEVE: PVC SCHEDULE 40

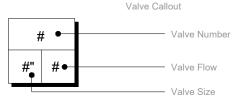

**ENGINEER** BOHLER ENGINEERING 6017 MAIN STREET FRISCO, TX 75034 PH# 469-458-7300

CONTROLLER NOTE

ORDER SHALL MATCH PLANS.

VERIFY EXISTING LOCATION OF CONTROLLER, OR NEW LOCATION (IF

IRRIGATION CONTRACTOR'S SCOPE OF WORK, AND SHALL BE PROVIDED BY

OTHERS. HOOK-UP OF CONTROLLER TO 120 VAC SHALL BE PERFORMED BY

APPLICABLE), IN FIELD WITH OWNER'S REPRESENTATIVE.

120 VAC POWER TO CONTROLLER LOCATION IS NOT WITHIN THE

THE LANDSCAPE CONTRACTOR. IRRIGATION CONTRACTOR SHALL

COORDINATE LOCATION OF WIRE SLEEVE PENETRATIONS THROUGH

BUILDING WITH OWNER AND GENERAL CONTRACTOR. STATION RUN

**CONTACT: MATHIAS HAUBERT** LANDSCAPE ARCHITECT **EVERGREEN DESIGN GROUP** 

**AXIS SURVEYING** 15305 DALLAS PKWY, STE 300 714 FERRIS AVE B ADDISON, TX 75001 PH# 800-680-6630 PH# 214-903-8200 CONTACT: RODNEY MCNABB

OWNER/APPLICANT ADDISON RETAIL, LLC 83 ORCHARD HILL PARK DR. LEOMINSTER, MA 04153 PH# 978-466-6661 CONTACT: GREGG LISCIOTTI

SURVEYOR WAXAHACHIE, TX 75168 CONTACT: SEAN SHROPSHIRE





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#### SITE **DEVELOPMENT PLANS**

### **ADDISON** RETAIL

LLC

3820 BELT LINE ROAD ADDISON, TX 75001 DALLAS COUNTY THOMAS L CHINOWITH ABST. 273 BLOCK A, LOT 1R, 2.034 AC

## **BOHLER**


**6017 MAIN STREET** FRISCO, TX 75034 Phone: (469) 458-7300 TX@BohlerEng.com TBPE No. 18065 | TBPLS No. 10194413



09/04/2020

SHEET TITLE: LANDSCAPE **IRRIGATION** 

SHEET NUMBER:

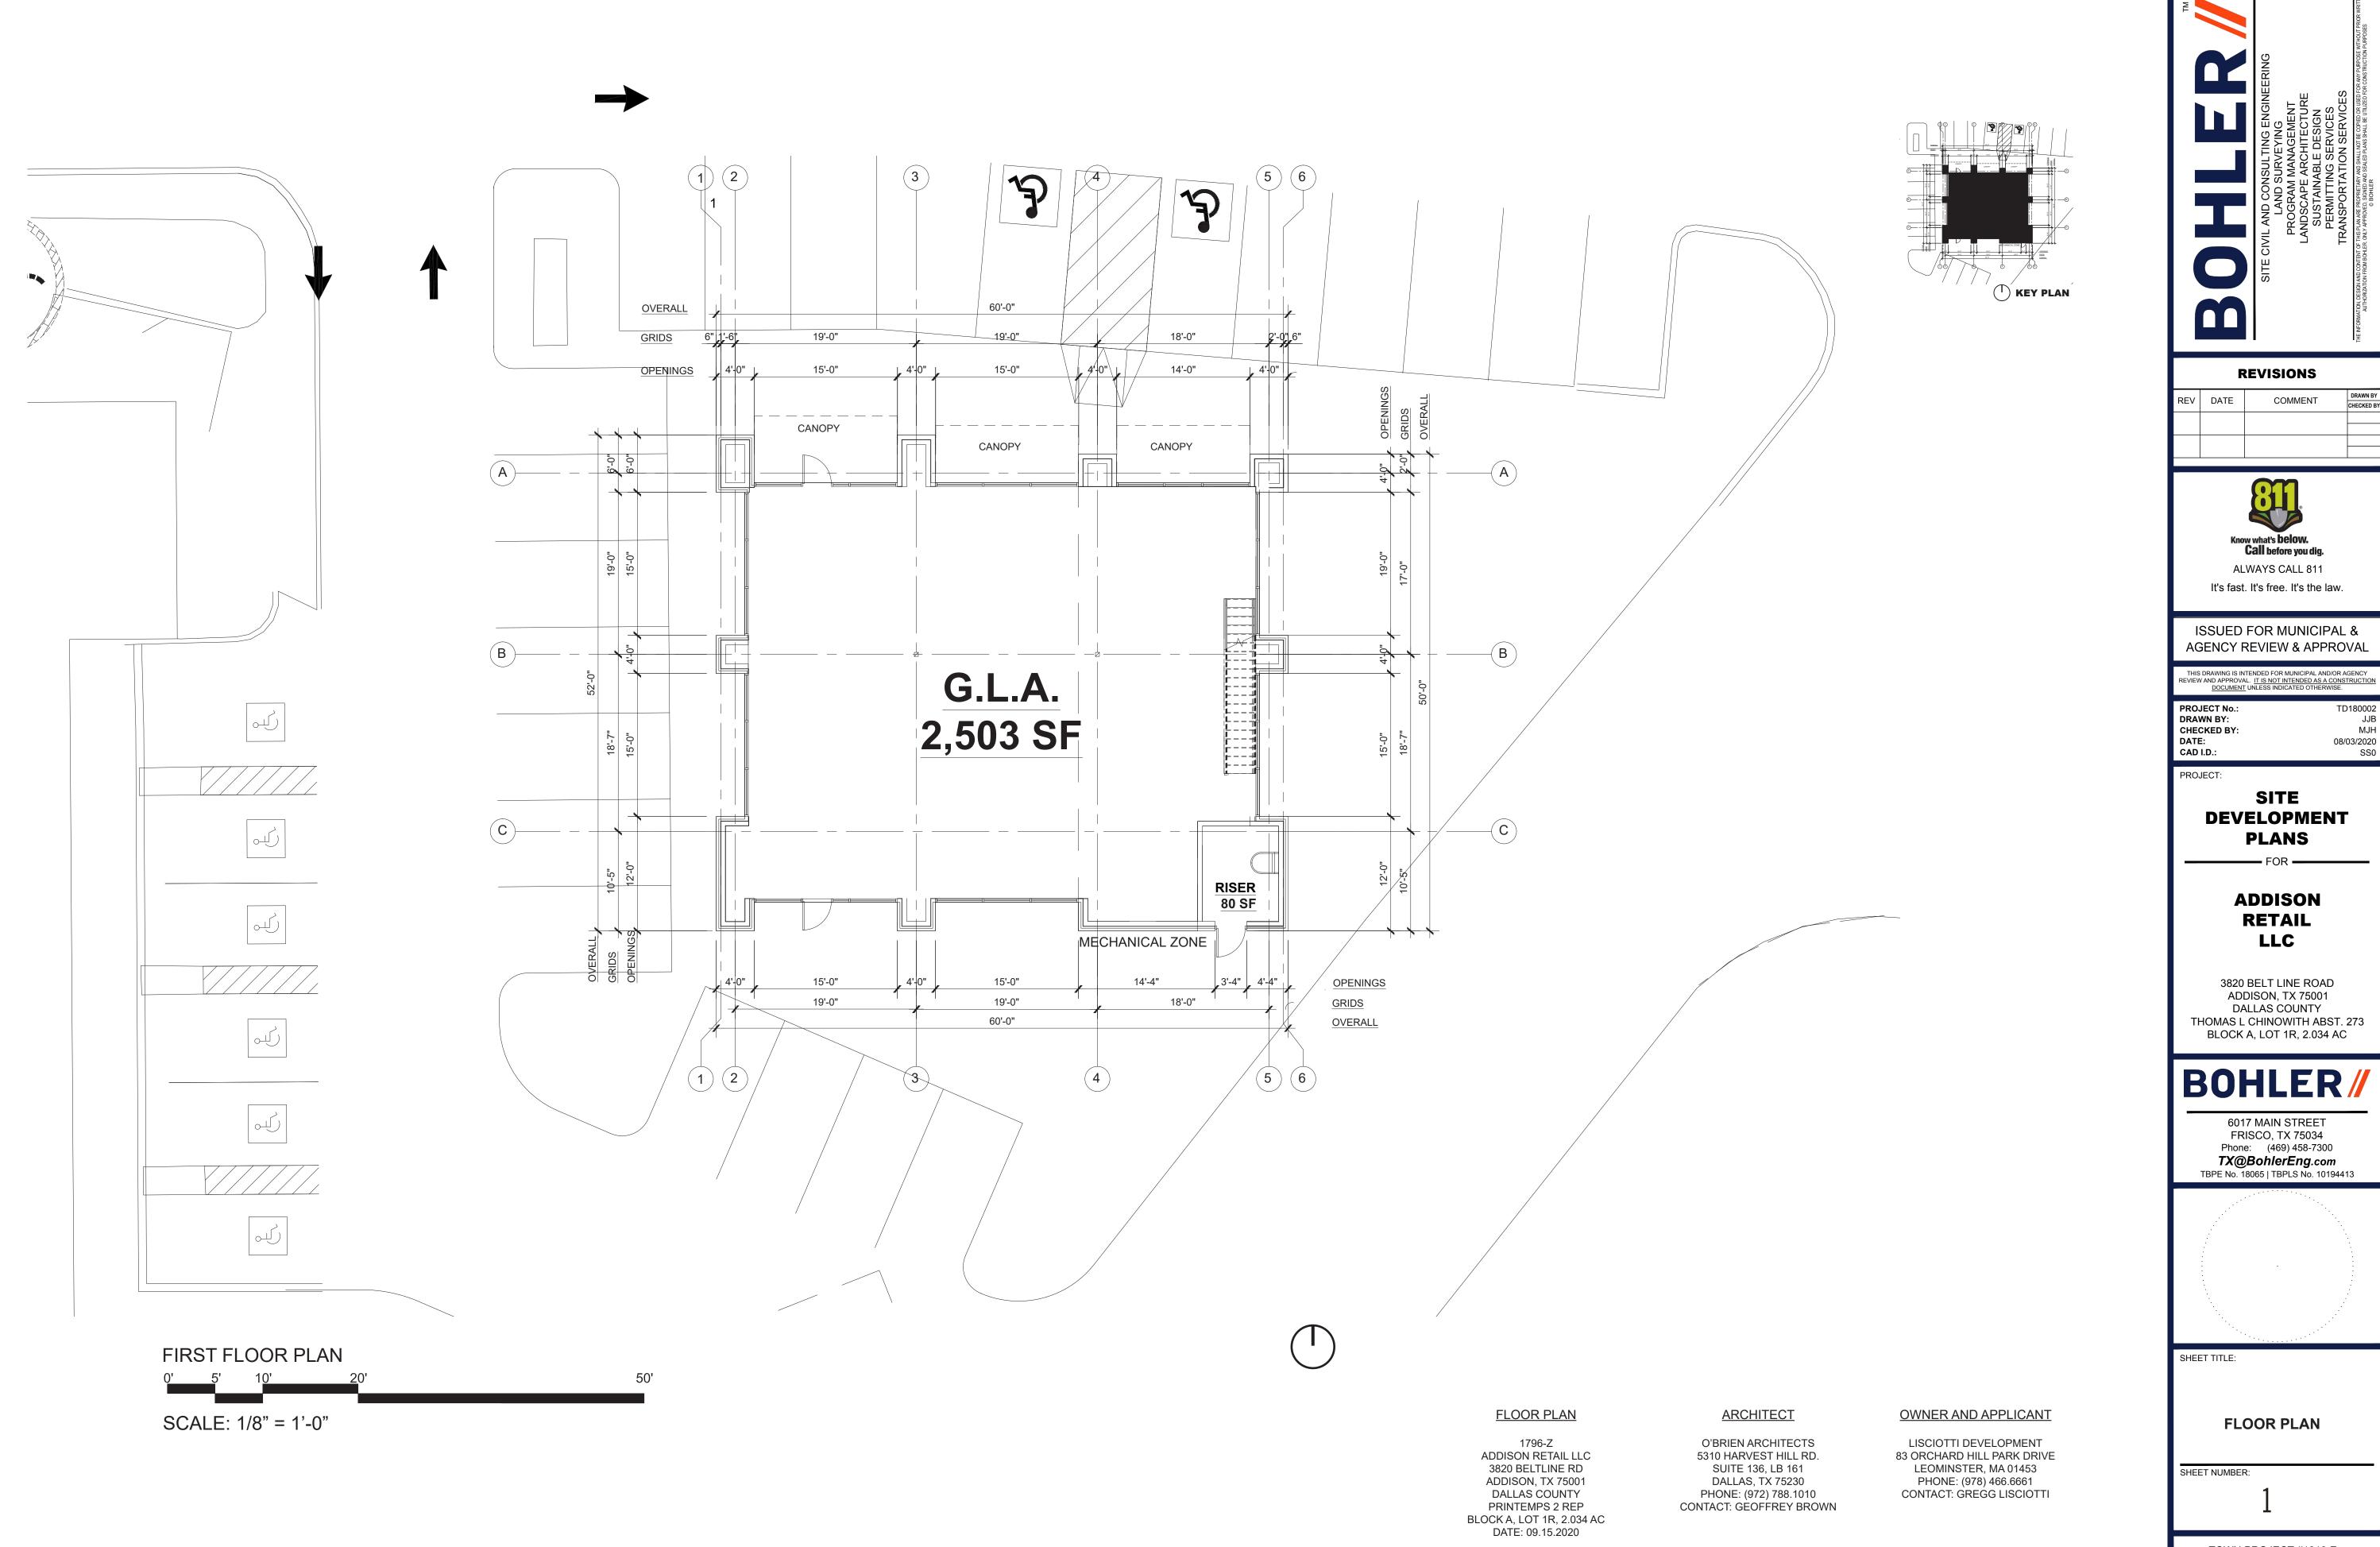

**REVISIONS** 

COMMENT



JJB MJH 08/03/2020 SS0


SITE **DEVELOPMENT** 

**ADDISON RETAIL** LLC


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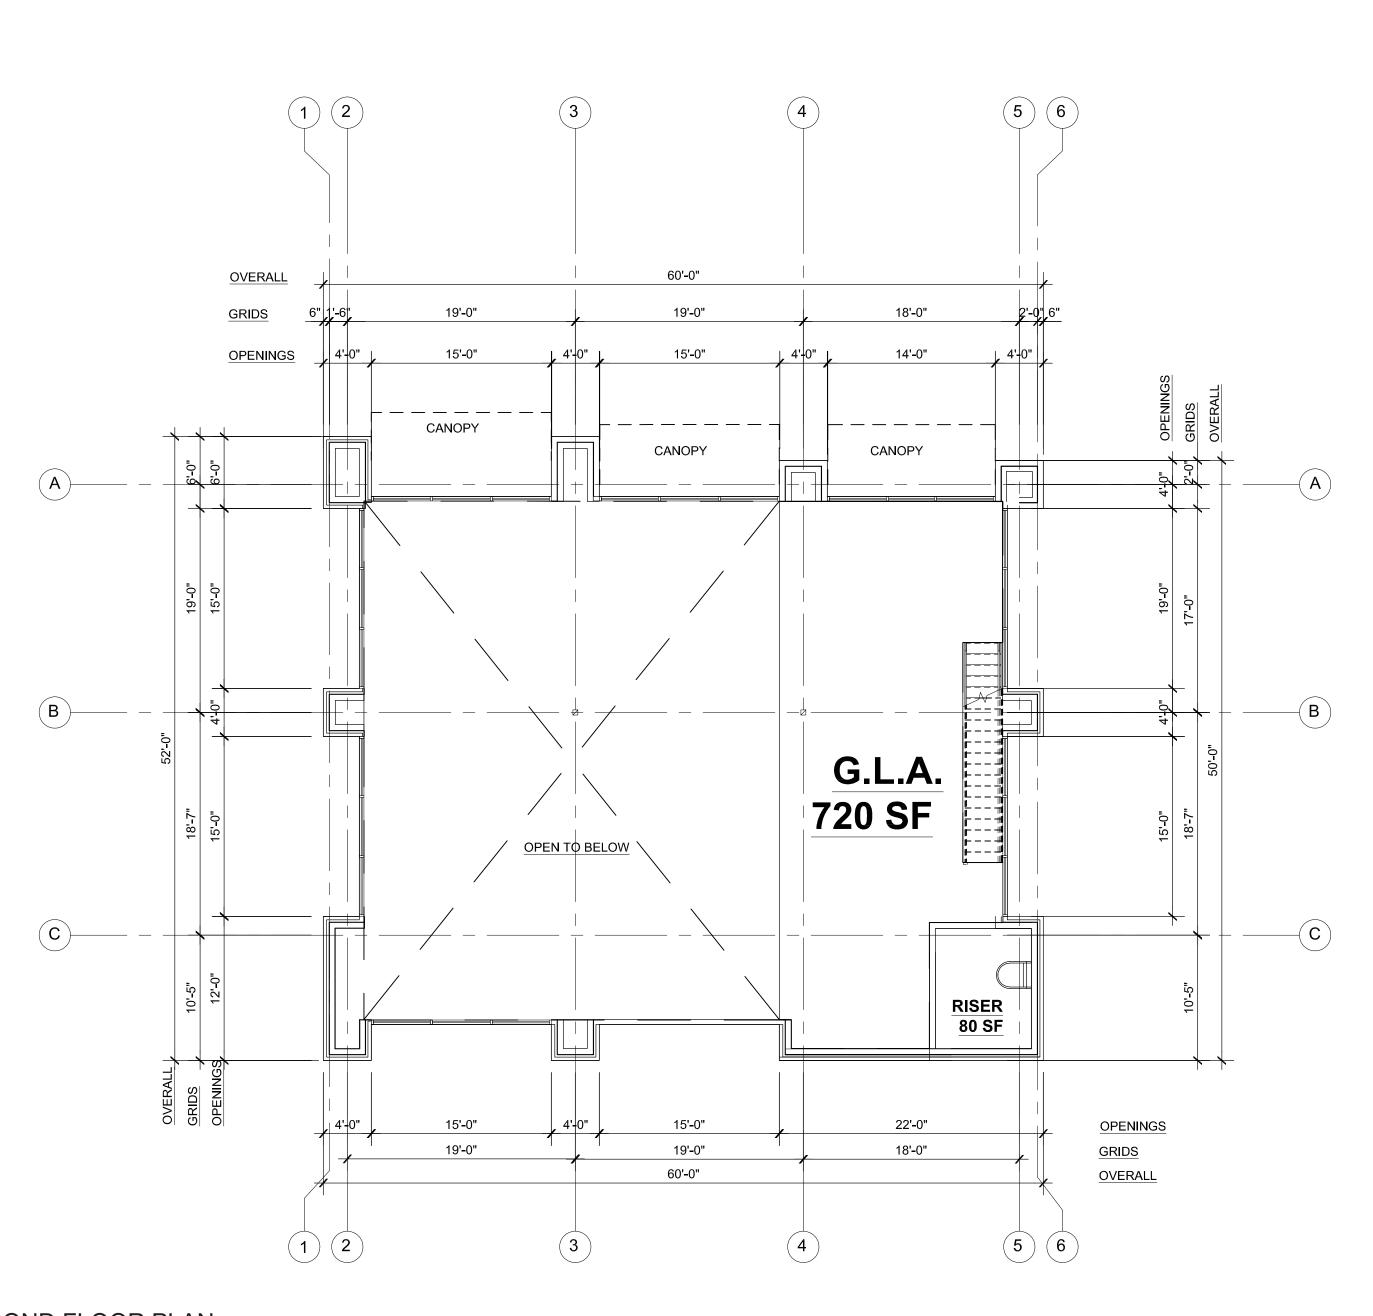
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**FLOOR PLAN** 



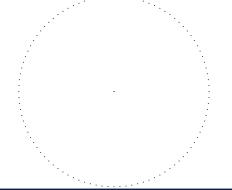

SECOND FLOOR PLAN

0' 5' 10' 20' 50'

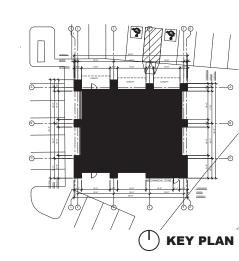SCALE: 1/8" = 1'-0"

FLOOR PLAN

1796-Z
ADDISON RETAIL LLC
3820 BELTLINE RD
ADDISON, TX 75001
DALLAS COUNTY
PRINTEMPS 2 REP
BLOCK A, LOT 1R, 2.034 AC
DATE: 09.15.2020

<u>ARCHITECT</u>

O'BRIEN ARCHITECTS 5310 HARVEST HILL RD. SUITE 136, LB 161 DALLAS, TX 75230 PHONE: (972) 788.1010 CONTACT: GEOFFREY BROWN **OWNER AND APPLICANT** 

LISCIOTTI DEVELOPMENT 83 ORCHARD HILL PARK DRIVE LEOMINSTER, MA 01453 PHONE: (978) 466.6661 CONTACT: GREGG LISCIOTTI



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PROJECT:

SITE DEVELOPMENT PLANS


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ADDISON RETAIL LLC

3820 BELT LINE ROAD ADDISON, TX 75001 DALLAS COUNTY THOMAS L CHINOWITH ABST. 273 BLOCK A, LOT 1R, 2.034 AC




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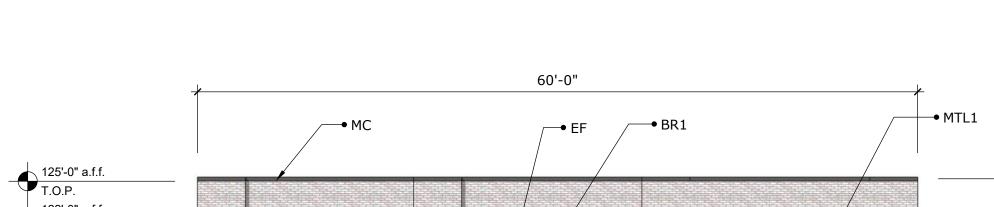



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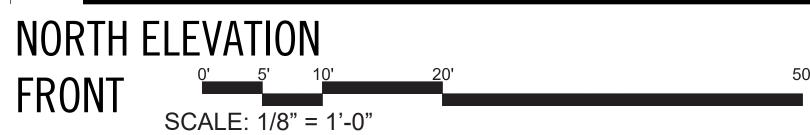
**FLOOR PLAN** 

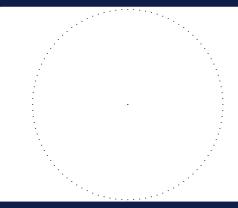
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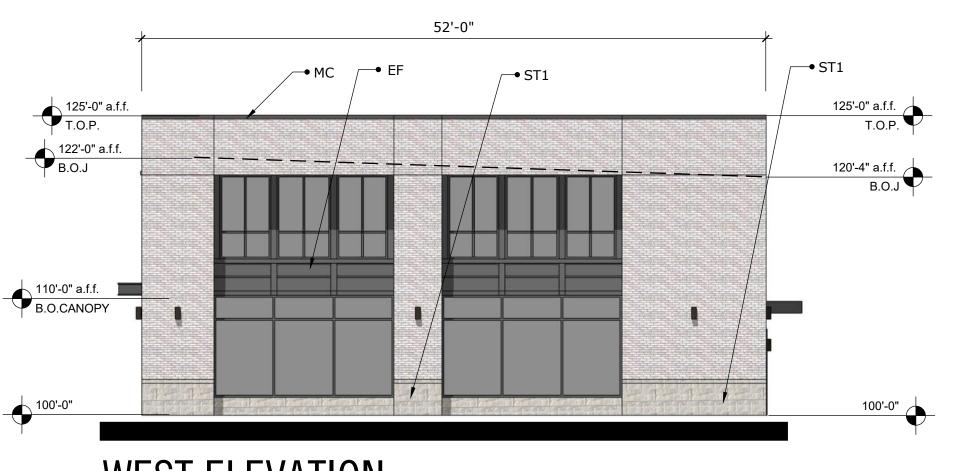






DUMPSTER ENCLOSURE

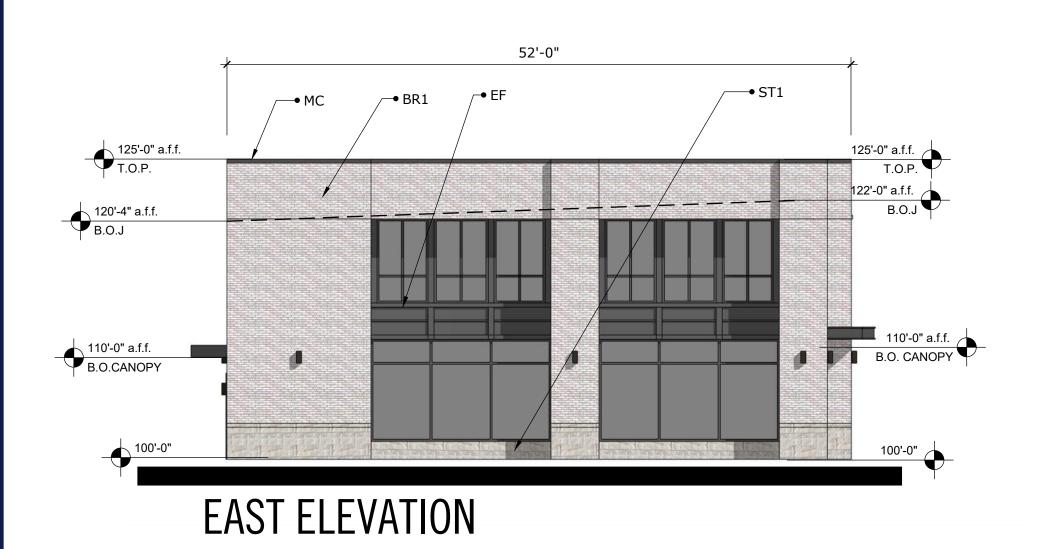 $SCAL\overline{E: 1/8}$ " = 1'-0"

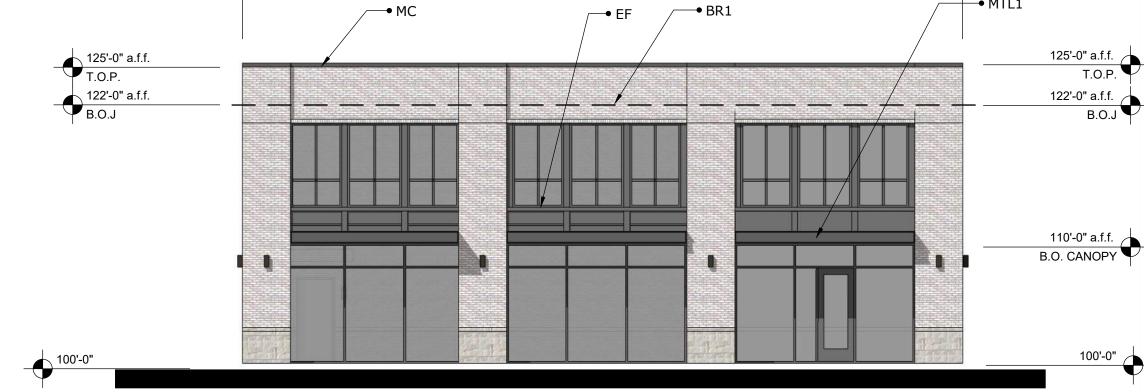SCALE: 1/8" = 1'-0"

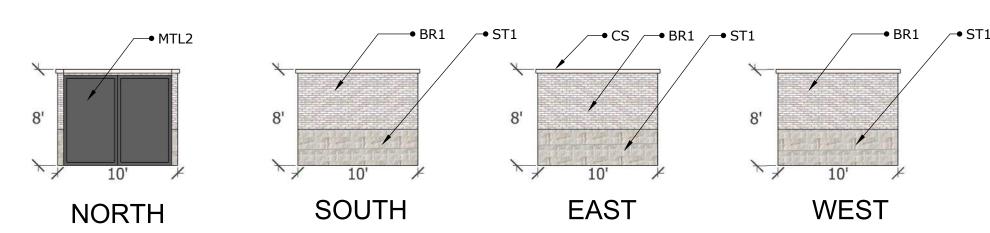

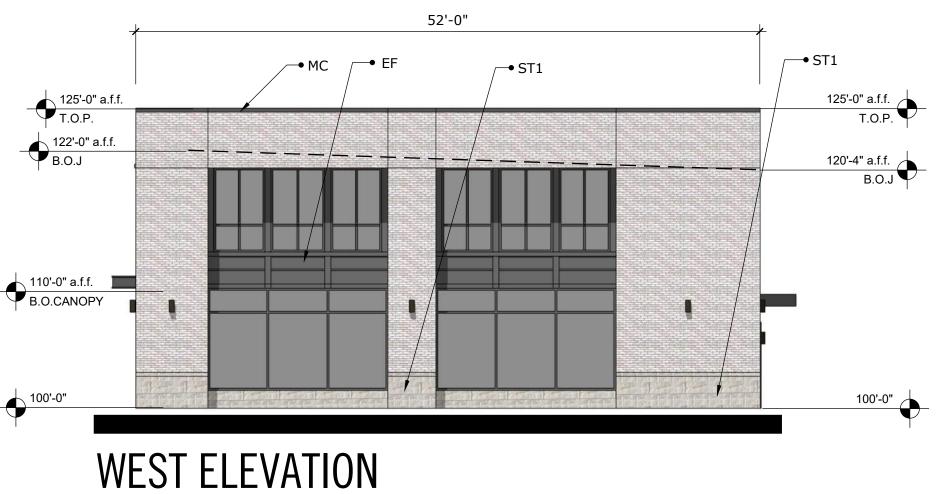

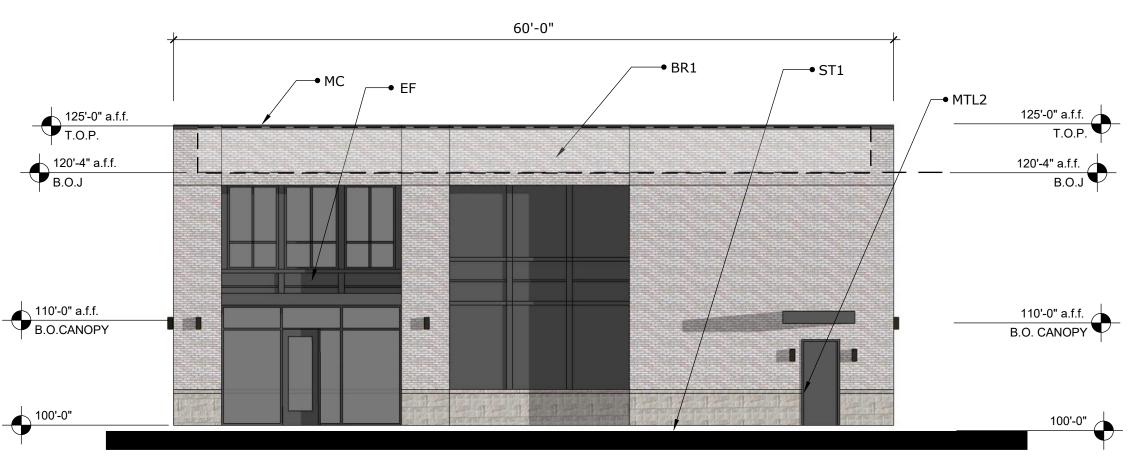

	NORTH	SOUTH	EAST	WEST
TOTAL SURFACE AREA SQ.FT. WITHOUT GLAZING	768	1,275	859	859
MATERIAL PERCENTAGES				
Channe on th	6%	10%	13%	13%
Stone sq.ft.	48	126	111	111
Brick sq.ft.	74%	63%	74%	74%
	568	800	639	639
Matal Assesses on St	8%	5%	2%	2%
Metal Accents sq. ft.	64	68     1,275     859       %     10%     13%       18     126     111       19     63%     74%       68     800     639       69     5%     2%       64     64     19       19     22%     10%       10     285     90       516     1,530     1,324       10%     35%	19	
FIFE taken and fa	11%	22%	10%	10%
EIFS trim sq.ft.	11% 22% 10%	90		
TOTAL SURFACE AREA SQ.FT. WITH GLAZING	1,516	1,530	1,324	1,324
Claring on ft	49%	17%	35%	35%
Glazing sq.ft.	748	255	465	465

SCALE: 1/8" = 1'-0"

- This Façade Plan is for conceptual purposes only. All building plans require review and approval by Development Services.
- All mechanical units shall be screened from public view as required by the Zoning Ordinance
- When permitted, exposed utility boxes and conduits shall be painted to match the building
- All signage areas and locations are subject to approval by Development Services Roof access shall be provided internally, unless otherwise permitted by the Chief Building Official

#### FACADE PLAN

1796-Z ADDISON RETAIL LLC 3820 BELTLINE RD ADDISON, TX 75001 DALLAS COUNTY PRINTEMPS 2 REP BLOCK A, LOT 1R, 2.034 AC DATE: 09.15.2020

#### 5. **BR1-** Brick

Proposed Finishes:

1. MC- Metal Coping:

2. MTL1- Flat Metal Canopy:

3. MTL2- Hollow Metal Door:

4. ST1- Manufactured stone:

6. CS- Cast Stone 7. **EF-** EIFS

8. **GL1-** Storefront Glass

(B) SW7067 Cityscape

9. Paint/Stucco: (A) SW7674 Peppercorn

### **ARCHITECT**

O'BRIEN ARCHITECTS 5310 HARVEST HILL RD. SUITE 136, LB 161 DALLAS, TX 75230 PHONE: (972) 788.1010 CONTACT: GEOFFREY BROWN

#### **MATERIAL LIST**

Berridge, PreWeathered Galvalume Painted: SW 7674 Peppercorn

Berridge, PreWeathered Galvalume Painted: SW 7674 Peppercorn

Hollow Metal Door

Painted: SW7067 Cityscape

Hill Country Limestone- Cream

Acme Brick- Rustic White- Velour

Stone: #1 - Coronado Stone Products

Enterprise Precast Concrete-Buff

Dryvit #616 King's Gray Vitro- Architectural Glass-Storefront

### OWNER AND APPLICANT

LISCIOTTI DEVELOPMENT 83 ORCHARD HILL PARK DRIVE LEOMINSTER, MA 01453 PHONE: (978) 466.6661 CONTACT: GREGG LISCIOTTI



KEY PLAN

REVISIONS				
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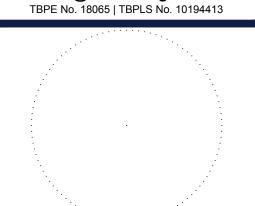
> SITE **DEVELOPMENT PLANS**

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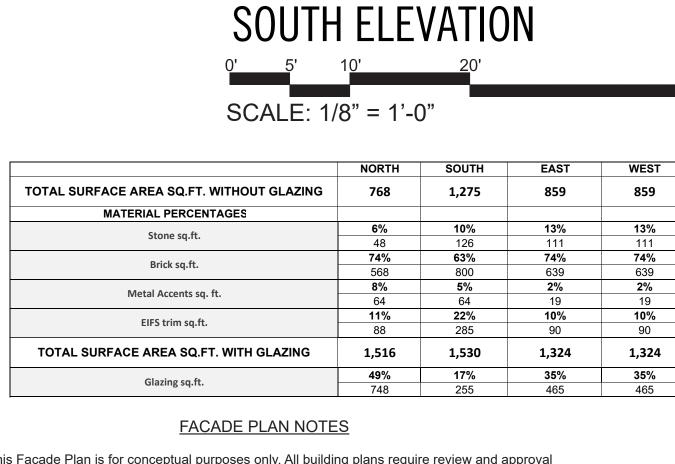
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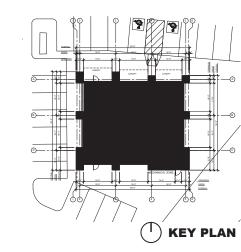


SHEET TITLE:

**FACADE PLAN** 

SHEET NUMBER:







NORTHWEST CORNER

FACADE PLAN

1796-Z ADDISON RETAIL LLC 3820 BELTLINE RD ADDISON, TX 75001 DALLAS COUNTY PRINTEMPS 2 REP BLOCK A, LOT 1R, 2.034 AC DATE: 09.15.2020

**ARCHITECT** 

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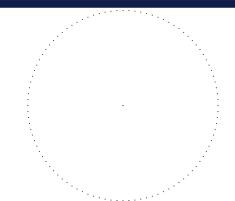
#### SITE **DEVELOPMENT PLANS**

#### **ADDISON RETAIL** LLC

3820 BELT LINE ROAD ADDISON, TX 75001 DALLAS COUNTY
THOMAS L CHINOWITH ABST. 273
BLOCK A, LOT 1R, 2.034 AC

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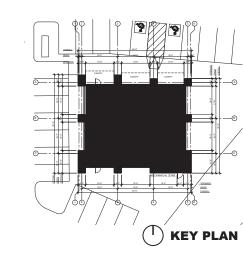


SHEET TITLE:

**BUILDING PERSPECTIVES** 

SHEET NUMBER:







NORTHEAST CORNER

FACADE PLAN

1796-Z ADDISON RETAIL LLC 3820 BELTLINE RD ADDISON, TX 75001 DALLAS COUNTY PRINTEMPS 2 REP BLOCK A, LOT 1R, 2.034 AC DATE: 09.15.2020 <u>ARCHITECT</u>

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PROJECT No.: DRAWN BY: CHECKED BY: DATE: CAD I.D.:

PROJECT:


#### SITE **DEVELOPMENT PLANS**

#### **ADDISON RETAIL** LLC

3820 BELT LINE ROAD
ADDISON, TX 75001
DALLAS COUNTY
THOMAS L CHINOWITH ABST. 273
BLOCK A, LOT 1R, 2.034 AC

### **BOHLER**//

6017 MAIN STREET FRISCO, TX 75034 Phone: (469) 458-7300 **TX@BohlerEng.com** TBPE No. 18065 | TBPLS No. 10194413

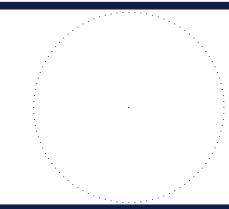

SHEET TITLE:

**BUILDING PERSPECTIVES** 

SHEET NUMBER: